



Lower Makefield Township, Bucks County PA						
ZONING CLASSIFICATION: $R-2$ — RESIDENTIAL MEDIUM DENSITY DISTRICT						
LOT # 1,	PARCEL NO. 20-	-042-278				
ITEM	REQUIRED	EXISTING	PROPOSED			
	4.05.00					
MIN. LOT AREA	1,6500 sf	23,900 sf				
EXISTING BUILDING AREA		1,815 sf	1,815 sf			
COVERED PORCH		169 sf	409 sf			
DRIVEWAY/WALKS/PATIO		2,097 sf	1,246 sf			
SHEDS		144 sf	300 sf			
PROPOSED ADDITION			813 sf			
TOTAL		4,248 sf	4,583 sf			
MAX IMPERVIOUS COVERAGE	18% (4,302 sf)	17.8%	19.17%			
FRONT YARD SETBACK	40 feet Min.	40 feet	40 feet			
SIDE YARD SETBACK	15 feet Min.	28.8 + 34.5 feet	28.8 + 10 feet			
REAR YARD SETBACK	50 feet Min.	114.2 feet	114.2 feet			

ZONING VARIANCES REQUIRED:

SIDE YARD SETBACK: Reduce from 15' to 10'
IMPERVIOUS COVERAGE: Increase from 17.8% to 19.17% (281 over allowable sf)

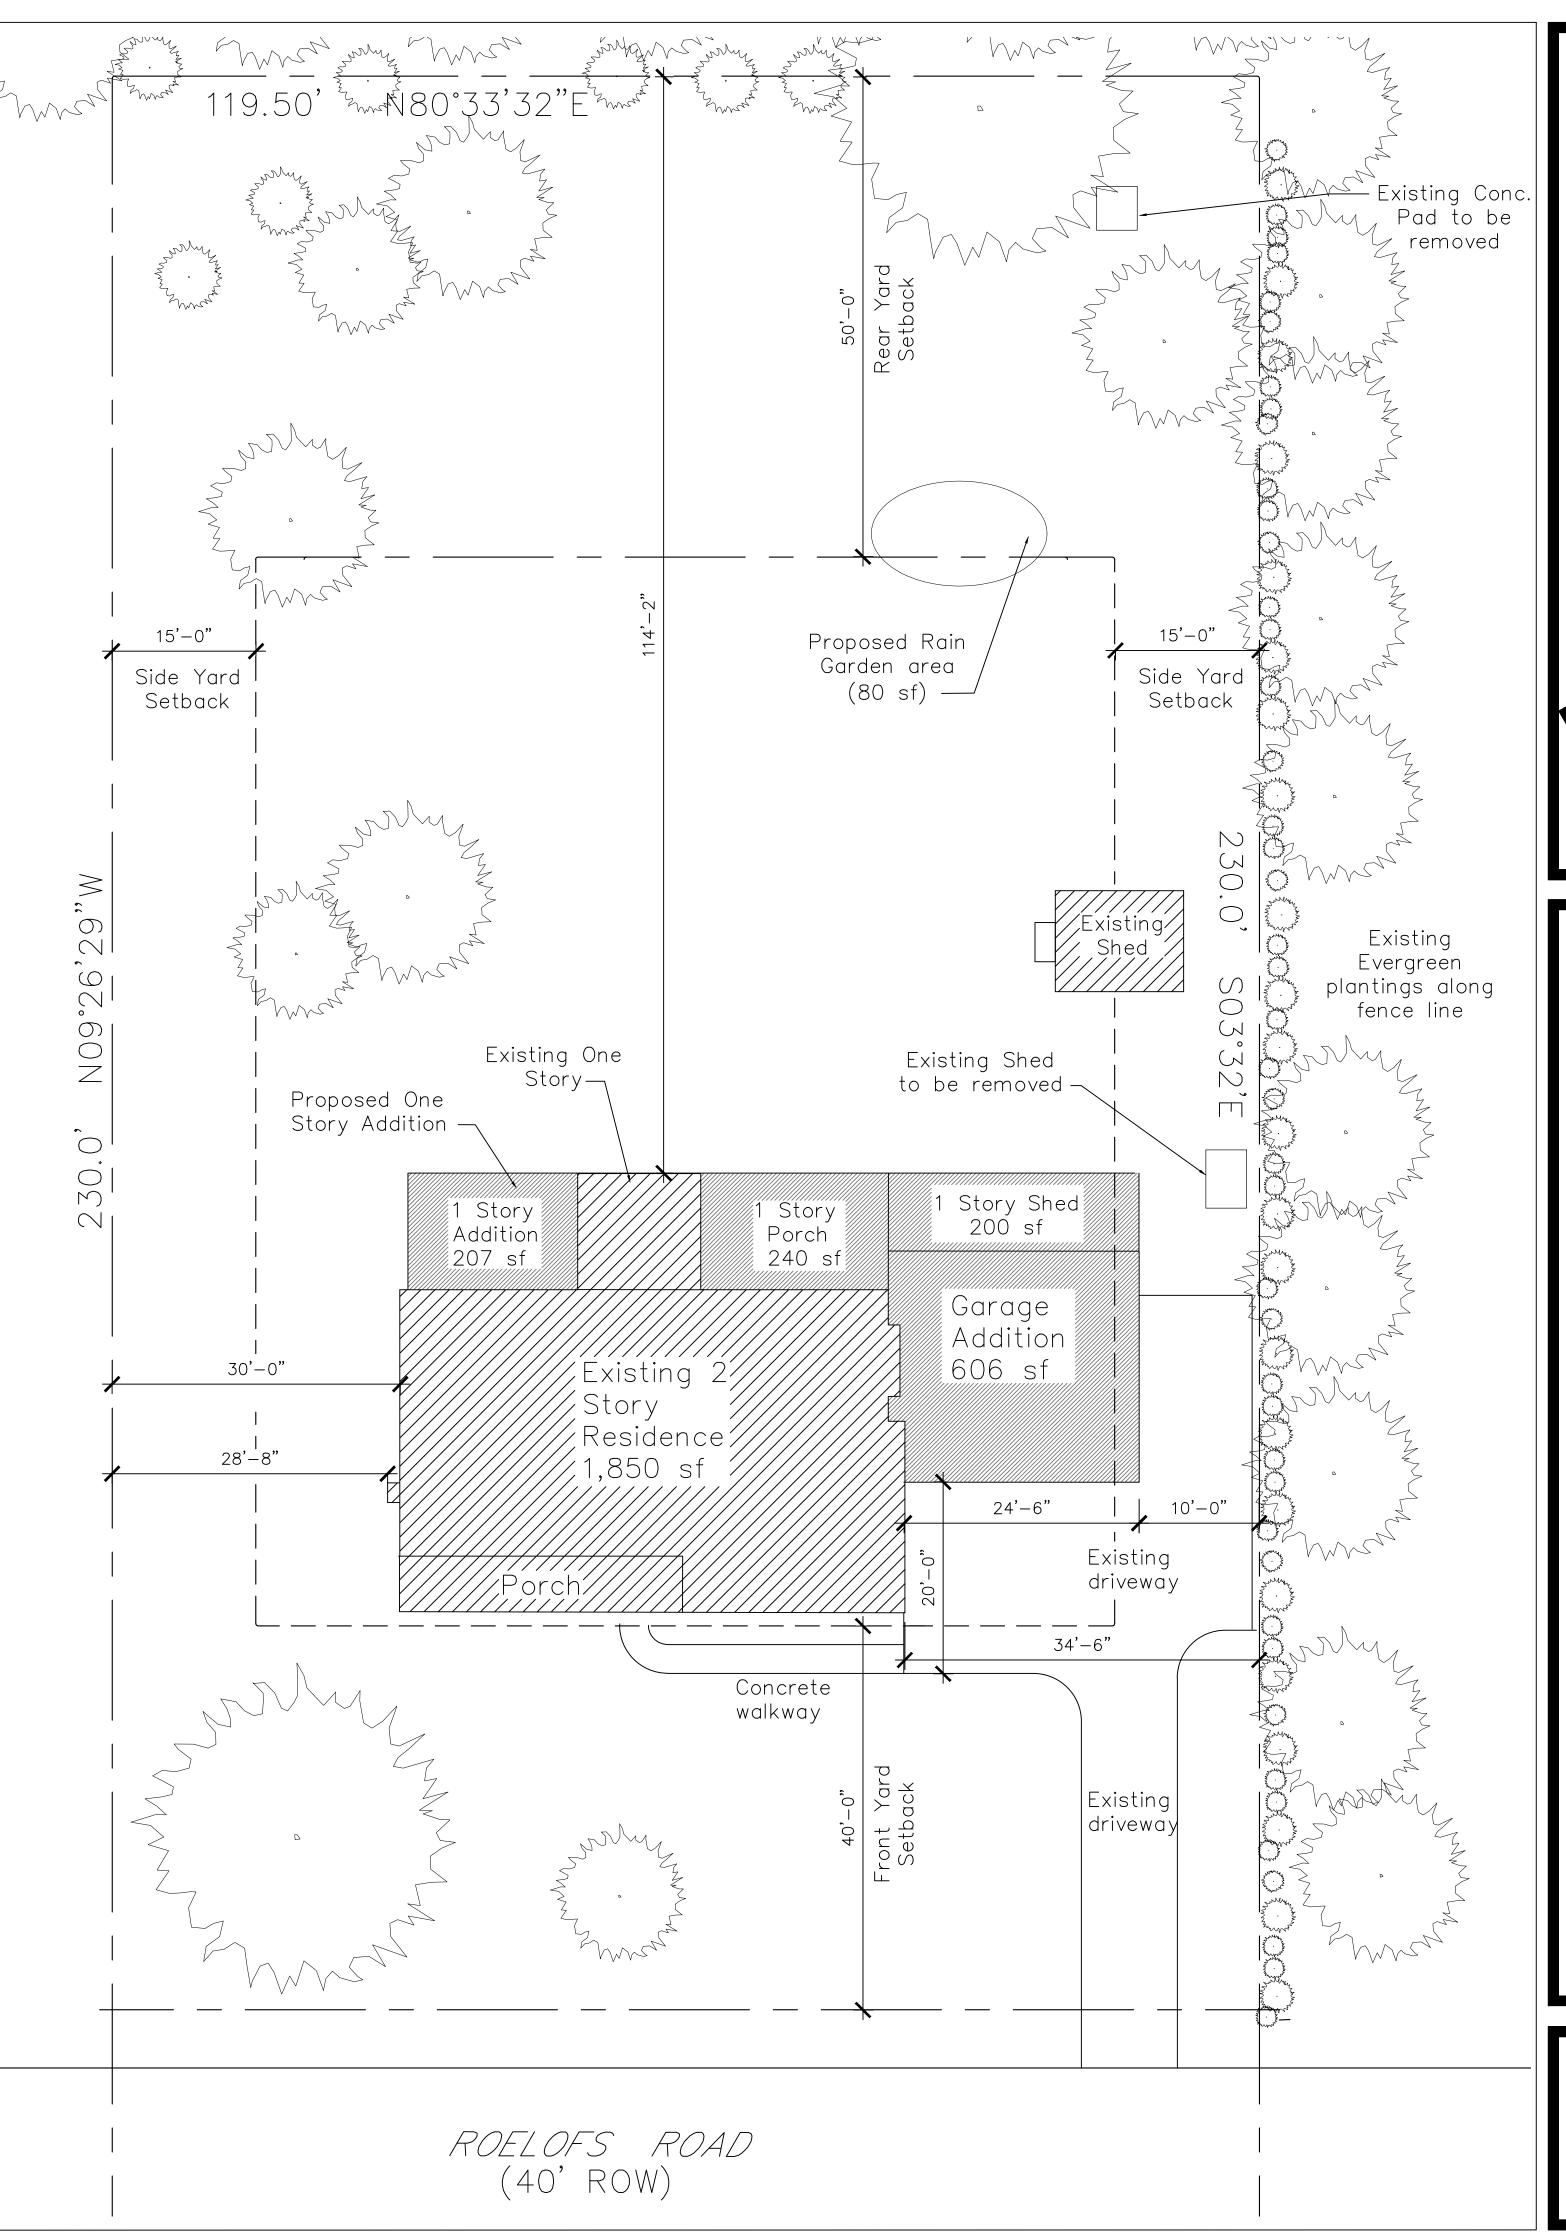



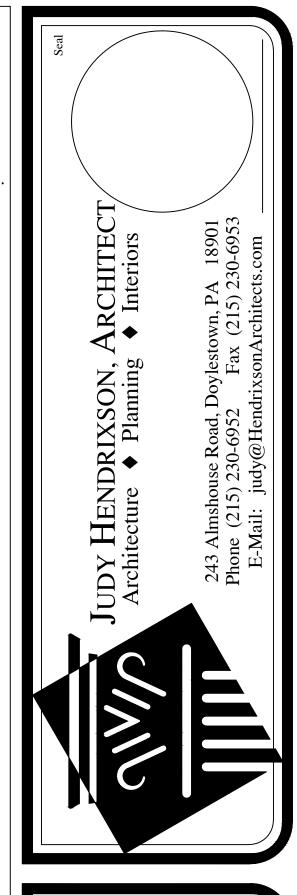

The Plews Residence
800 Roelofs Road
Yardley, PA 19067

DATE ISSUE/REV

EXISTING COND. 1/30/23


ZHB Submission: 9/8/23


DRAWN BY: JLH
SHEET TITLE:

Site Plan

SHEET NO.

SP
PROJECT NO.
DATE: Sept 8, 2023

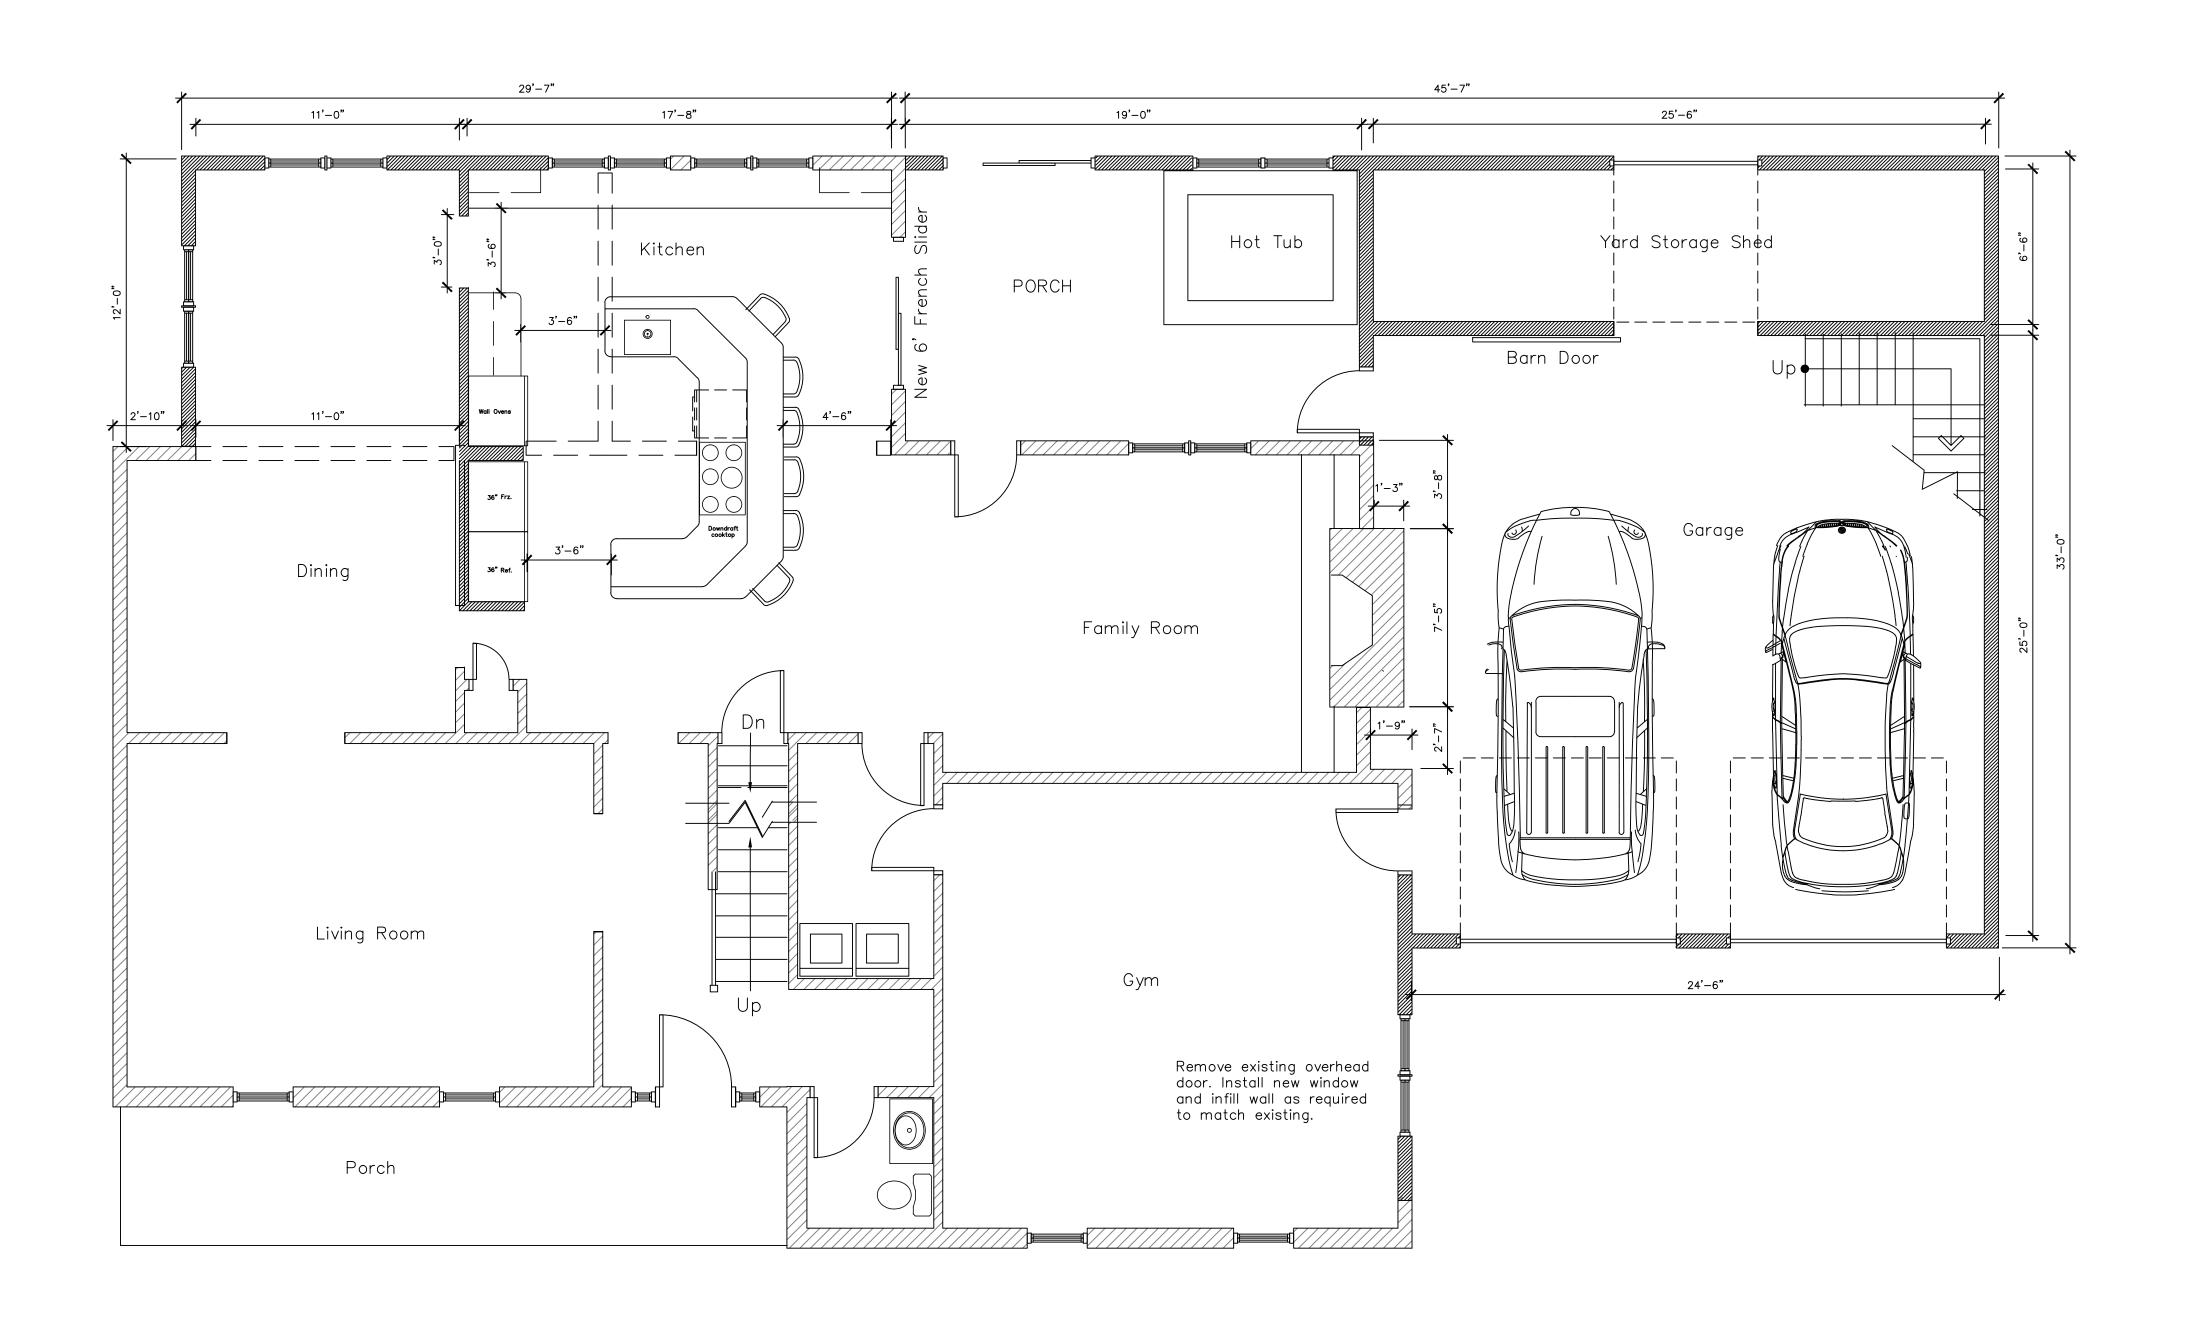

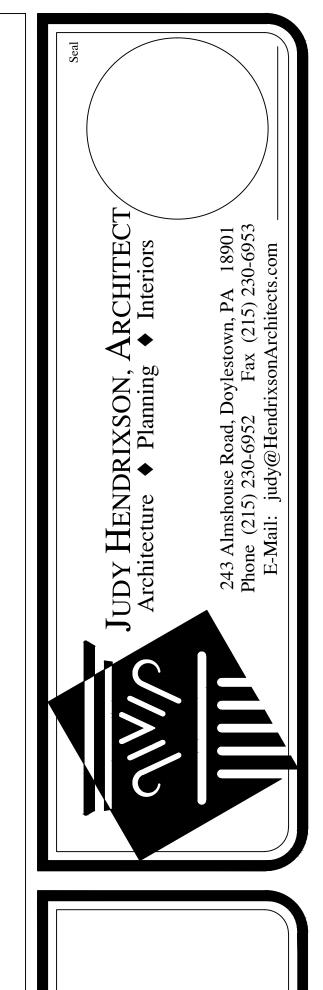

The Plews Residence 800 Roelofs Road Yardley, PA 19067

DATE ISSUE / REV

EXISTING COND. 2/2/23
ZHB Submission: 9/8/23

DRAWN BY: JLH
SHEET TITLE:

PROPOSED GROUND FLOOR PLAN

SHEET NO.

A-1

PROJECT NO.
DATE: Sept 8, 2023

CONTACT PERSONS

CONSTRUCTION INFORMATION

The Solebury Model



ABBREVIATIONS

ARCHITECTURAL SYMBOLS

277 24 2223 5333 2000 inve \times 1 • • temmi UIII 11/2 KS HUN XXX 1672 7

(2868)



UA-Je





DRAWING LIST

SPECIFICATION SHEET FOUNDATION FLAN FIRST FLOOR PLAN A-Z A-5 FRONT AND RIGHT ELEVATION BASEMENT ELECTRICAL LAYOUT FRST FLOORELECTRICAL LAYOUT F-2 PLUMBING LAYOUT

SOLIARE FOOTAGES

LOAD CALCULATIONS





Makefield Twp. PA 19067 #2 Big Oak Rd, 15 L Lower

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EQUIPMENT

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PA 1906 2 の教 Twp. <u>B</u> Makefield N # 7 Lower

A CONTROL OF THE PROPERTY OF T

• SECON STREET OF MARINANA

Commission of the ...

2000 2000 ACA TO SECRETARION OF THE

TABLE RACA 1 2/11 MINIMUM HORIZONTAL REINFORCEMENT FOR CONCRETE BASEMENT WALLS LOGATION OF HORIZONTAL REINFORCEMENT

3" DIA PERF PVC INTERIOR DRAIN DISCHARGED TO SUMP (TYP.) 151-8} 9-91 MSH 10" THICK POURED CONC. FND WALL ON 8"x20" CONT. CONC. FTG. (1YP.) 7.8 NOTE: FSK R-II BLANNET INSULATION (INSTALL FULL HEIGHT AT ALL EXTERIOR FOUNDATION WALLS) BASEMENT 4" CONC SLAB ON 8 MR VAPOR BARRIER OVER 6" CRUSHED STONE 33.4 5'-8" 9'-112" 10.-0].. F 7 7 D w8.18 23'-8" 3'-0" 4-1-0-1-44 FOUNDATION WALLS TO COMPLY W/ 2018 RC TABLES R-421-1219 AND R-1001-1219 CONTINUUS FOOTING TO COMPLY W/ 2018 RC TABLE R-4021 TURN DN SLAS UNEXCAVATED UNEXCAVATED

1º CONC. SLAB OVER
1º CRUSHED STONE ON 1
ML VARCE BARRIER

FOUNDATION PLAN

SCALE: 1/4" = 1'-0"






Twp, PA 1906 2 <u>8</u> Lot #2 Big Lower Makefield



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FIRST FLOOR PLAN
5CALE: 1/4" = 1'-0"




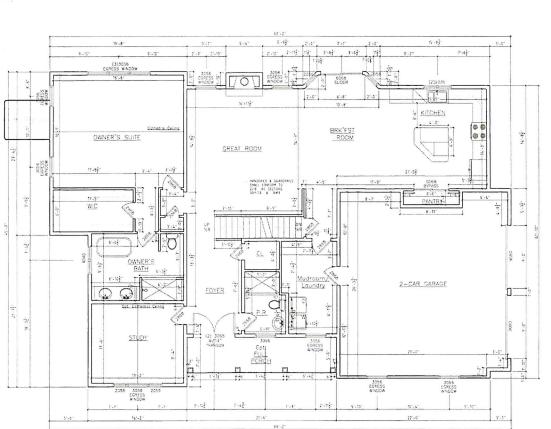

Lower Makefield Twp, PA 19067 Lot #2 Big Oak Rd

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 Work \$855000.3 - 2377 to 4/C)

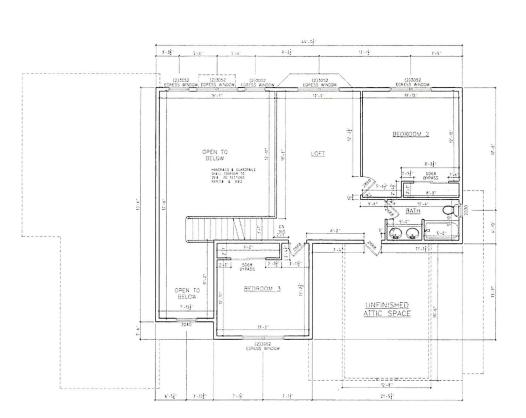

SECOND FLOOR PLAN


SCALE: 1/4" = 1'-0"





Lower Makefield Twp, PA 19067 Lot #2 Big Oak Rd,



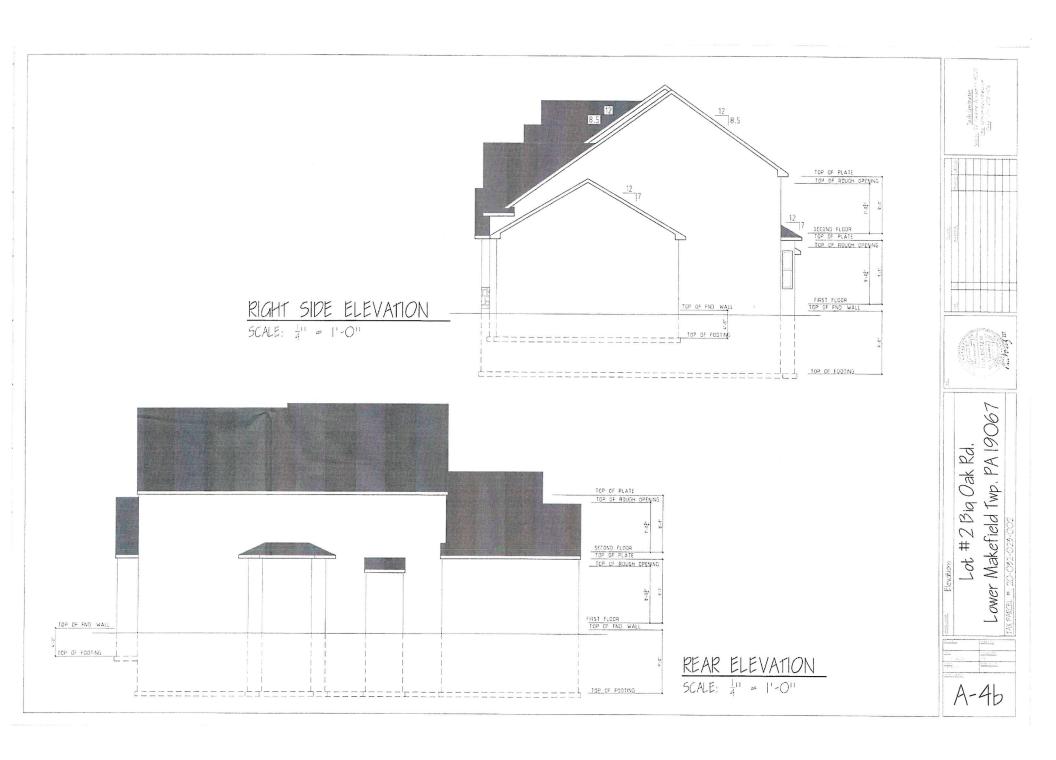




- 1) ALL FRAMING LUMBER TO BE # 2 OF SECTER
- 2.) JOIST SPANS GREATER THAN 8"-O" TO RECEIVE BRIDGING AT MID-SPAN JOIST SPANS GREATER THAN 12"-O" TO RECEIVE BRIDGING AT THRO-SPANS
- B) ALL WINDOW AND EXTERIOR DOOR HEADERS ARE (2) 240's W/ -" PLYWOOD IN BETWEEN LALESS OTHERWISE NOTED
- 4.0 START PLYWOOD LAYOUT FROM PEAR
- 5) ROOF TRUSSES AND LAYOUT TO BE SUPPLIED AND ENGINEERED BY 1PUSS WANUFACTURER
- 6.) ALL POSTS APE (5) 2x4 & UNLESS OTHERWISE NOTED
- 7.) BUILDER TO VERFY SPECIFICATIONS FOR ALL ENGINEERED LUMBER TO MEET APPLICABLE LOAD REQUIREMENTS IN COMPLIANCE WITH 2018 IRC.
- 8.) SIGNED AND SEALED SHOP DRAWINGS FOR ALL ENGINEERED LUMBER PRODUCTS TO BE PROVIDED

LEGEND OF SYMBOLS:

F===

OVERFRAMED AREAS

PLUMBING FIXTURES (ABOVE)

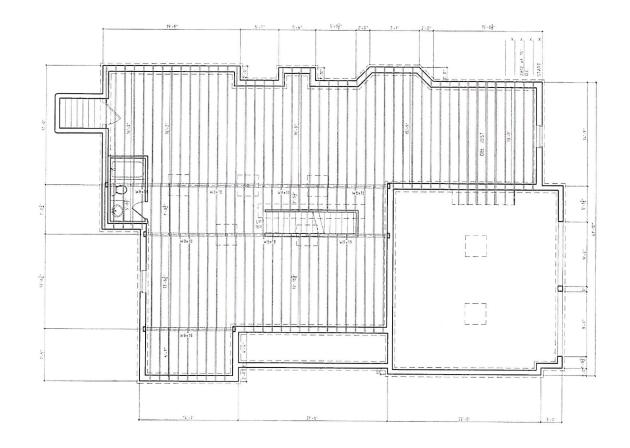


FIRST FLOOR FRAMING PLAN


SCALE: 1/4" = 1'-0"

Twp. PA 1906 9 8 Ba Lower Makefield #2 10 10



- L) ALL FRAMING LUMBER 10 BE # 2 OF
- 2) JOIST SPANS GREATER THAN 8'-O" TO RECEIVE BRIDGING AT MID-SPAN JOIST SPANS GREATER THAN 12"-O" TO RECEIVE BRIDGING AT THIPP-SPANS
- 50 ALL WINDOW AND EXTERIOR DOOR HEADERS ARE (2) 2x10's W/ 7" PLYWOOD IN BETWEEN UNLESS OFFERWISE
- 4.) STAPT PLYWOOD LAYOUT FROM REAR.
- SUPPLIED AND ENGINEERED BY TRUSS MANUFACTURER
- 6.) ALL POSTS APE. (3) Zx4's UNLESS
- 7.) BUILDER TO VERFY SPECIFICATIONS FOR ALL ENGINEERED LUMBER TO MEET APPLICABLE LOAD REQUEEMENTS IN COMPLIANCE WITH 2018 IRC.
- 8) SIGNED AND SEALED SHOP DRAWINGS FOR ALL ENGINEERED LUMBER PRODUCTS TO BE PROVIDED.

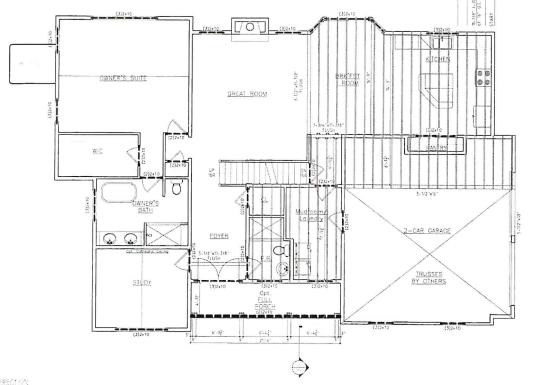

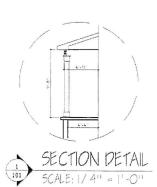



Makefield Twp, PA 19067 Big Oak Rd.

Lower

#2

Lot Lot

LEGEND OF SYMBOLS

DENOTED FLOOR JOIST DIRECTION

DENOTES EXTENT OF PLOOP JOISTS

START OF PLYWOOD LAYOUT

PLUMBING FIXTURES (ABOVE)

OVERFRAMED AREAS

Wall Bracing: Per IRC 2018 Table R602.10.4 "Let-In-Bracina"

		TABLE R602 10	4 BRACING METHODS		
METHODS, MATE	RIA	MINIMUM THICKNESS FIGU	FIGURE	CONNECTION CRITERIA*	
	MINIMOM I		FIGURE	Fasteners	Spacing
	LIB Let-in-bracing	1 • 4 wood or approved metal straps at 45° to 50° angles for	ST 91	Wood 2-8d common nails or 3-8d (2 ⁴ 5' king x 6 113' dia i nails	Wood per stud and top and bottom plates
	maximum 16° stud spacing	mannani,	Mela strap per manufacturer	Metal per manufactur	

SECOND FLOOR FRAMING PLAN
5CALE: 1/4" = 1'-0"

FRAMING NOTES:

- .) ALL PRAMING LUMBER 10 BE # 2 OF
- 2.) JOIST SPANS GREATER THAN 8"-0" TO RECEIVE BRIDGING AT MID-SPAN _0151 SPANS GREATER THAN 12"-O" TO RECEIVE BRIDGING AT THEIR-SPANS
- 5D ALL WINDOW AND EXTERIOR DOOR HEADERS ARE (2) 260's W/ +" PLYWOOD ALBETWEEN UNLESS OTHERWISE
- 4.) START PLYWOOD LAYOUT PROMIREAR.
- 5.) ROOF TRUSSES AND LAYOUT TO BE SUPPLIED AND ENGINEERED BY TRUSS
- 6) ALL POSTS APE (5) 2,4 s UNLESS OTHERWISE NOTES
- 7.) DULDER TO VERIFY SPECIFICATIONS FOR ALL ENGINEERED LUMBER TO MEET APPLICABLE LOAD REQUIREMENTS N COMPLIANCE WITH 2018 IRC
- 5.) SIGNED AND SEALED SHOP DRAWINGS

LEGEND OF SYMBOLS:

DENOTED FLOOR JOIST DIRECTION DENOTES EXTENT OF FLOOR JOISTS START OF PLYWOOD LAYOUT PLUMBING FIXTURES (ABOVE) OVERFRAMED AREAS

7/12 7/12 (3)2×10 7/12 8.5/12 8.5/12 7/12 7/12 7/12 8.5/12 8.5/12 10/12 10/12 7/12 10/12 10/12 10/12 10/12 4/12


ROOF PLAN

SCALE: 1/4" = 1'-0"





Twp. PA 1906 Oak Rd. #2 Big (Lower Makefield 15 1

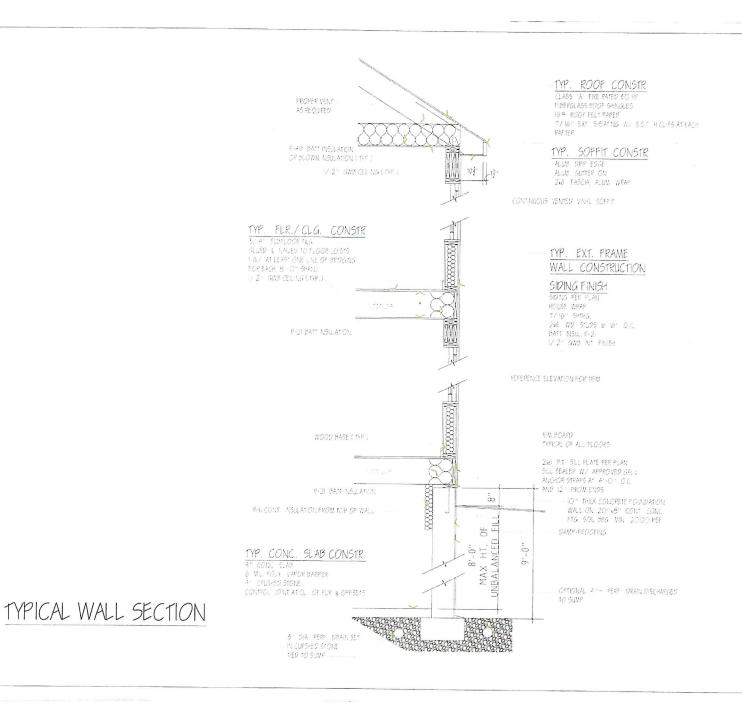

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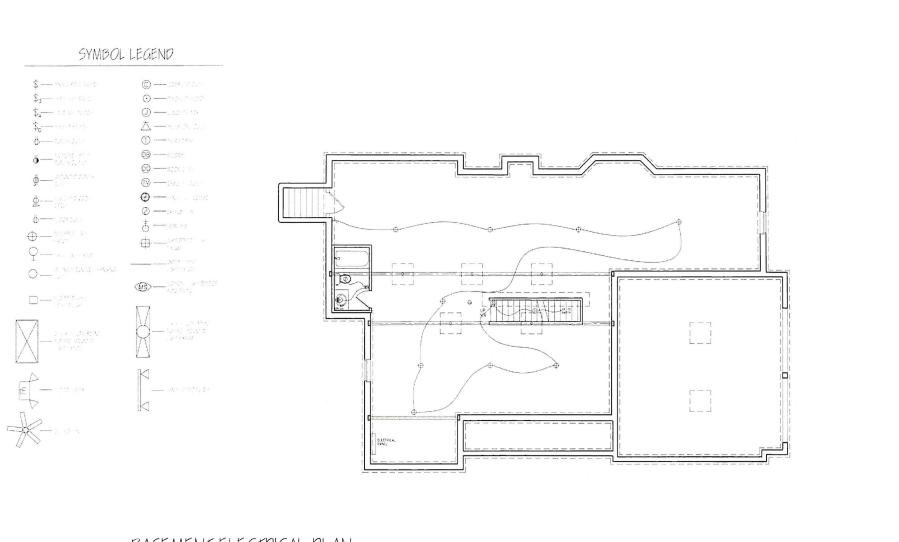




Lot #2 Big Oak Rd, Lower Makefield Twp. PA 19067


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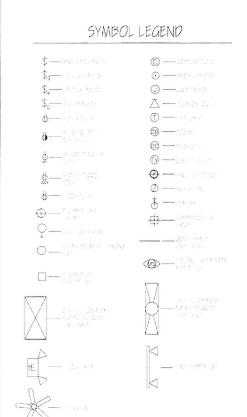
BASEMENT ELECTRICAL PLAN


Lot #2 Big Oak Rd, Lower Makefield Twp, PA 19067



FIRST FLOOR ELECTRICAL PLAN



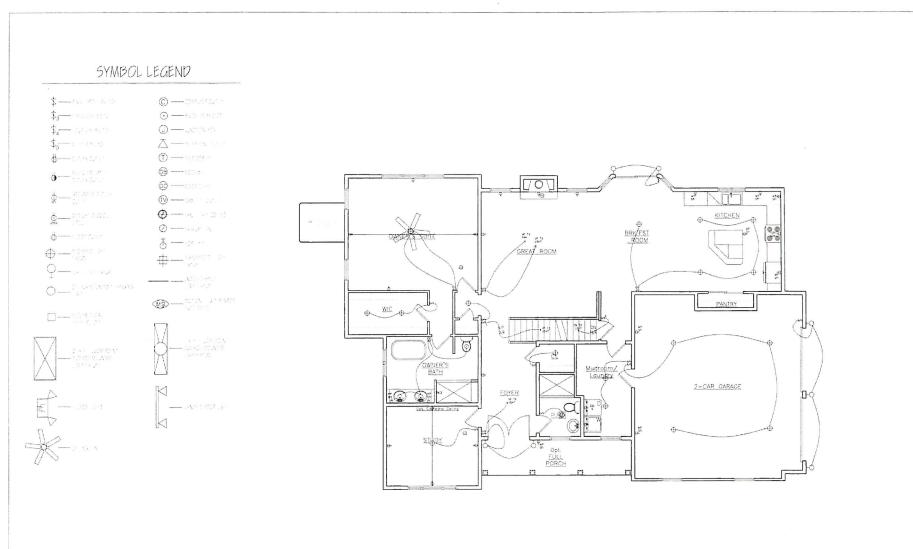

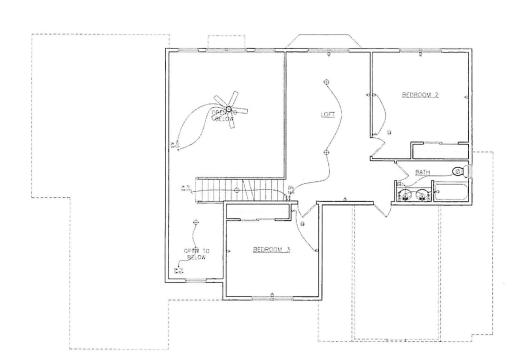

SECOND FLOOR ELECTRICAL PLAN

To Si Operation
Away 27 Statement Statement POSSO
Last Well-managed on the Sales (2019) 458






Lot #2 Big Oak Rd, Makefield Twp, PA 19067

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E-3

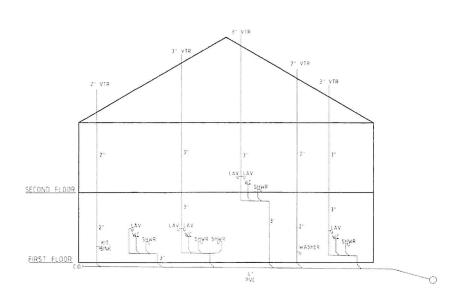



PLUMBING LAYOUT





Lower Makefield Twp, PA 19067 Lot #2 Big Oak Rd.

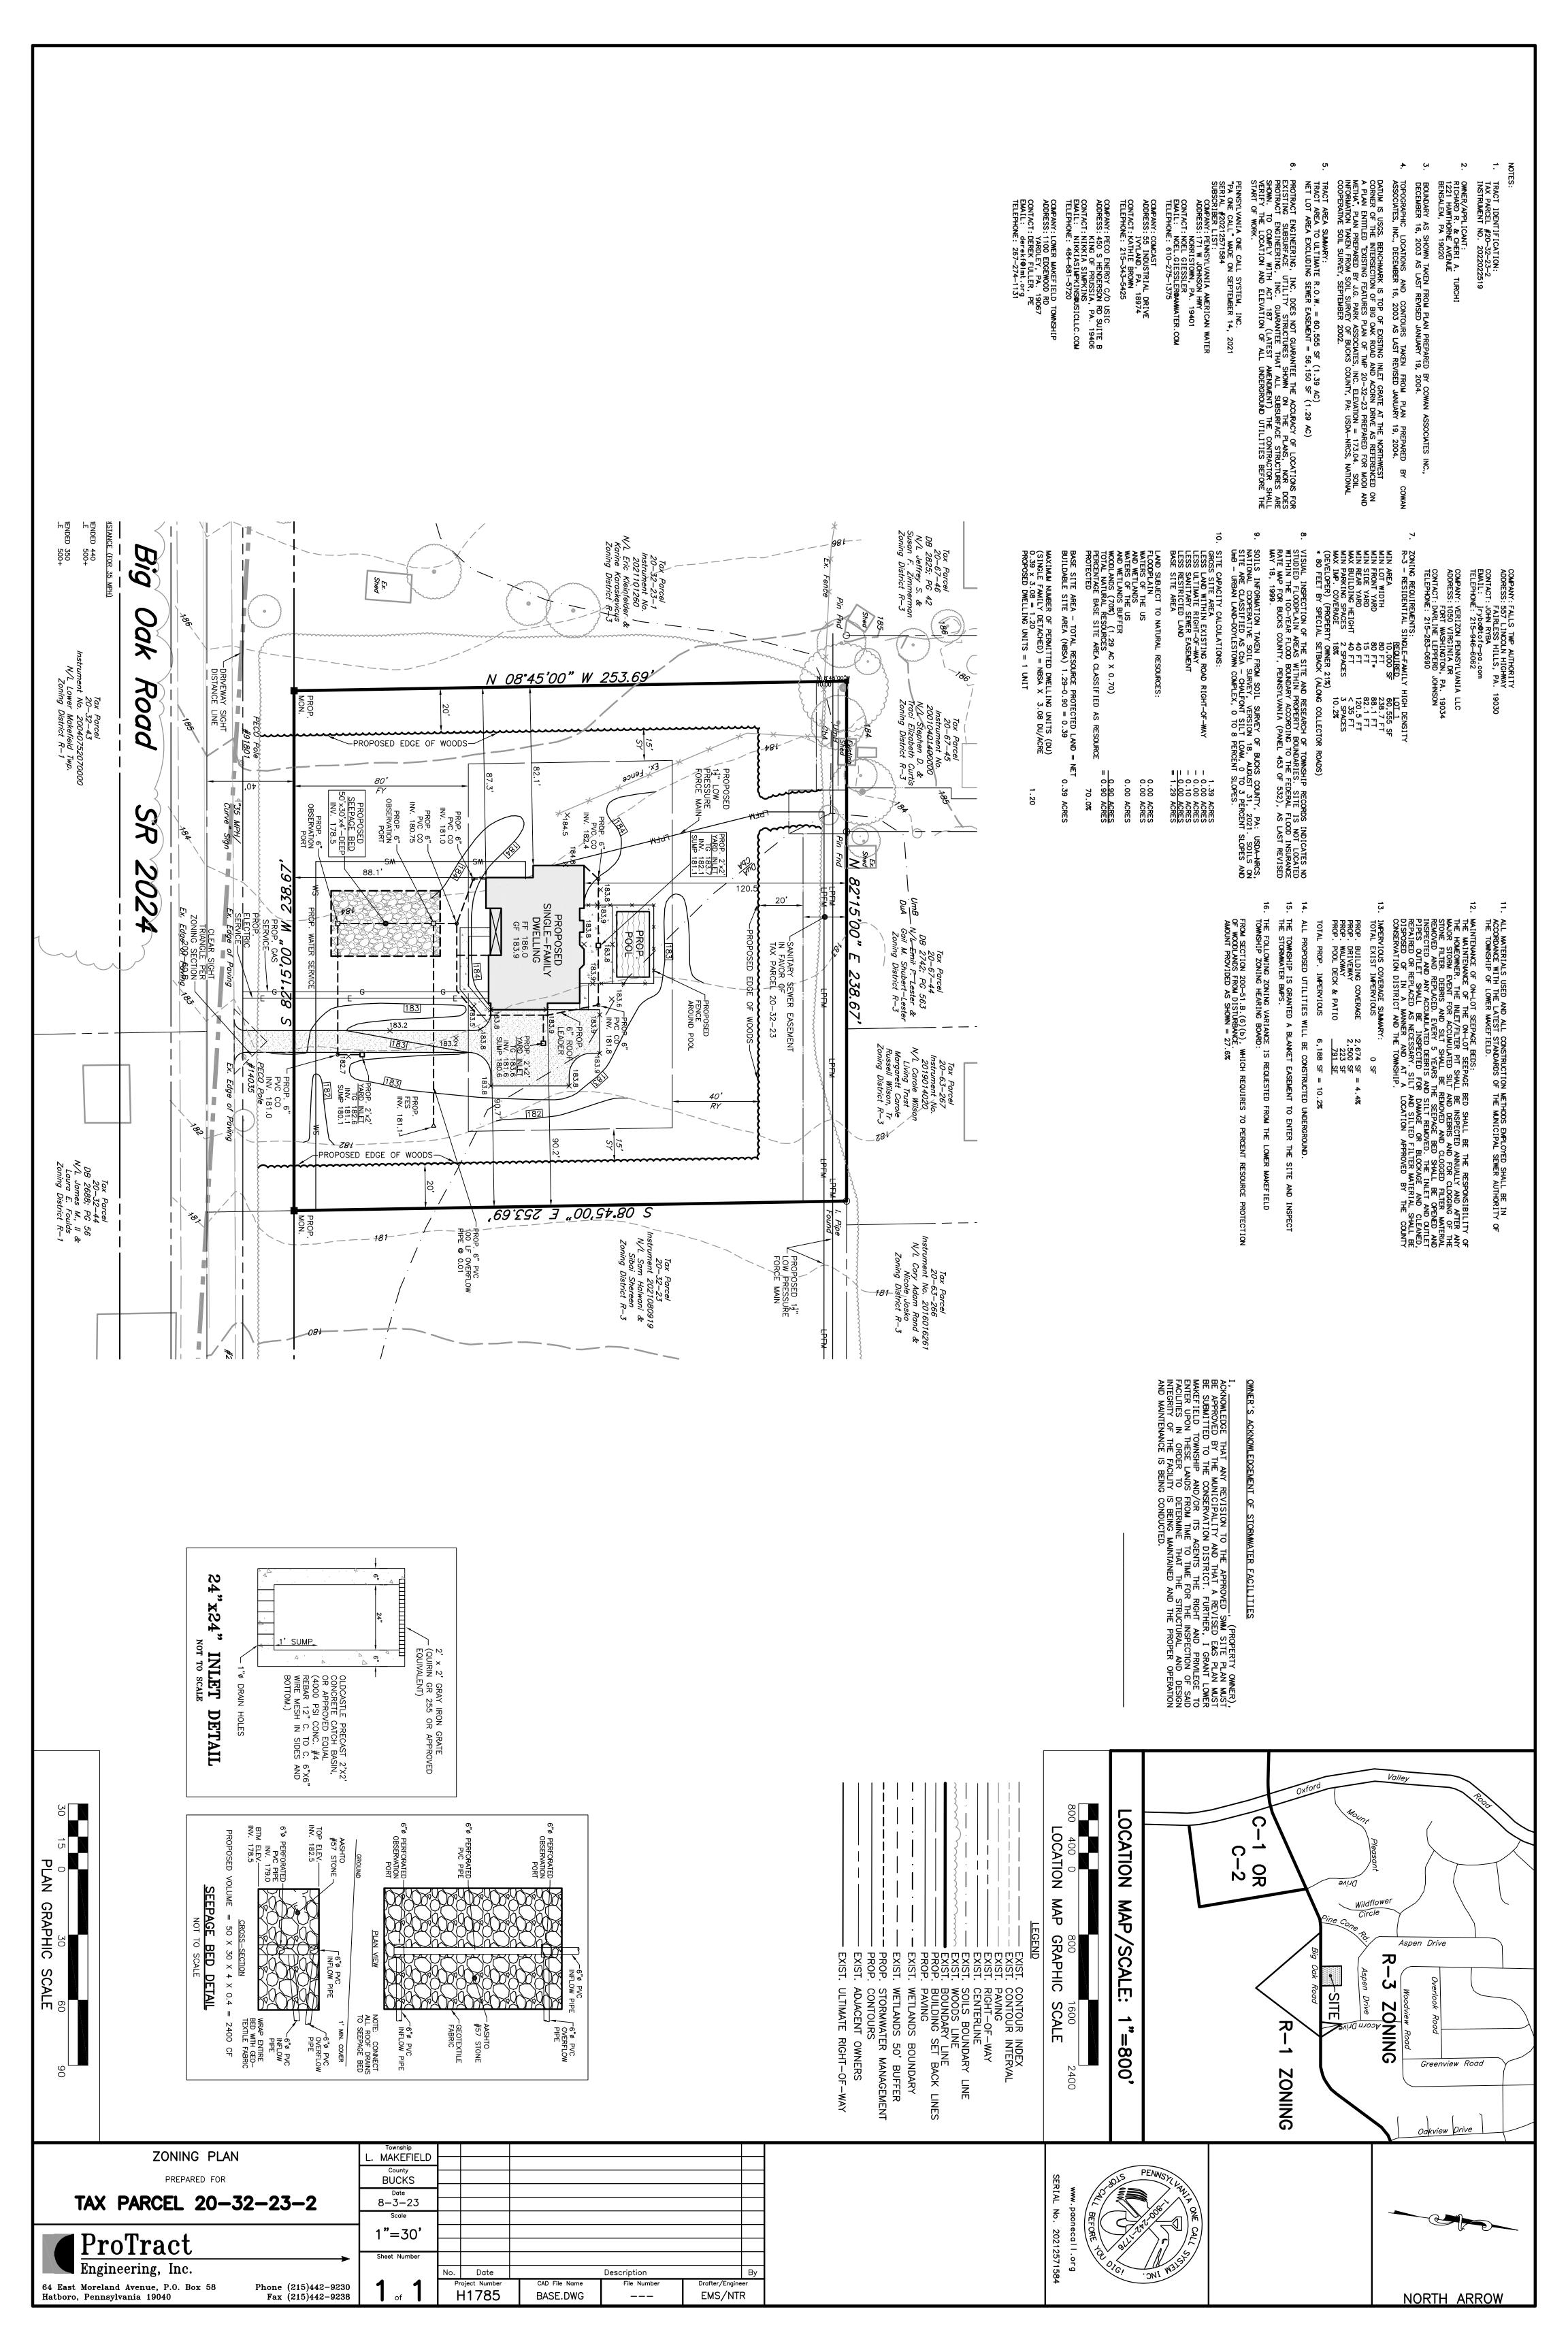

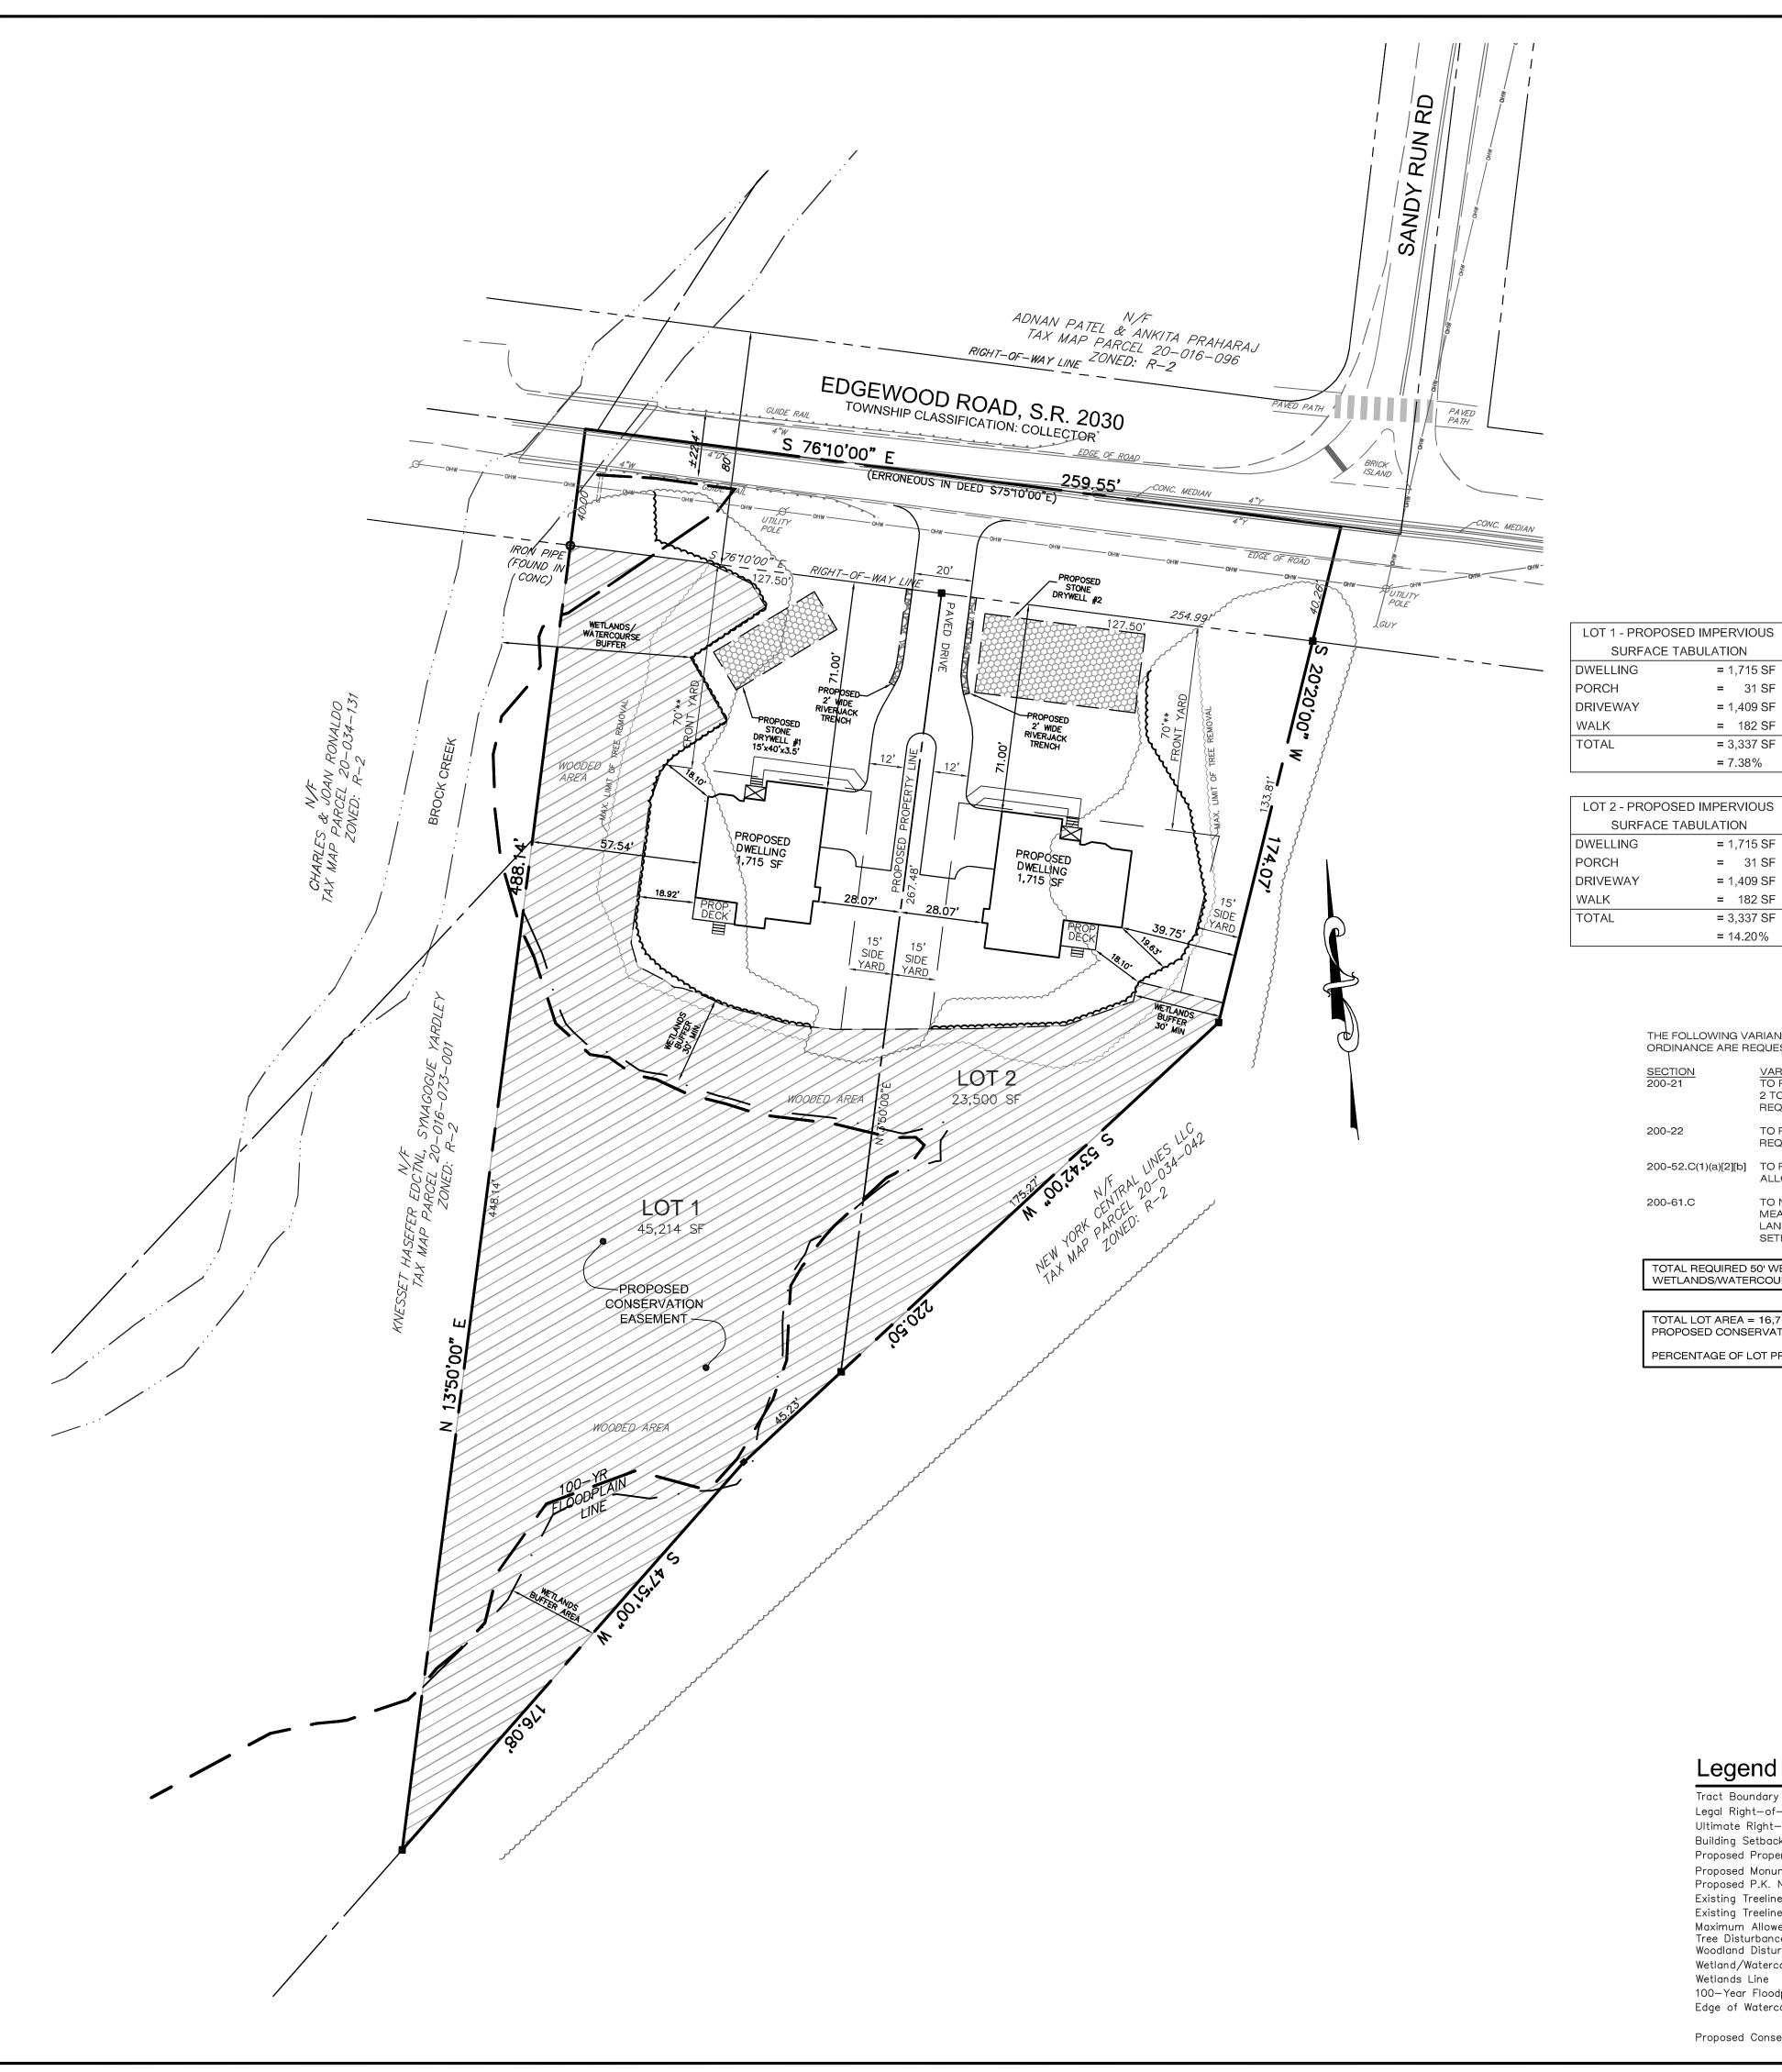

FOR DETERMINING THE NET BUILDABLE SITE AREA, THE FOLLOWING FORM SHALL BE USED:
A. CALCULATION FOR BASE SITE AREA.
(1). DETERMINE GROSS SITE AREA BY ACTUAL ON—SITE SURVEY: 1.814 AC

(2). SUBTRACT THE FOLLOWING:

(a). LAND WITHIN EXISTING ROADS AND THEIR ULTIMATE RIGHTS—OF—WAY AND UTILITY TRANSMISSION RIGHTS—OF—WAY: 0.236 AC

(b). LAND WITHOUT DEVELOPMENT OPPORTUNITIES DUE TO RESTRICTIONS SUCH AS RESTRICTIVE COVENANTS AND CONSERVATION EASEMENTS. 0.00 AC (3). EQUALS BASE SITE AREA : 1.578 AC

B. CALCULATION FOR LAND WITH RESOURCE RESTRICTIONS AND RESOURCES PROTECTION.

(1) DETERMINE LAND SUBJECT TO NATURAL RESOURCES. EACH SITE HAS UNIQUE NATURAL FEATURES. ALL APPLICATIONS SHALL INCLUDE MAPS SHOWING THE LOCATIONS OF THE RESOURCES TOGETHER WITH THE CALCULATIONS ON THE FOLLOWING CHART. IN THE EVENT THAT TWO OR MORE RESOURCES OVERLAP, ONLY THE RESOURCE WITH THE HIGHEST PROTECTION RATIO SHALL BE USED:

DATA MAPS	NATURAL RESOURCES	MINIMUM REQUIRED RESOURCE PROTECTION RATIO I	LAND IN NATURAL RESOURCES II (Ac.)	RESOURCE PROTECTION LAND (COLUMN I × COLUMN II)
HYDROLOGIC SURFACE FEATURES	FLOODPLAINS FLOODPLAIN SOILS LAKES OR PONDS WETLANDS LAKE AND POND SHORELINE	1.00 0.50 1.00 1.00 1.00	0.407 0.000 0.000 0.025 0.000	0.407 0.000 0.000 0.025 0.000
	WETLAND AND WATERCOURSE BUFFER	1.00	0.489	0.489
SLOPES	CLASS I STEEP SLOPES (8% - 15%)	0.50	0.061	0.031
	CLASS II STEEP SLOPES (15% – 25%)	0.70	0.000	0.000
	CLASS III STEEP SLOPES (GREATER THAN 25%)	1.00	0.006	0.006
WOODLAND ASSOCIATIONS	WOODLANDS	0.75	0.249	0.187

TOTAL LAND WITH NATURAL RESOURCE RESTRICTION'S: 1.237 Ac. TOTAL NATURAL RESOURCE PROTECTION LAND

(2) DETERMINE PERCENTAGE OF BASE SITE AREA CLASSIFIED AS RESOURCE—PROTECTED LAND: TOTAL RESOURCE—PROTECTED LAND DIVIDED BY BASE SITE AREA = % OF BASE SITE AREA CLASSIFIED AS RESOURCE—PROTECTED LAND:

(1). FOR ALL RESIDENTIAL SUBDIVISIONS AND LAND DEVELOPMENTS THE FOLLOWING CALCULATIONS SHALL APPLY: (a) SINGLE-FAMILY DETACHED DEVELOPMENTS AND TWO-FAMILY DEVELOPMENTS

[1] FIND NET BUILDABLE SITE AREA FOR SINGLE-FAMILY DETACHED AND TWO-FAMILY DEVELOPMENTS BASE SITE AREA MINUS TOTAL RESOURCE PROTECTED LAND (DETERMINED IN STEP II) = NET BUILDABLE SITE AREA:

[2] FIND MAXIMUM NUMBER OF PERMITTED DWELLING UNITS FOR ALL SINGLE—FAMILY DETACHED AND TWO—FAMILY DEVELOPMENTS:

ZONED: R-2, RESIDENTIAL MEDIUM-DENSITY DISTRICT

	CECTION	DECLUDED	EVICTINO	PROPOSED	PROPOSED
REQUIREMENT	SECTION	REQUIRED	EXISTING	LOT 1	LOT 2
GROSS LOT AREA			68,714 SF	45,214 SF	23,500 SF
MINIMUM NET LOT AREA	200-21	12,500 SF	18,861 SF*	8,889 SF*	9,972 SF*
MINIMUM LOT WIDTH AT FRONT BUILDING LINE	200-22	85 FT	245.88 FT	127.50 FT	118.38 FT
MINIMUM FRONT YARD	200-22	80 FT	N/A	71 FT**	71 FT**
MINIMUM SIDE YARD	200-22	15 FT	N/A	18.10 FT	18.10 FT
MINIMUM REAR YARD	200-22	45 FT	N/A	N/A	N/A
MAXIMUM IMPERVIOUS SURFACE RATIO	200-23	35%	N/A	7.38%	14.20%
MAXIMUM BUILDING HEIGHT	200-22	35 FT	N/A	<35 FT	<35 FT
MAXIMUM DENSITY	200-21	2.70 DU/AC.	N/A	4.62 D	U/AC.

*NET LOT AREA IS BASED ON THE WETLAND/WATERCOURSE BUFFER AND THE REQUIRED NATURAL RESOURCE PROTECTION RATIOS **VARIANCE REQUESTED

THE FOLLOWING VARIANCES FROM THE LOWER MAKEFIELD TOWNSHIP ZONING ORDINANCE ARE REQUESTED:

= 1,715 SF

= 31 SF

= 1,409 SF

= 182 SF

= 3,337 SF = 7.38%

= 1,715 SF

= 31 SF

= 1,409 SF

= 182 SF

= 3,337 SF= 14.20%

> 2 TO HAVE A NET LOT AREA OF 9,972 SF INSTEAD OF THE REQUIRED 12,500 SF. TO PERMIT A FRONT YARD SETBACK OF 70 FEET INSTEAD OF THE

200-52.C(1)(a)[2][b] TO PERMIT A MAXIMUM DENSITY OF 4.62 DU/AC INSTEAD OF THE 3. ALLOWABLE 2.70 DU/AC.

TO NOT REQUIRE THE MINIMUM BUILDING SETBACKS TO BE 200-61.C

MEASURED FROM THE LIMIT OF THE RESOURCE PROTECTED LANDS RATHER THAN FROM THE LOT LINES. THE MINIMUM SETBACK FROM THE NATURAL RESOURCES IS 18.10 FT.

FOTAL REQUIRED 50' WETLANDS/WATERCOURSE BUFFER AREA = 21,765 SF WETLANDS/WATERCOURSE BUFFER AREA (AS SHOWN) = 21,765 SF

TOTAL LOT AREA = 16,714 SF PROPOSED CONSERVATION EASEMENT AREA = 40,168 SF

PERCENTAGE OF LOT PROTECTED BY CONSERVATION EASEMENT = 58.46 9

GENERAL NOTES:

1. THE LOCATION OF EXISTING UNDERGROUND UTILITIES CONTAINED ON THESE PLANS HAVE BEEN OBTAINED BY FIELD SURVEY. COMPLETENESS OR ACCURACY OF THE LOCATION OF UTILITIES CANNOT BE GUARANTEED. THE CONTRACTOR SHALL VERIFY ALL EXISTING SITE CONDITIONS, SURFACE AND SUBSURFACE, AND SHALL NOTIFY THE ENGINEER IN THE EVENT OF DISCREPANCIES. IT IS THE CONTRACTOR'S RESPONSIBILITY TO NOTIFY UNDERGROUND UTILITY USERS FOR COMPLIANCE WITH PENNSYLVANIA ACT 2008-121.

LOCATION MAP

SCALE: 1"=800'

2. A PORTION OF THE SITE IS LOCATED WITHIN THE 100-YEAR FLOODPLAIN BOUNDARY AS IDENTIFIED ON FEMA MAP 42017C0451J, EFFECTIVE DATE MARCH 16, 2015. BASE FLOOD ELEVATION = 90.2-92.1

REFERENCE IS MADE TO THE FOLLOWING PLANS:

a). A PLAN OF SURVEY PREPARED BY J.G. PARK ASSOCIATES, BEING DATED OCTOBER 4, 1951. b). LOT LINE CHANGE PLAN FOR PARCELS 20-016-073-001 & 20-034-131 PREPARED BY ALL COUNTY INC, BEING DATED SEPT. 12, 2003 AND LAST REVISED MARCH 15, 2004 AS RECORDED IN PLAN BOOK 321, PAGE 58. c). FINAL AS-BUILT PLAN FOR TMP 20-016-096 PREPARED BY TRI-STATE ENGINEERS AND LAND SURVEYORS,

4. ALL PROPOSED UTILITIES SHALL BE PLACE UNDERGROUND.

BEING DATED OCTOBER 04, 2022.

5. PROPOSED DWELLINGS SHOWN ARE SCHEMATIC FOR DESIGN PURPOSES ONLY.

6. A 10' WIDE TEMPORARY GRADING EASEMENT CENTERED ON EVERY CREATED LOT LINE IS HEREBY CREATED FOR THE PURPOSES OF GRADING CONTINUITY BETWEEN THE LOTS. THIS TEMPORARY EASEMENT SHALL EXPIRE ONCE A FINAL CERTIFICATION OF OCCUPANCY IS ISSUED FOR ALL THE LOTS.

7. IT SHALL BE THE RESPONSIBILITY OF THE LOT OWNER TO MAINTAIN THE UNDERGROUND STORMWATER MANAGEMENT STONE BED. MAINTENANCE SHALL INCLUDE VISUAL INSPECTION THROUGH THE INLETS AFTER EACH RUNOFF EVENT TO CONFIRM THE STONE DRYWELL IS NOT RECEIVING SEDIMENT OR DEBRIS. LANDOWNER SHALL PERFORM ANY NECESSARY MAINTENANCE ON THE SYSTEM IF IT IS NOT FOUND TO BE OPERATING AS DESIGNED. LOWER MAKEFIELD TOWNSHIP SHALL BE GRANTED THE RIGHT OF ENTRY TO PROVIDE PROPER MAINTENANCE IF NECESSARY.

8. THE STORM WATER COLLECTION SYSTEM SHALL BE OWNED AND MAINTAINED BY THE RESPECTIVE LOT OWNER. THE LOT OWNER SHALL PROVIDE A BLANKET STORM WATER ACCESS EASEMENT TO THE TOWNSHIP FOR THE PURPOSE OF ACCESS TO THE DRYWELL AND IT'S ASSOCIATED PIPING. THIS ACCESS EASEMENT SHALL BE USED BY THE TOWNSHIP TO INSPECT THE CONDITION OF THE DRYWELL AND ASSOCIATED PIPING ON AN ANNUAL BASIS. ALL COSTS AND EXPENSES ASSOCIATED WITH SAID INSPECTION SHALL BE PAID TO THE TOWNSHIP BY LOT OWNER IN PERPETUITY. IF IN THE JUDGMENT OF THE TOWNSHIP ENGINEER THE OWNER HAS FAILED TO MAINTAIN THE DETENTION FACILITY IN SUCH A MANNER AS TO INSURE ITS PROPER FUNCTIONING, THE TOWNSHIP, UPON PROVIDING WRITTEN NOTICE, SHALL HAVE THE RIGHT TO ENTER UPON THE LANDS OF THE OWNER AND MAKE ANY REPAIRS NECESSARY TO THE DRYWELL AND ASSOCIATED FACILITIES TO INSURE THAT SUCH FACILITIES FUNCTION AND PERFORM IN ACCORDANCE WITH THE DESIGN SPECIFICATIONS. ANY AND ALL COSTS INCURRED BY THE TOWNSHIP FOR SUCH REPAIRS AND/OR MAINTENANCE SHALL

9. ALL CONTRACTORS WORKING ON THIS PROJECT SHALL BE RESPONSIBLE FOR INSURING THAT ALL CONSTRUCTION ACTIVITIES RELATED TO THIS PROJECT ARE PERFORMED IN ACCORDANCE WITH ALL APPLICABLE OSHA (OCCUPATIONAL SAFETY AND HEALTH ADMINISTRATION) STANDARDS.

10. SITE IS TO BE SERVICED BY PUBLIC SEWER AND PUBLIC WATER.

11. ALL DOWNSPOUTS ARE TO BE ROUTED TO THE PROPOSED STONE DRYWELLS.

12. A BLANKET EASEMENT OVER THE LOT IN FAVOR OR THE TOWNSHIP IS CREATED IN ORDER TO ALLOW THE TOWNSHIP TO PERFORM INSPECTIONS AND EMERGENCY MAINTENANCE, IF NECESSARY, OF THE STORMWATER MANAGEMENT FACILITIES.

13. NO PERSON SHALL MODIFY, REMOVE, FILL, LANDSCAPE, OR ALTER ANY STORMWATER MANAGEMENT (SWM) BEST MANAGEMENT PRACTICES (BMPs), FACILITIES, AREA, OR STRUCTURE UNLESS IT IS A PART OF AN APPROVED MAINTENANCE PROGRAM AND WRITTEN APPROVAL OF THE MUNICIPALITY HAS BEEN OBTAINED.

14. NO PERSON SHALL PLACE ANY STRUCTURE, FILL, LANDSCAPING, OR VEGETATION INTO A STORMWATER FACILITY OR BMP OR WITHIN A DRAINAGE EASEMENT WHICH WOULD LIMIT OR ALTER THE FUNCTIONING OF THE STORMWATER FACILITY OR BMP WITHOUT THE WRITTEN APPROVAL OF THE MUNICIPALITY.

15. THIS PLAN WAS PREPARED WITHOUT THE BENEFIT OF A TITLE REPORT.


16. WETLAND INFORMATION SHOWN IS BASED ON A FIELD STUDY BY NOVA CONSULTANTS. A JURISDICTIONAL DETERMINATION

17. THE APPLICANT IS PROPOSING A FEE-IN-LEIU OF RECREATION LAND.

18. TOPOGRAPHY AND ELEVATIONS BASED ON THE NORTH AMERICAN VERTICAL DATUM OF 1988 (NAVD88), VIA RTK

19. THE FEMA FLOODPLAIN SHOWN IS MAPPED BASED ON ELEVATION, NOT A GRAPHICAL INTERPRETATION

CALL BEFORE YOU DIG! PENNSYLVANIA LAW REQUIRES 3 WORKING DAYS NOTICE FOR CONSTRUCTION PHASE AND 10 WORKING DAYS IN DESIGN STAGE—STOP CALL PENNSYLVANIA ONE CALL SYSTEM, INC. 1-800-242-1776

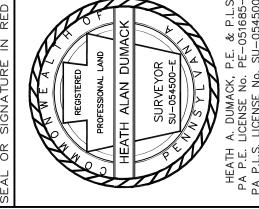





REVISION SEPT. 6, 2023 PER TOWNSHIP ZONING OFFICER

EXISTING PARCEL INFO: T.M.P. No. 20-034-130 DEED BOOK: 1533

PAGE No. 1001 CURRENT ZONING: R-2 OWNER of RECORD: CHARLES S & FRANCINE HARRIS

YARDLEY, PA 19067 APPLICANT: BRIAN BRZEZINSKI

855 SANDY RUN ROAD

269 CANAL ROAD FAIRLESS HILLS, PA 19030



ONING PLAN EDGEWOOD ROAD

LOWER MAKEFIELD TOWNSHIP BUCKS COUNTY, PA

JNE 30, 202


Legend

Tract Boundary Line Legal Right-of-Way Line Ultimate Right-of-Way Line Building Setback Line Proposed Property Line Proposed Monument To Be Set Proposed P.K. NAIL To Be Set Existing Treeline

Existing Treeline To Remain Maximum Allowed Limit of Tree Disturbance Based of Woodland Disturbance Ratio Wetland/Watercourse Buffer Lin Wetlands Line

Edge of Watercourse Proposed Conservation Easement


100—Year Floodplain Line

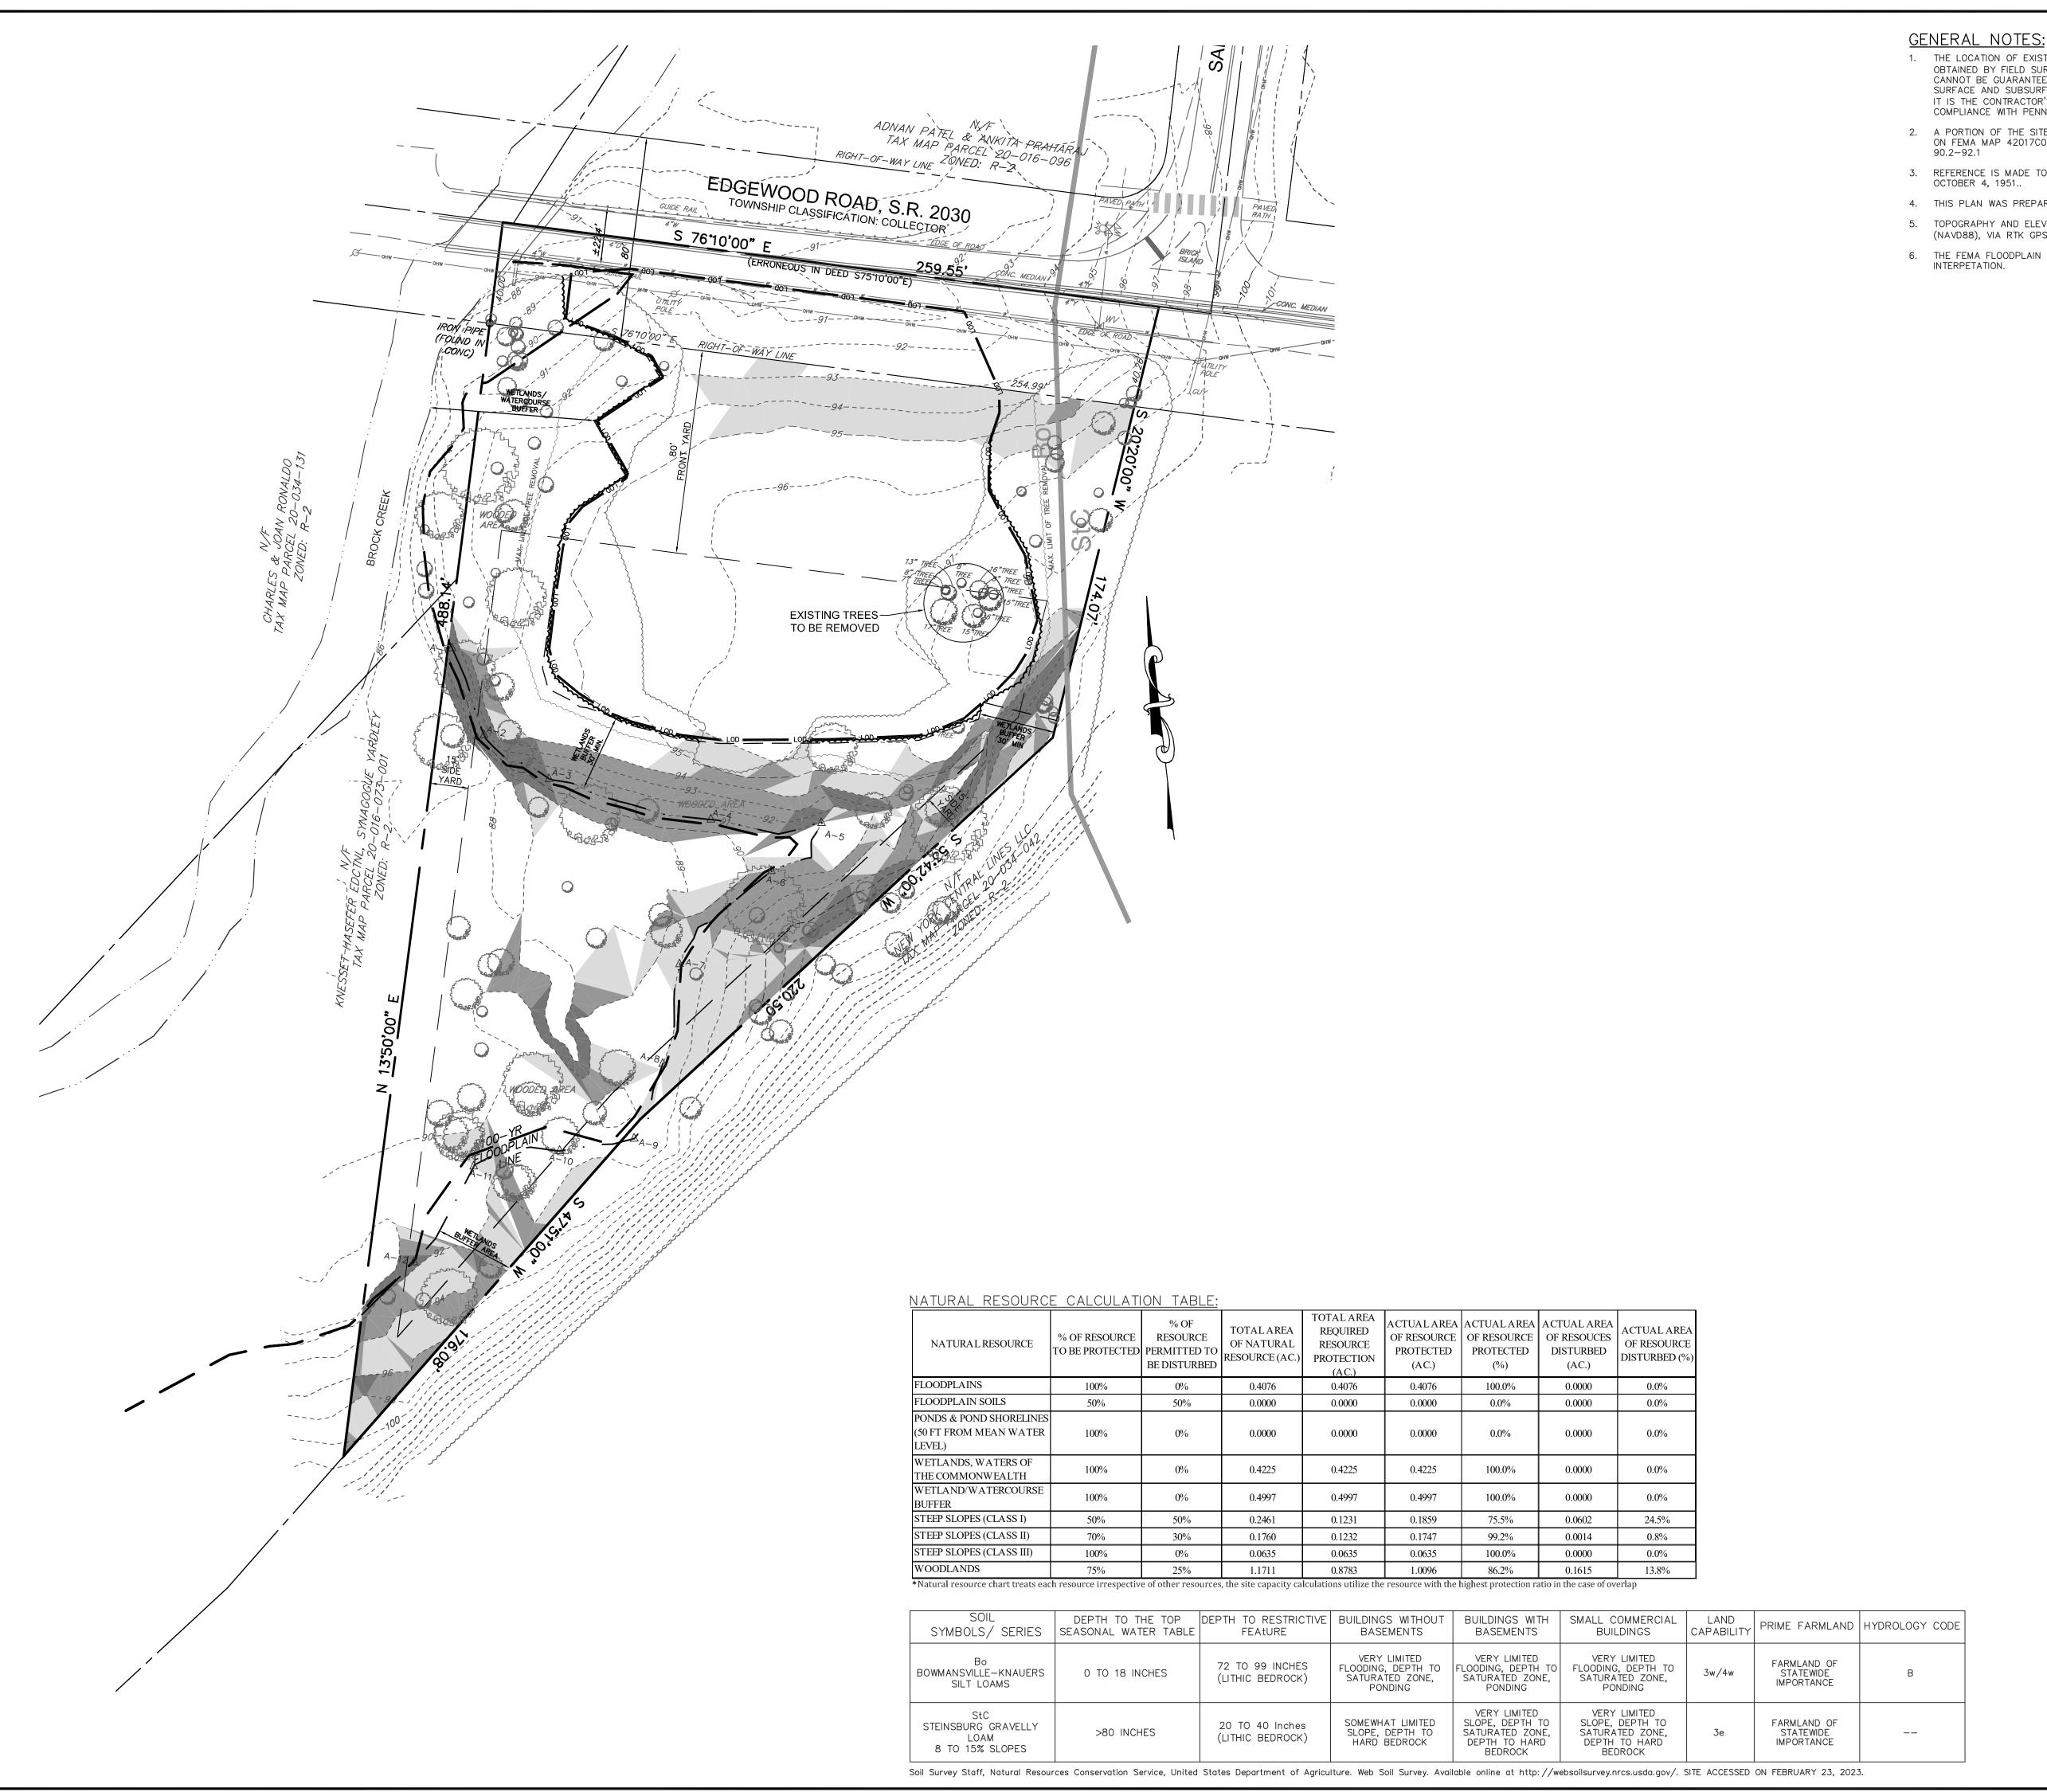


- 1. THE LOCATION OF EXISTING UNDERGROUND UTILITIES CONTAINED ON THESE PLANS HAVE BEEN OBTAINED BY FIELD SURVEY. COMPLETENESS OR ACCURACY OF THE LOCATION OF UTILITIES CANNOT BE GUARANTEED. THE CONTRACTOR SHALL VERIFY ALL EXISTING SITE CONDITIONS, SURFACE AND SUBSURFACE, AND SHALL NOTIFY THE ENGINEER IN THE EVENT OF DISCREPANCIES. IT IS THE CONTRACTOR'S RESPONSIBILITY TO NOTIFY UNDERGROUND UTILITY USERS FOR COMPLIANCE WITH PENNSYLVANIA ACT 2008-121.
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- 3. REFERENCE IS MADE TO A PLAN OF SURVEY PREPARED BY J.G. PARK ASSOCIATES, BEING DATED
- 4. THIS PLAN WAS PREPARED WITHOUT THE BENEFIT OF A TITLE REPORT.
- 5. TOPOGRAPHY AND ELEVATIONS BASED ON THE NORTH AMERICAN VERTICAL DATUM OF 1988 (NAVD88), VIA RTK GPS.
- 6. THE FEMA FLOODPLAIN SHOWN IS MAPPED BASED ON ELEVATION, NOT A GRAPHICAL

SERIAL No. 2023-1812903 CALL BEFORE YOU DIG! PENNSYLVANIA LAW REQUIRES 3 WORKING DAYS NOTICE FOR CONSTRUCTION PHASE AND 10 WORKING DAYS IN DESIGN STAGE—STOP CALL

PENNSYLVANIA ONE CALL SYSTEM, INC. 1-800-242-1776

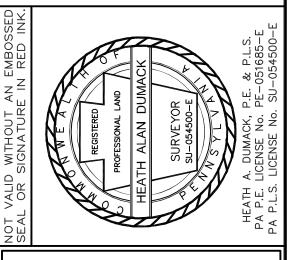

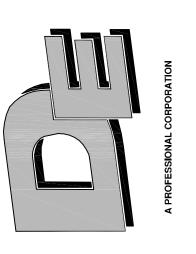

DATE SEPT. 6, 2023 PER TOWNSHIP ZONING OFFICER

EXISTING PARCEL INFO:
T.M.P. No. 20-034-1 DEED BOOK: 1533
CUBBENT ZONING: B

CURRENT ZONING: R-2 OWNER of RECORD: CHARLES S & FRANCINE HARRIS 855 SANDY RUN ROAD YARDLEY, PA 19067

PAGE No. 1001

APPLICANT:


BRIAN BRZEZINSKI
269 CANAL ROAD FAIRLESS HILLS, PA 19030

_-----91 -----

_----90 -----

_____SaS _____

△ A-1

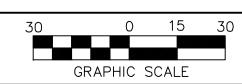

EDGEWOOD ROAD

LOWER MAKEFIELD TOWNSHIP BUCKS COUNTY, PA

7905 plan date: JUNE 30, 2023

Steep Slope Legend

8-15% Steep Slopes

15-25% Steep Slopes

>25% Steep Slopes


Legend

Tract Boundary Line Legal Right-of-Way Line Ultimate Right-of-Way Line Existing Contour Existing Index Contour Existing Water Main Existing Storm Sewer Existing Tree Existing Treeline Existing Treeline To Remain Soil Boundary Line Building Setback Line

Existing Sanitary Sewer Existing Gas Main Wetland Flag Location Maximum Allowed Limit of

Tree Disturbance Based of Woodland Disturbance Ratio Wetland/Watercourse Buffer Wetlands Line 100-Year Floodplain Line

Edge of Watercourse

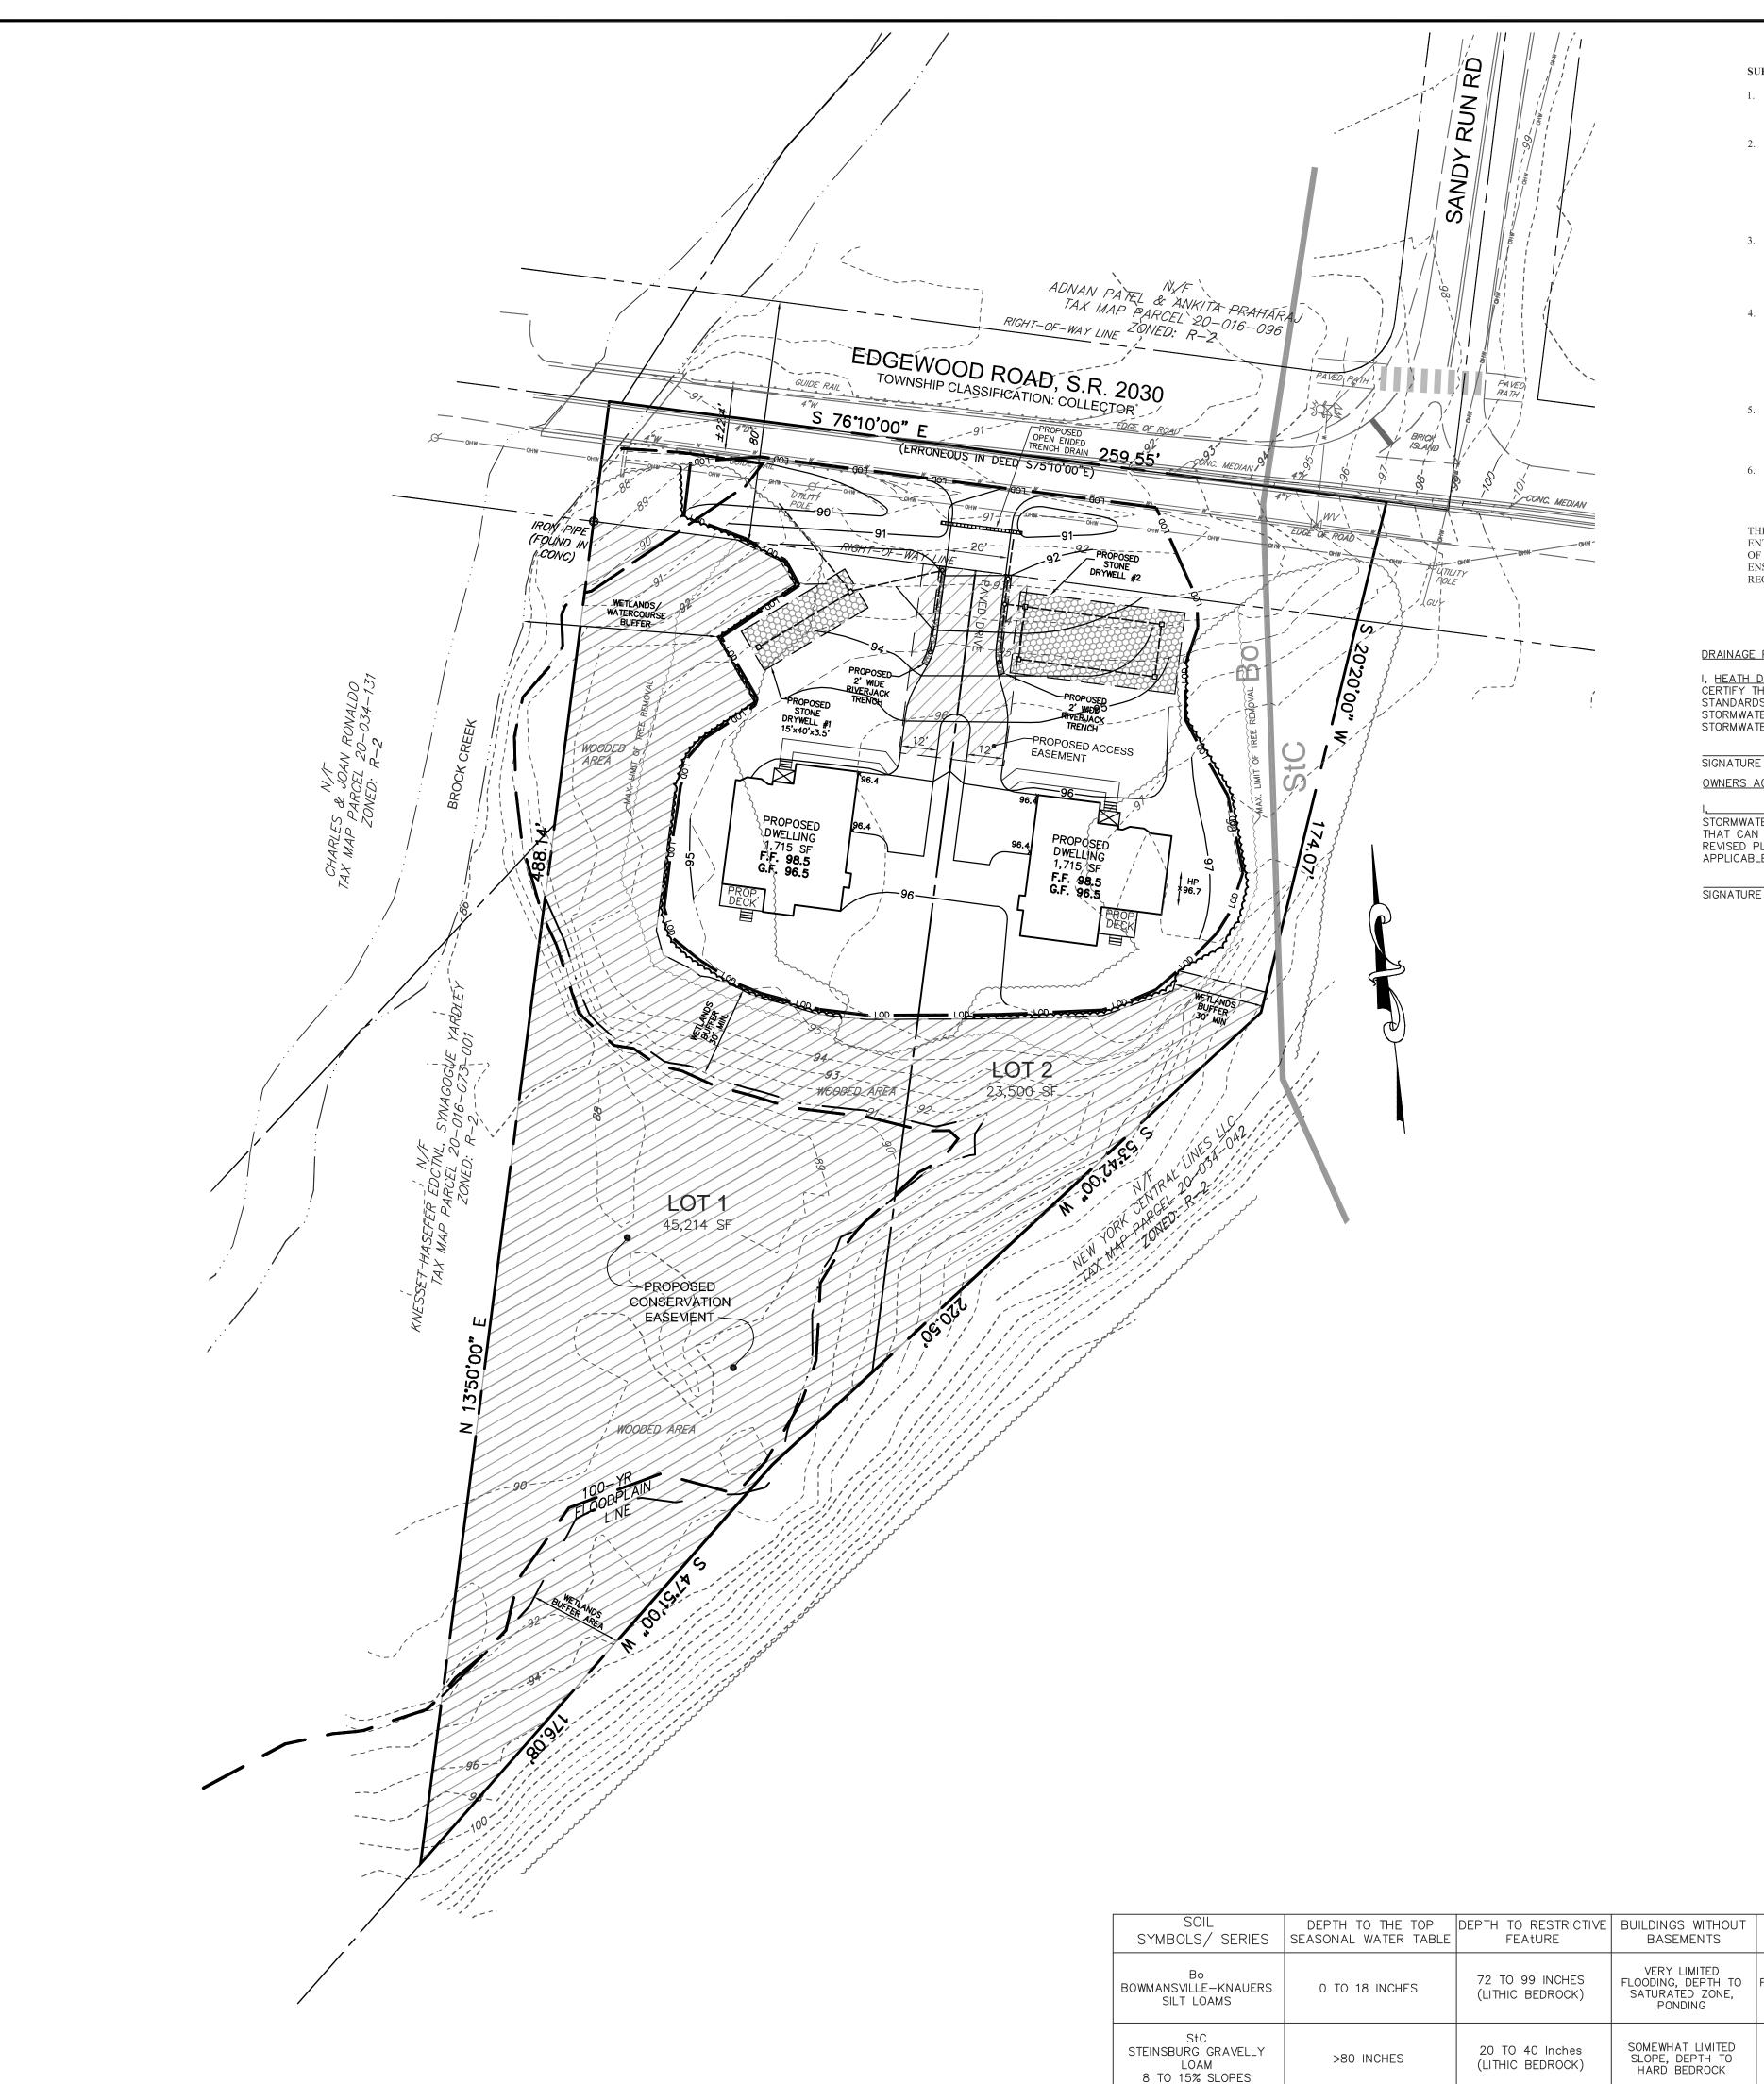

SUBSURFACE DRYWELL INSPECTION AND MAINTENANCE SCHEDULE

- 1. INSPECTION, MAINTENANCE AND REPAIR OF THE UNDERGROUND STORMWATER MANAGEMENT SYSTEMS SHALL BE THE RESPONSIBILITY OF THE PROPERTY
- 2. 100 PERCENT VEGETATIVE COVER BY HERBACEOUS SPECIES SHALL BE MAINTAINED THROUGHOUT ALL EMBANKMENTS AND LAWN AREAS WITH DIRECT DISCHARGE TO THE UNDERGROUND FACILITY. ANY AREA BECOMING VOID OF VEGETATION SHALL BE IMMEDIATELY CORRECTED BY REPLANTING OR OTHER ADEQUATE MEASURES NECESSARY TO PREVENT EROSION THAT MAY JEOPARDIZE THE POROSITY OF THE SYSTEM. AT NO TIME SHALL MULCH BE USED ON SLOPES OF DIRECT DRAINAGE TO THE UNDERGROUND FACILITY.
- 3. GRASS CLIPPINGS SHALL BE COLLECTED AND REMOVED TO PREVENT CLOGGING OF THE FACILITY. FALLEN LEAVES SHALL BE COLLECTED AND REMOVED FROM THE SITE A MINIMUM OF ONE (1) TIME PER WEEK DURING THE FALL SEASON. ROOF DRAINS AND DEBRIS TRAPS SHALL BE CHECKED FOR LEAF LITTER AND OTHER DEBRIS, WHICH MAY CLOG PERFORATED PIPES AND/OR STONE BEDS.
- 4. INSPECT UNDERGROUND STORMWATER MANAGEMENT FACILITY AT LEAST FOUR TIMES A YEAR, AS WELL AS AFTER EVERY STORM EXCEEDING 1 INCH. REMOVE CLEANOUT CAPS AND INSPECT FOR DEBRIS. REMOVE ACCUMULATED LEAVES, TWIGS, SEDIMENT AND OTHER DEBRIS AS REQUIRED TO KEEP THE ROOF DRAINAGE SYSTEM CLEAN. IF AFTER INSPECTION IT IS DETERMINED THAT SEDIMENT NEEDS TO BE REMOVED FROM THE SEEPAGE BED, INJECT SYSTEM WITH WATER, SUSPEND SILT AND PUMP CHAMBER.
- 5. EVALUATE THE DRAIN-DOWN TIME OF THE FACILITY TO INSURE THE MAXIMUM TIME OF 72 HOURS IS NOT BEING EXCEEDED. IF DRAIN-DOWN TIMES ARE EXCEEDING THE MAXIMUM, DRAIN THE FACILITY BY PUMPING AND CLEANING OUT PERFORATED PIPE.
- 6. THE PROPERTY OWNER SHALL SUBMIT AN ANNUAL REPORT TO THE TOWNSHIP DETAILING THE MAINTENANCE WORK, INCLUDING REPAIRS, IF ANY, THAT ARE CARRIED OUT DURING A GIVEN CALENDAR YEAR SUCH REPORTS SHALL BE DUE ON OR ABOUT THE FIRST DAY OF MARCH OF THE FOLLOWING YEAR.

THE TOWNSHIP AND/OR IT'S AGENTS RESERVES THE RIGHT AND PRIVILEGE TO ENTER UPON SUCH LANDS FROM TIME TO TIME FOR THE PURPOSE OF INSPECTION OF SAID UNDERGROUND STORMWATER MANAGEMENT FACILITY IN ORDER TO ENSURE THAT THE STRUCTURAL AND DESIGN INTEGRITY AND MAINTENANCE REQUIREMENTS ARE BEING MAINTAINED BY THE OWNERS.

DRAINAGE PLAN CERTIFICATION

I, <u>HEATH DUMACK, P.E.</u> ON THIS DATE______, HAVE REVIEWED AND HEREBY CERTIFY THAT TO THE BEST OF MY KNOWLEDGE THE SWM SITE PLAN MEETS ALL DESIGN STANDARDS AND CRITERIA OF THE DELAWARE RIVER SOUTH WATERSHED ACT 167 STORMWATER MANAGEMENT ORDINANCE OR PLAN AND LOWER MAKEFIELD TOWNSHIP STORMWATER ORDINANCE.

SIGNATURE

OWNERS ACKNOWLEDGMENT

(LAND OWNER), HEREBY ACKNOWLEDGES THAT THE STORMWATER MANAGEMENT SYSTEM, INCLUDING ALL BMP's, ARE A PERMANENT FIXTURE THAT CAN BE ALTERED OR REMOVED ONLY AFTER APPROVAL BY THE TOWNSHIP OF A REVISED PLAN, WHICH SHALL BE RECORDED WITH THE RECORD PLAN AND WHICH SHALL BE APPLICABLE TO ALL FUTURE LAND OWNERS.

- 1. THE LOCATION OF EXISTING UNDERGROUND UTILITIES CONTAINED ON THESE PLANS HAVE BEEN OBTAINED BY FIELD SURVEY. COMPLETENESS OR ACCURACY OF THE LOCATION OF UTILITIES CANNOT BE GUARANTEED. THE CONTRACTOR SHALL VERIFY ALL EXISTING SITE CONDITIONS, SURFACE AND SUBSURFACE, AND SHALL NOTIFY THE ENGINEER IN THE EVENT OF DISCREPANCIES. IT IS THE CONTRACTOR'S RESPONSIBILITY TO NOTIFY UNDERGROUND UTILITY USERS FOR COMPLIANCE WITH PENNSYLVANIA ACT 2008-121.
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- 3. TOPOGRAPHY AND ELEVATIONS BASED ON THE NORTH AMERICAN VERTICAL DATUM OF 1988
- 4. ALL CONSTRUCTION, MATERIALS AND WORKMANSHIP SHALL CONFORM TO THE LATEST STANDARDS AND SPECIFICATIONS OF BENSALEM TOWNSHIP AND THE PENNSYLVANIA DEPARTMENT OF TRANSPORTATION. ALL WORK SHALL BE PERFORMED IN ACCORDANCE WITH
- 5. ALL WORK AND MATERIALS SHALL BE INSPECTED BY THE TOWNSHIP ENGINEER AND/OR HIS APPROVED REPRESENTATIVES.
- 6. ALL PROPOSED UTILITIES TO BE PLACED UNDERGROUND.
- 7. CONTRACTOR IS RESPONSIBLE FOR CHECKING ALL DISTANCES, GRADES, QUANTITIES, LINES AND ELEVATIONS AND NOTIFYING DUMACK ENGINEERING OF ANY DISCREPANCIES PRIOR TO PROCEEDING WITH ANY WORK.
- 8. ALL STRUCTURAL FILL IN THE BUILDING AREAS (MATERIAL UNDER CARTWAYS, SLABS, INLETS, ENDWALLS ETC.) SHALL BE COMPACTED TO 95% OF MAXIMUM DRY DENSITY (ASTM D1557). ALL OTHER STRUCTURAL FILL SHALL BE COMPACTED TO 95% OF MAXIMUM DRY DENSITY (ASTM
- 9. TREES TO REMAIN SHALL BE PROTECTED DURING CONSTRUCTION FROM ROOT COMPACTION, EQUIPMENT AND MATERIALS.
- 10. ALL BUILDING MATERIAL AND WASTES MUST BE REMOVE FROM THE SITE AND RECYCLED OR RECYCLED IN ACCORDANCE WITH DEP'S SOLID WASTE REGULATIONS (25 PA CODE 260.1 ET. SEQ. 271.1 ET. SEQ., AND 287.1 ET. SEQ., AND/OR ANY ADDITIONAL LOCAL, STATE, OR FEDERAL REGULATIONS.. NO BUILDING MATERIALS (USED OR UNUSED) OR WASTE MATERIALS SHALL BE BURNED, BURIED, DUMPED, OR DISCHARGED AT THE SITE.
- 11. ANTICIPATED CONSTRUCTION WASTE INCLUDES WOOD, EROSION CONTROL BMPS CONSTRUCTION FENCING, AND MISCELLANEOUS.
- 12. NO KNOWN POTENTIAL POLLUTION PROBLEMS DUE TO GEOLOGIC CONDITION EXIST ON THIS SITE. WHERE POTENTIAL FOR POLLUTION IDENTIFIED, MEASURES ARE PROVIDED TO AVOID/MINIMIZE/ OR MITIGATE.
- 13. THIS PLAN MINIMIZES IMPERVIOUS SURFACES.
- 14. THIS PLAN MAXIMIZES THE PROTECTION OF DRAINAGE FEATURES AND EXISTING VEGETATION.
- 15. THIS PLAN MINIMIZES LAND CLEARING AND GRADING.
- 16. THIS PLAN MINIMIZES SOIL COMPACTION.
- 17. THIS PLAN UTILIZES STRUCTURAL AND NON-STRUCTURAL BMPs THAT PREVENT OR MINIMIZES CHANGES IN STORMWATER RUNOFF.
- 18. THIS PLAN IS CONSISTENT WITH THE DIMENSIONS AND ELEVATIONS USED IN SUPPORTING
- 19. THIS PLAN IS CONSISTENT WITH EROSION & SEDIMENT CONTROL PLAN IN RELATION TO PROPOSED CONTOURS, IMPROVEMENTS, SOILS, WETLANDS, FLOODWAYS, STREAMS, DISCHARGE
- 20. THIS PLAN PRESERVES THE INTEGRITY OF STREAM CHANNELS AND MAINTAINS AND PROTECTS THE PHYSICAL, BIOLOGICAL AND CHEMICAL EQUALITIES OF THE RECEIVING STREAM.
- 21. THE APPLICANT SHALL PROVIDE AS-BUILT PLANS FOR ALL SWM BMPs TO THE TOWNSHIP.
- 22. THE SITE IS LOCATED WITHIN THE DELAWARE RIVER SOUTH WATERSHED DISTRICT. THE SITE DRAINS TO BROCK CREEK WITH A CHAPTER 93 EXISTING AND DESIGNATED USE OF COLD WATER FISHES (CWF) AND MIGRATORY FISHES (MF).

<u>General Notes</u>

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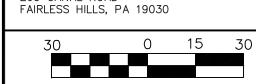
SERIAL No. 2023-1812903

DATE SEPT. 6, 2023 PER TOWNSHIP ZONING OFFICER

> (ISTING PARCEL INFO: T.M.P. No. 20-034-130 DEED BOOK: 1533

PAGE No. 1001 CURRENT ZONING: R-2 OWNER of RECORD: CHARLES S & FRANCINE HARRIS 855 SANDY RUN ROAD

YARDLEY, PA 19067 APPLICANT: BRIAN BRZEZINSKI 269 CANAL ROAD



GRAPHIC SCALE EDGEWOOD ROAD

LOWER MAKEFIELD TOWNSHIP BUCKS COUNTY, PA

7905 JNE 30, 2023

Legend

Tract Boundary Line Legal Right-of-Way ______ _----91 -----Existing Contour Existing Index Contour _----95 -----Existing Sanitary Sewer Existing Water Main _____w ____w ____w ____ Existing Storm Sewer _____ Existing Gas Main Existing Electric Proposed Contour Proposed Index Contour × 96.7 Proposed Spot Elevation Limits of Disturbance Existing Utility Pole \bowtie Existing Valve Existing Vegetation Existing Vegetation To Remain -----Proposed Storm Sewer Proposed Property Line Maximum Allowed Limit of Tree Disturbance Based of Woodland Disturbance Ratio Wetland/Watercourse Buffer Line

Wetlands Line

100-Year Floodplain Line Edge of Watercourse

Proposed Conservation Easement

BEDROCK BEDROCK

Soil Survey Staff, Natural Resources Conservation Service, United States Department of Agriculture. Web Soil Survey. Available online at http://websoilsurvey.nrcs.usda.gov/. SITE ACCESSED ON FEBRUARY 23, 2023.

SOMEWHAT LIMITED SLOPE, DEPTH TO SATURATED ZONE, SLOPE, DEPTH TO SLOPE, DEPTH TO SATURATED ZONE, DEPTH TO HARD DEPTH TO HARD

BUILDINGS WITH

BASEMENTS

VERY LIMITED LOODING, DEPTH TO

SATURATED ZONE,

PONDING

VERY LIMITED VERY LIMITED

SMALL COMMERCIAL

BUILDINGS

VERY LIMITED FLOODING, DEPTH TO SATURATED ZONE, PONDING

CAPABILITY

3w/4w


FARMLAND OF STATEWIDE IMPORTANCE


FARMLAND OF


STATEWIDE

IMPORTANCE

PRIME FARMLAND HYDROLOGY CODE

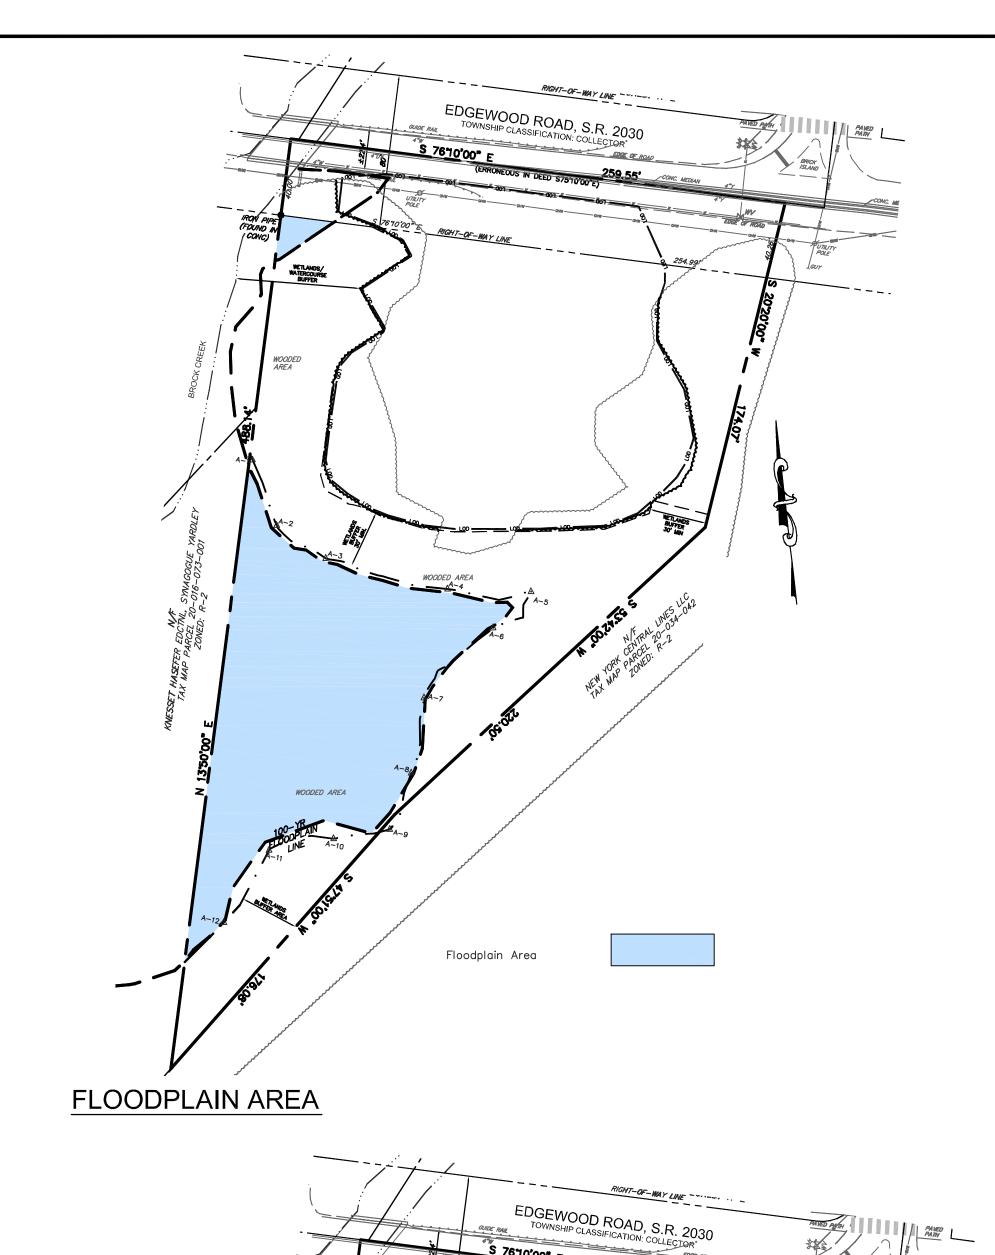

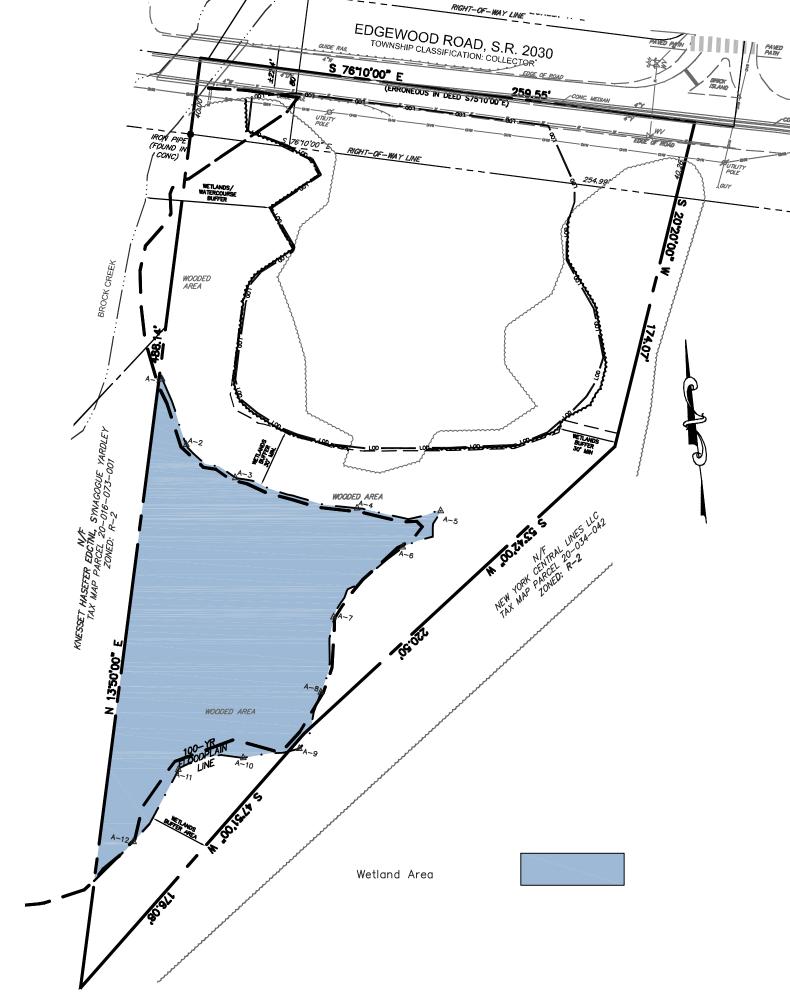

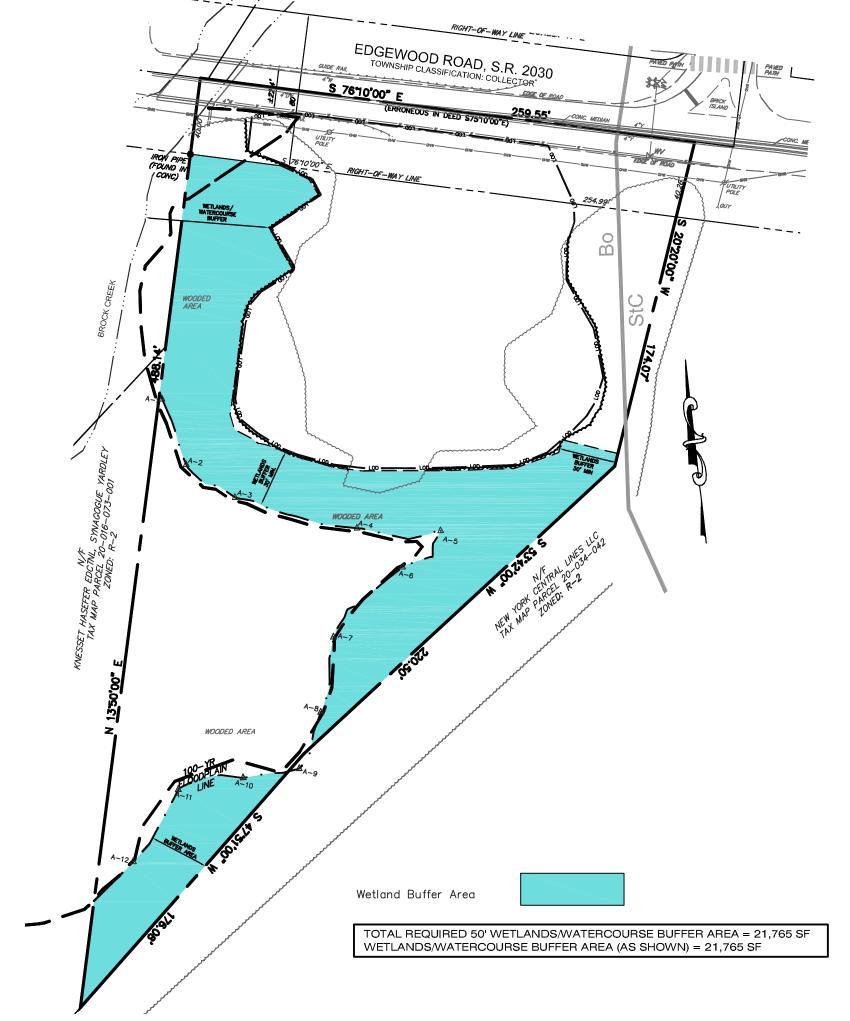





STEEP SLOPE AREAS


WETLAND BUFFER AREA


NATURAL RESOURCE CALCULATION TARLET

NATURAL RESOURCE	% OF RESOURCE TO BE PROTECTED	% OF RESOURCE PERMITTED TO BE DISTURBED	TOTAL AREA OF NATURAL RESOURCE (AC.)	TOTAL AREA REQUIRED RESOURCE PROTECTION (AC.)	ACTUAL AREA OF RESOURCE PROTECTED (AC.)	ACTUAL AREA OF RESOURCE PROTECTED (%)	ACTUAL AREA OF RESOUCES DISTURBED (AC.)	ACTUAL AREA OF RESOURCE DISTURBED (%)
FLOODPLAINS	100%	0%	0.4076	0.4076	0.4076	100.0%	0.0000	0.0%
FLOODPLAIN SOILS	50%	50%	0.0000	0.0000	0.0000	0.0%	0.0000	0.0%
PONDS & POND SHORELINES (50 FT FROM MEAN WATER LEVEL)	100%	0%	0.0000	0.0000	0.0000	0.0%	0.0000	0.0%
WETLANDS, WATERS OF THE COMMONWEALTH	100%	0%	0.4225	0.4225	0.4225	100.0%	0.0000	0.0%
WETLAND/WATERCOURSE BUFFER	100%	0%	0.4997	0.4997	0.4997	100.0%	0.0000	0.0%
STEEP SLOPES (CLASS I)	50%	50%	0.2461	0.1231	0.1859	75.5%	0.0602	24.5%
STEEP SLOPES (CLASS II)	70%	30%	0.1760	0.1232	0.1747	99.2%	0.0014	0.8%
STEEP SLOPES (CLASS III)	100%	0%	0.0635	0.0635	0.0635	100.0%	0.0000	0.0%
WOODLANDS	75%	25%	1.1711	0.8783	1.0096	86.2%	0.1615	13.8%

*Natural resource chart treats each resource irrespective of other resources, the site capacity calculations utilize the resource with the highest protection ratio in the case of overlap

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REVISION 1 SEPT. 6, 2023 PER TOWNSHIP ZONING OFFICER

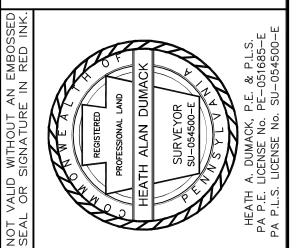EXISTING PARCEL INFO:

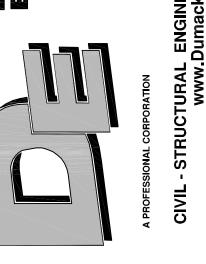T.M.P. No. 20-034-130
DEED BOOK: 1533
PAGE No. 1001


CURRENT ZONING: R-2

OWNER of RECORD:

CHARLES S & FRANCINE HARRIS
855 SANDY RUN ROAD
YARDLEY, PA 19067

APPLICANT:

BRIAN BRZEZINSKI
269 CANAL ROAD
FAIRLESS HILLS, PA 19030

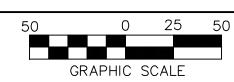


EDGEWOOD ROAD

LOWER MAKEFIELD TOWNSHIP BUCKS COUNTY, PA

DOOKS 00	701411, 1
DRAWN BY:	CHECKED BY:
HAD	
1"=50'	PROJECT No:
plan date: JUNE 30, 2023	7 9 0 0 SHEET No: 1 OF 1



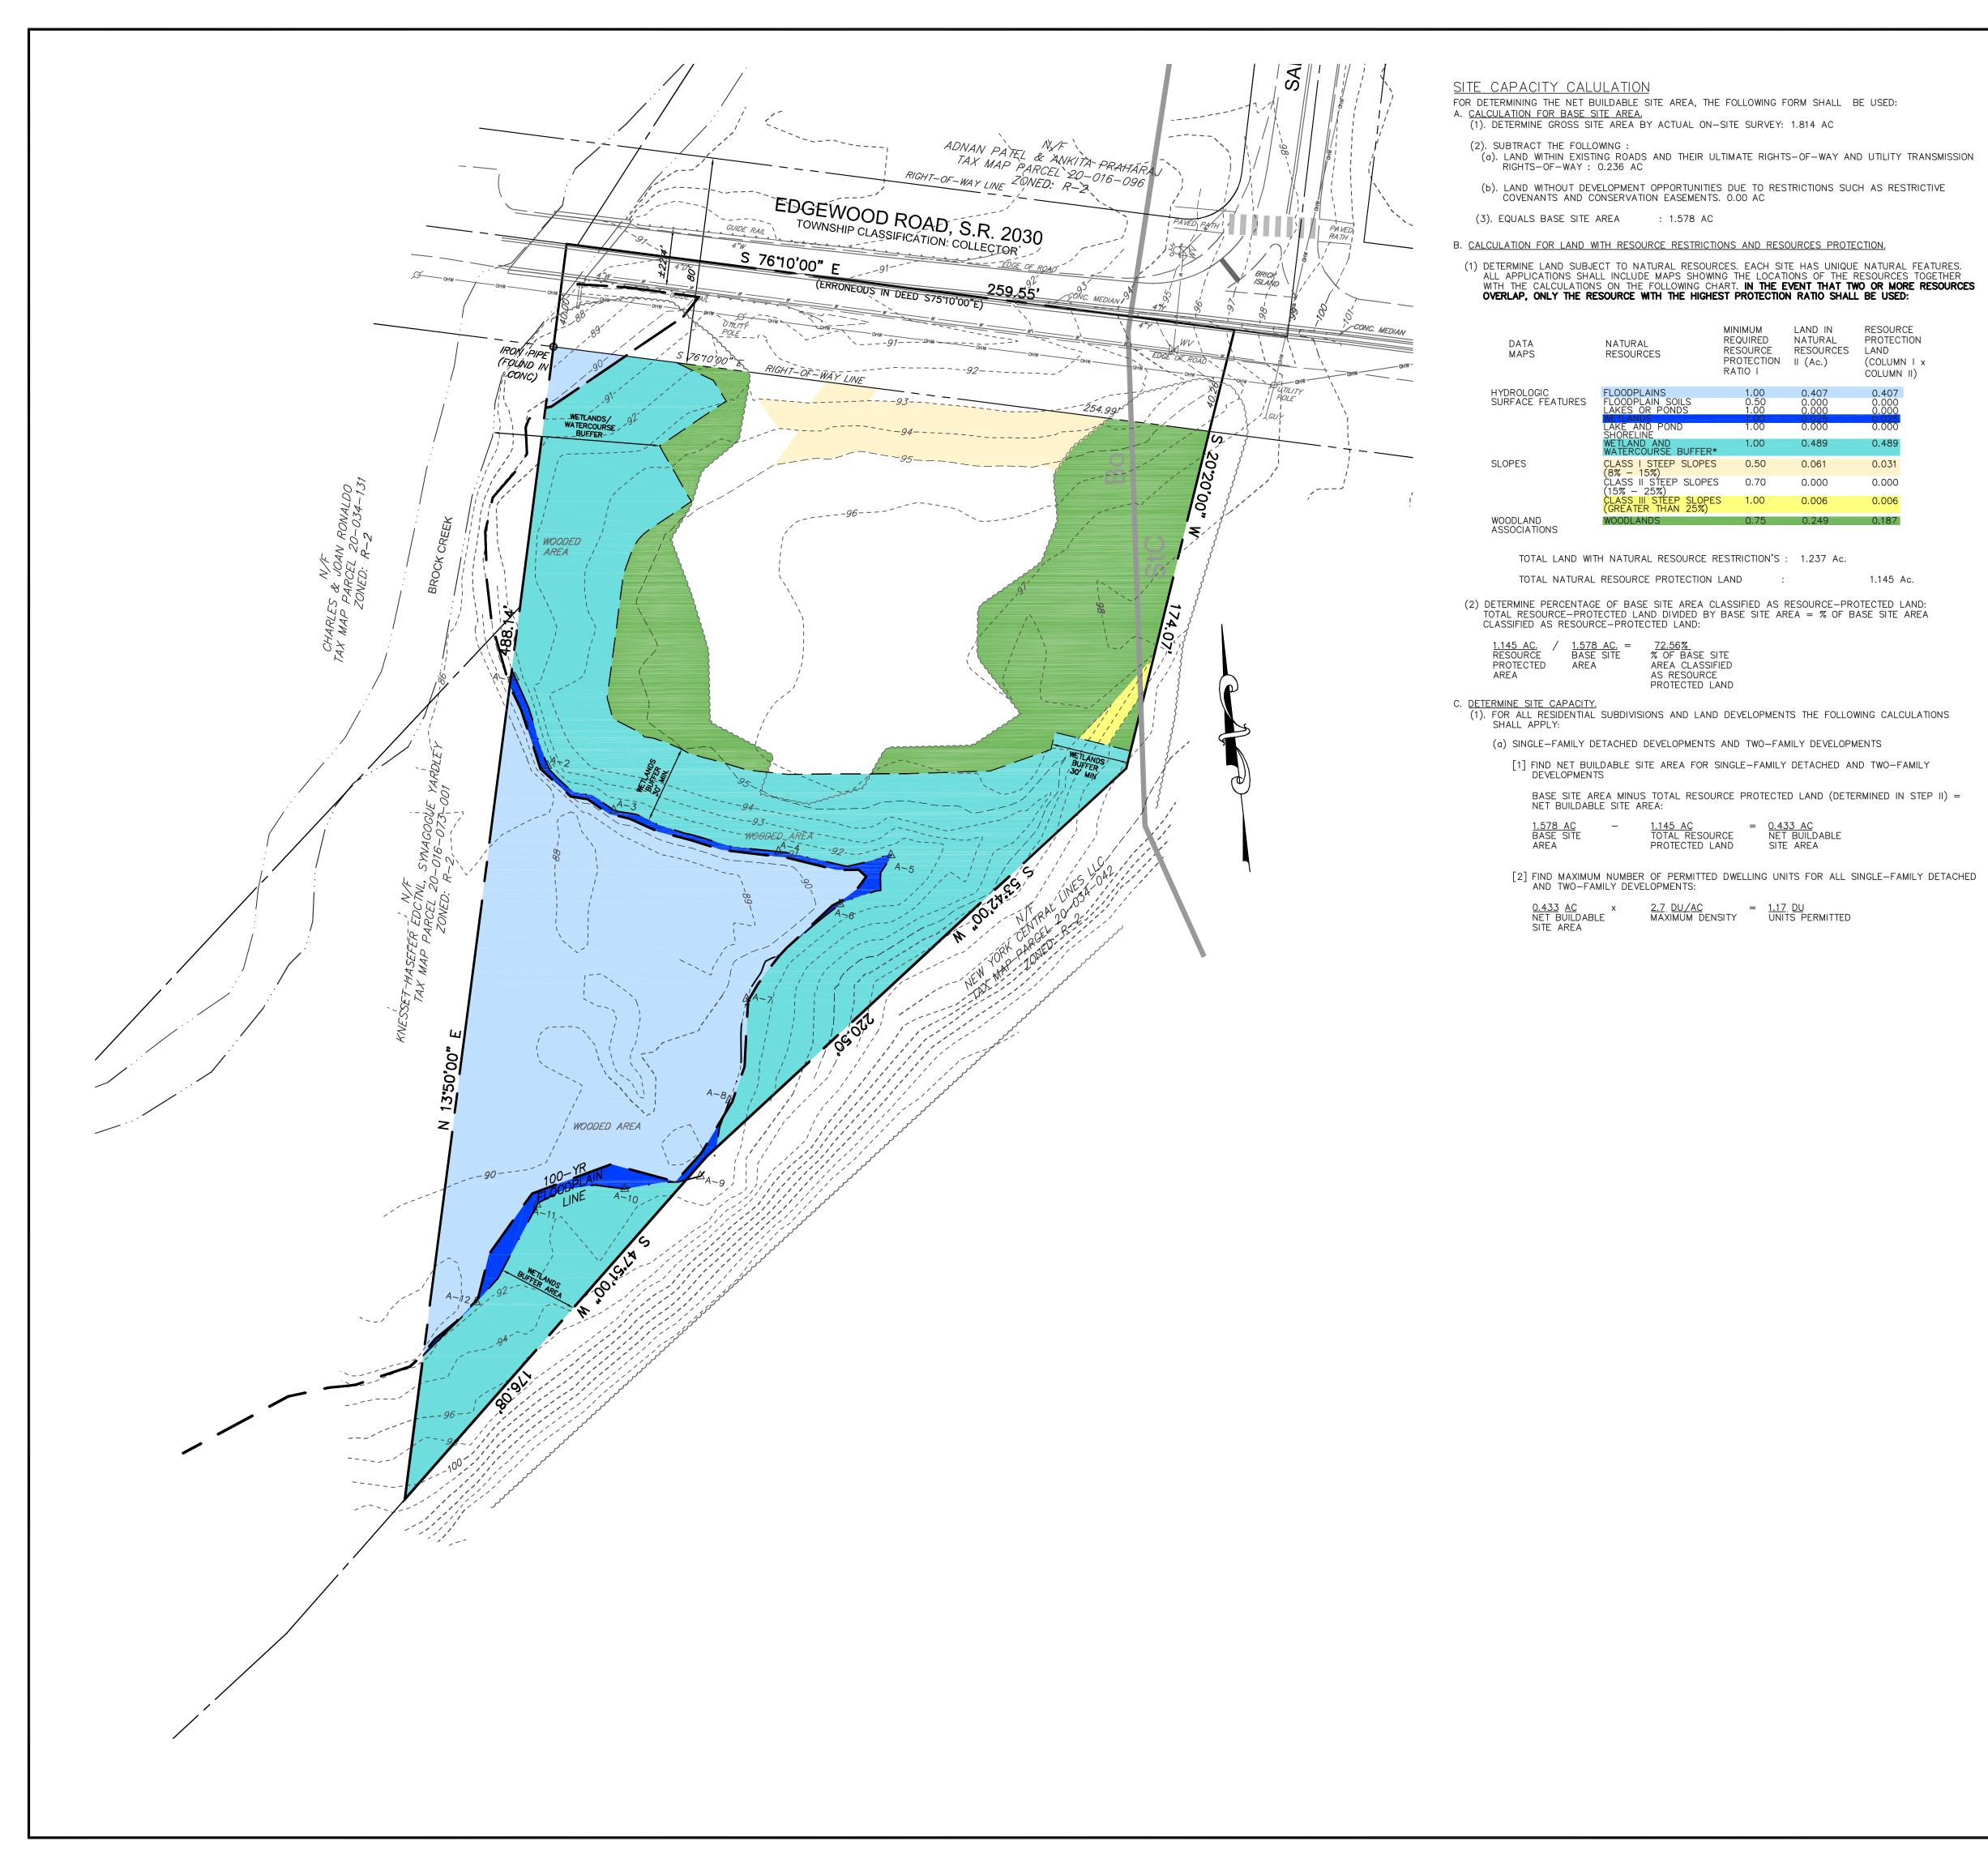

GENERAL NOTES:

LAND IN RESOURCE

PROTECTION

(COLUMN I x

COLUMN II)

NATURAL

RESOURCE RESOURCES LAND

PROTECTION II (Ac.)

MINIMUM REQUIRED

AREA CLASSIFIED AS RESOURCE PROTECTED LAND

1.145 AC = 0.433 AC TOTAL RESOURCE NET BUILDABLE PROTECTED LAND SITE AREA

 $2.7 \underline{DU/AC}$ = $1.17 \underline{DU}$ UNITS PERMITTED

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