

LOWER MAKEFIELD COMMUNITY CENTER

Oxford Valley Road Lower Makefield Township, PA

ISSUED FOR CONSTRUCTION MARCH 4, 2015





Boucher & James, Inc. 1456 FERRY ROAD, BUILDING 500 DOYLESTOWN, PA 18901 VOICE: 215 | 345 | 9400

SITE/CIVIL

Holstein White, Inc. 210 E. STREET RD., SUITE 2D FEASTERVILLE, PA 19053 VOICE: 215 | 322 | 7711 FAX: 215 | 322 | 7709

/-/////

M.E.P.

Harrison-Hamnett, P.C. Consulting Structural Engineers

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STRUCTURAL

Clarke Caton Hintz © ©









FAX: 609 | 818 | 1809


Landscape Architecture

Historic Preservation

Planning

Architecture

www.clarkecatonhintz.com

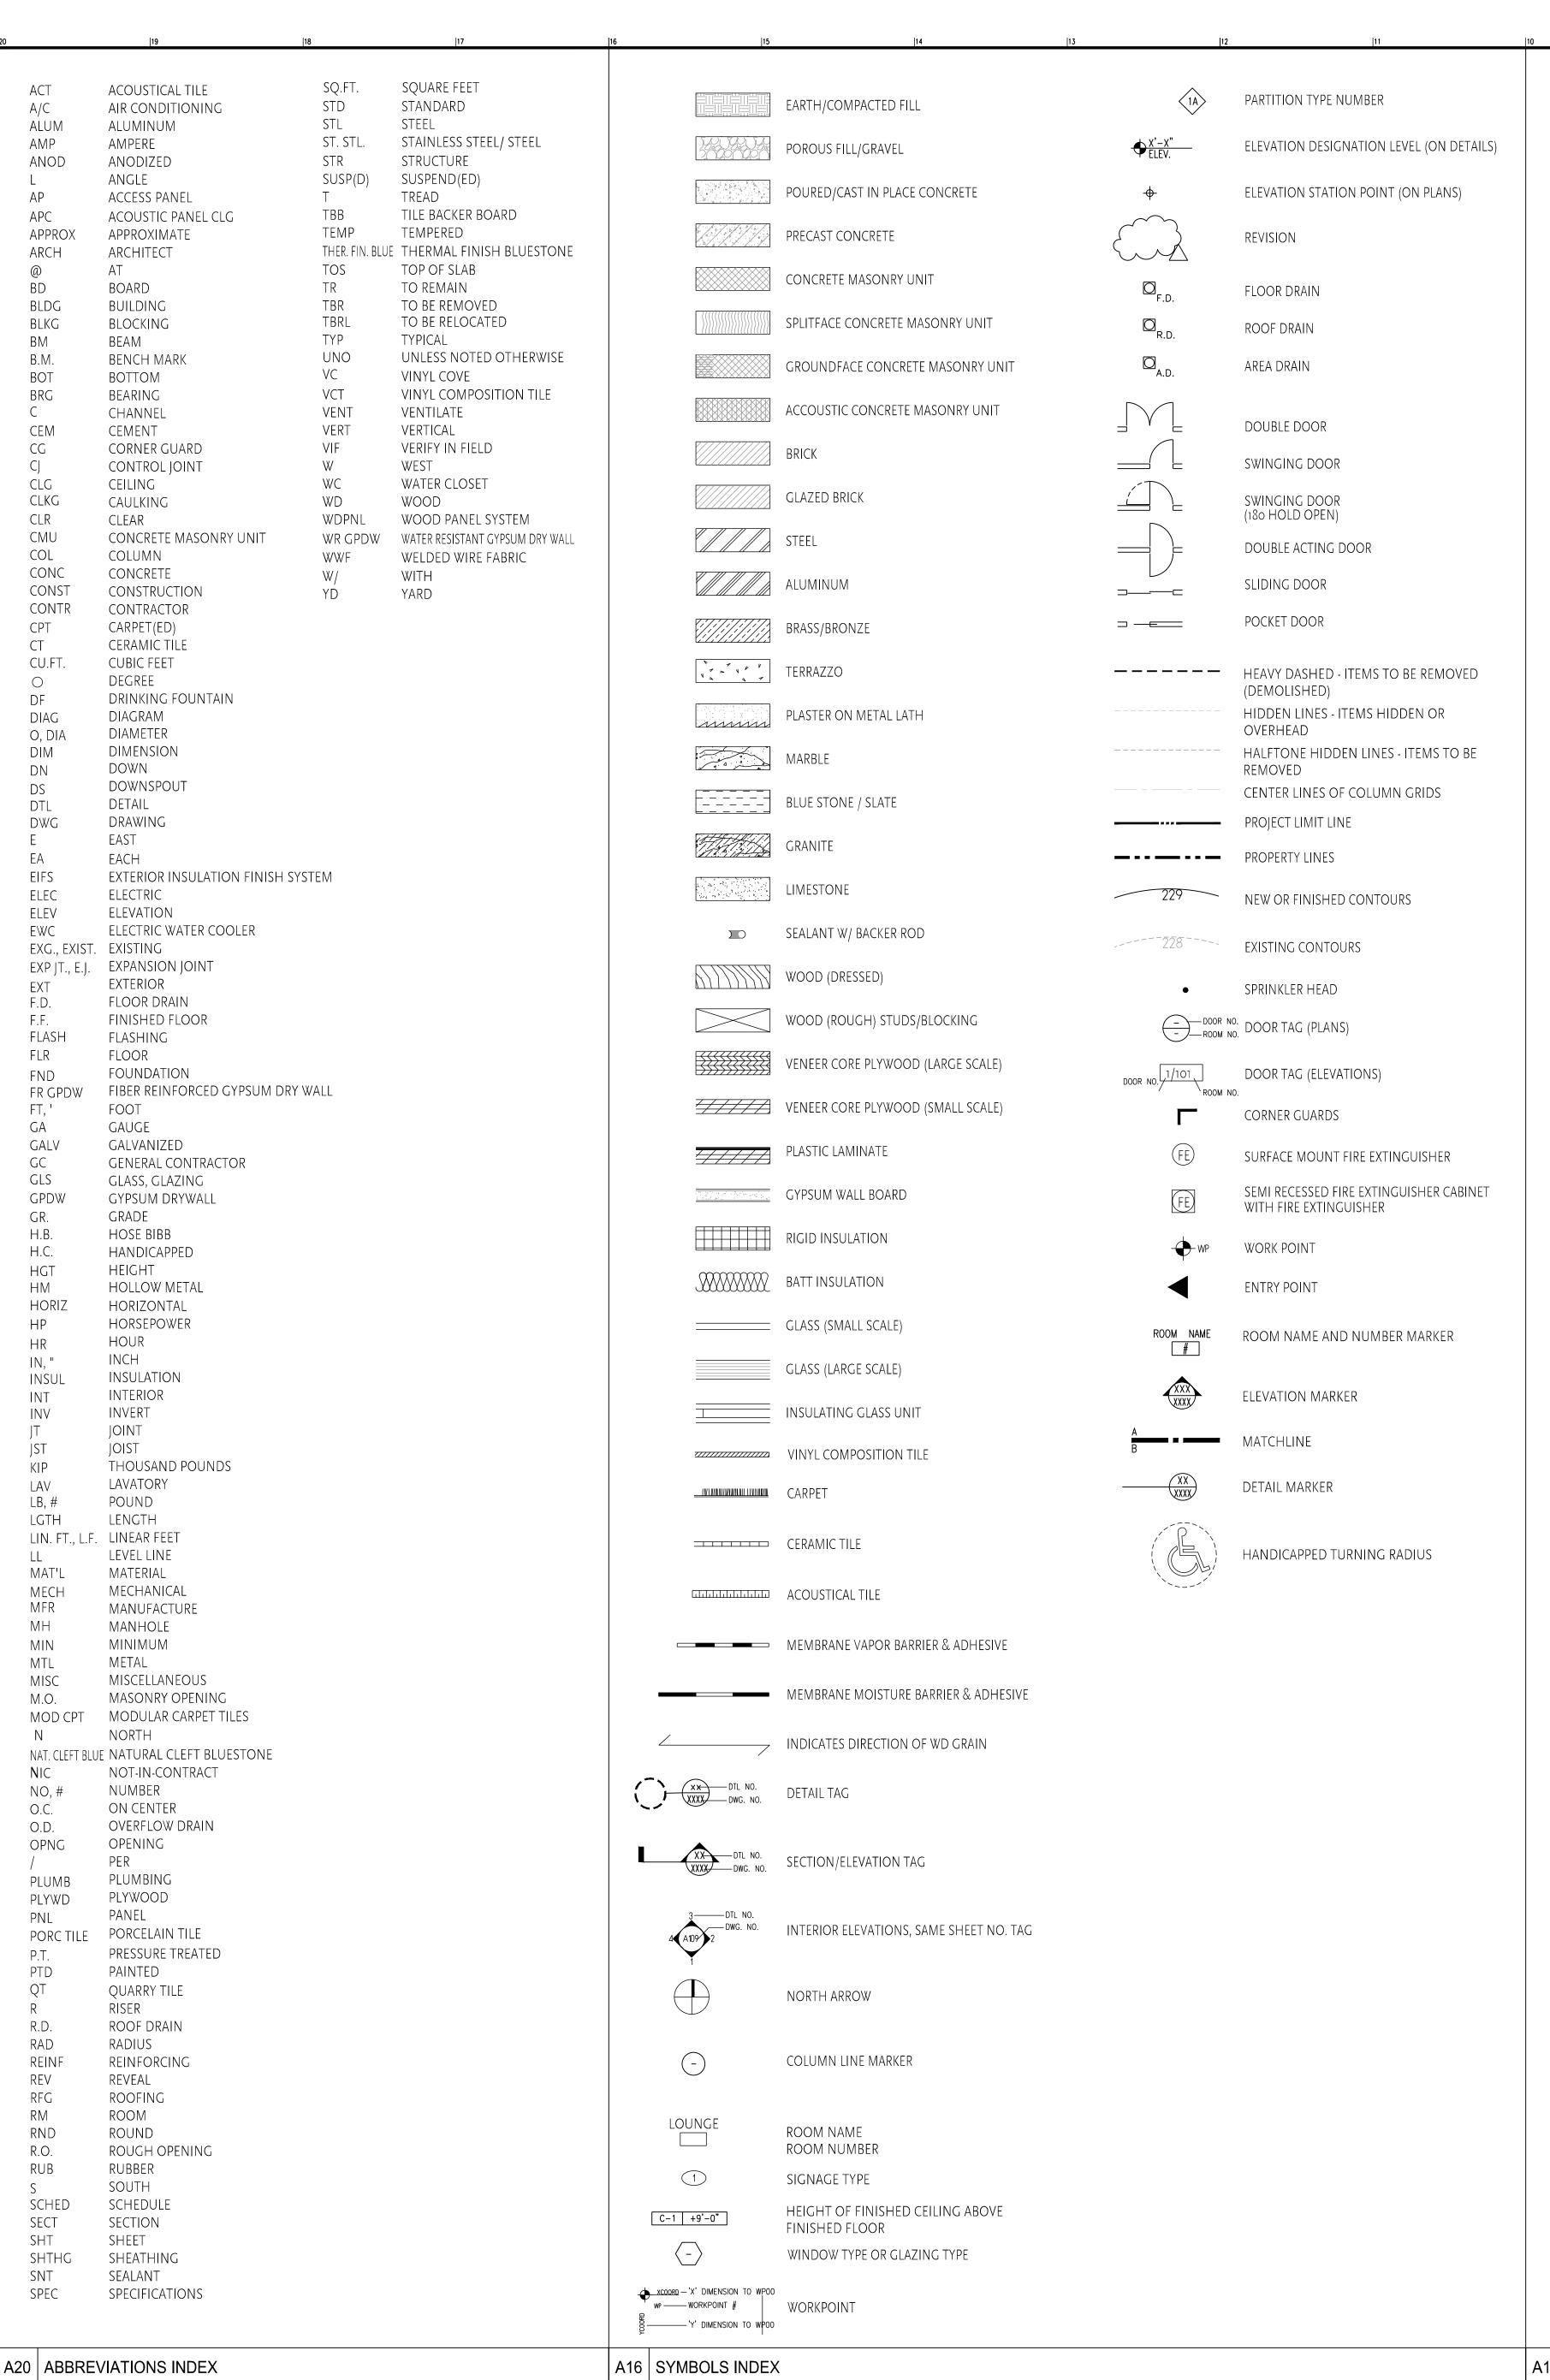

<u>GENERAL NOTES:</u>

- 1. THESE DRAWINGS REPRESENT AN OVERALL DESIGN CONCEPT. THEY ARE PREPARED WITH THE INTENT TO DEMONSTRATE AN OVERALL DESIGN ARRANGEMENT OF THE VARIOUS COMPONENTS OF THE ENTIRE PROJECT. THE CONTRACTOR IS ASSUMED TO HAVING REVIEWED THESE DRAWINGS, AND HAVING SEEN THE SUBJECT PROPERTY, IS CAPABLE OF EXECUTING THE DETAIL WORK NECESSARY TO ACHIEVE THE INTENDED RESULTS IN A MANNER THAT IS CONSISTENT WITH THE QUALITY WORKMANSHIP IN THE REGION. IT IS THE RESPONSIBILITY OF THE CONTRACTOR TO REVIEW THE DRAWINGS, VISIT THE SITE, VERIFY THE EXISTING CONDITIONS, DIMENSIONS, CLEARANCES, Etc., SHOWN ON THE DRAWINGS PRIOR TO BIDDING.
- 2. THESE DRAWINGS ARE THE PROPERTY OF THE ARCHITECT AND SHALL NOT BE USED FOR A BUILDING PERMIT UNLESS SIGNED AND SEALED BY THE ARCHITECT.
- 3. REPRODUCTIONS OF CONTRACT DOCUMENTS ARE NOT ACCEPTABLE AS SHOP DRAWINGS AND MAY BE REJECTED.
- 4. UNLESS OTHERWISE NOTED, GENERAL NOTES REFER TO ALL TYPICAL CONDITIONS THROUGHOUT THE BUILDING. SPECIFIC CONDITIONS REQUIRING CLARIFICATION ARE MARKED DOWN ON PLAN(S).
- 5. NOTIFY ARCHITECT IMMEDIATELY OF ANY DISCREPANCY OR DEVIATION BETWEEN DWGS. AND ANY FIELD VERIFIED CONDITIONS PRIOR TO COMMENCING WORK.
- 6. THE OWNER AND CONTRACTOR SHALL HOLD THE ARCHITECT HARMLESS AGAINST ANY CLAIMS, DAMAGES. LOSSES AND EXPENSES INCLUDING ATTORNEY FEES ARISING OR RESULTING FROM THE PERFORMANCE OF THE WORK BY THE
- 7. THE ARCHITECT IS NOT RESPONSIBLE WHERE CONSTRUCTION DEVIATES FROM PLANS UNLESS APPROVED IN WRITING BY
- 8. DO NOT SCALE DRAWINGS. ALL MEASUREMENTS MUST BE CONFIRMED IN THE FIELD. DIMENSIONS SHOWN ARE FOR REFERENCE ONLY.

9. IF ANY DISCREPANCIES BETWEEN DWGS AND SPECIFICATIONS EXIST, THE MORE STRINGENT SHALL TAKE PRECEDENCE.

- SIMILARLY BETWEEN ARCHITECTURAL PLANS AND VARIOUS ENGINEERING DISCIPLINES. 10. CONTRACTOR SHALL FIELD VERIFY ALL DIMENSIONS PRIOR TO COMMENCEMENT OF THE WORK. DO NOT SCALE
- DRAWINGS. IF A DIMENSION IS UNCLEAR OR A DISCREPANCY IS FOUND, NOTIFY THE ARCHITECT BEFORE PROCEEDING WITH THE WORK.
- 11. DETAILS AND SECTIONS ON THE DRAWINGS ARE SHOWN AT SPECIFIC LOCATIONS AND ARE INTENDED TO SHOW GENERAL REQUIREMENTS THROUGHOUT. CONDITIONS NOT SPECIFICALLY SHOWN SHALL BE CONSTRUCTED IN A SIMILAR FASHION OR BROUGHT TO THE ATTENTION OF THE ARCHITECT FOR CLARIFICATION. MODIFICATIONS MAY BE REQUIRED BY THE CONTRACTOR TO ACCOMMODATE FOR MINOR VARIATIONS.
- 12. CONTRACTOR TO FIELD VERIFY EXTENT OF WORK PRIOR TO BID.
- 13. SUBMIT STAGING PLANS AND CONSTRUCTION SCHEDULE FOR ARCHITECT'S AND OWNER'S REVIEW PRIOR TO COMMENCING WORK.
- 14. ALL CONTRACTORS SHALL MAINTAIN CONTRACTORS LIABILITY, PROPERTY DAMAGE AND WORKMAN'S COMPENSATION INSURANCE.
- 15. ALL CODES HAVING JURISDICTION SHALL BE OBSERVED STRICTLY IN THE CONSTRUCTION OF THE PROJECT, INCLUDING ALL APPLICABLE STATE, CITY, AND COUNTY BUILDING, ZONING, ELECTRICAL, MECHANICAL, PLUMBING, AND FIRE CODES. THE CONTRACTOR SHALL VERIFY ALL CODE REQUIREMENTS BEFORE COMMENCEMENT OF CONSTRUCTION AND BRING ANY DISCREPANCIES BETWEEN CODE REQUIREMENTS AND THE CONSTRUCTION DOCUMENTS TO THE ATTENTION OF THE
- 16. UTILIZE OSHA SAFETY PRECAUTIONS AS REQUIRED. CONTRACTOR TO PROVIDE OWNER/ARCHITECT WITH COPIES OF ALL MINUTES/SIGN-IN SHEETS FOR "TOOL BOX" TALKS ON A MONTHLY BASIS. SUBMISSION IS A CONDITION OF RELEASE OF PAYMENT.
- 17. ALL WALLS SHALL BE BRACED DURING CONSTRUCTION UNTIL PERMANENTLY RESTRAINED.
- 18. INSTALL TEMPORARY SHORING & BRACING AND MAKE SAFE ALL WALLS, CEILINGS, AND DOORS AS REQUIRED.
- 19. MAINTAIN PROTECTED EGRESS AND ACCESS TO WORK.
- 20. ALL EQUIPMENT MUST MEET LOCAL NOISE ORDINANCES.
- 21. GENERAL CONTRACTOR TO VERIFY ALL DIMENSIONS AND QUANTITIES PRIOR TO ORDERING, FABRICATING OR CONSTRUCTING ANY PART OF THE BUILDING. NOTIFY ARCHITECT IMMEDIATELY WITH ANY AND ALL DISCREPANCIES.
- 22. REFER TO ELECTRICAL DRAWINGS, AND REFLECTED CEILING PLANS FOR TYPES AND LOCATIONS OF LIGHT FIXTURES, TYP. CONTRACTOR TO COORDINATE WITH MEP DRAWINGS.
- 23. SEE M/E/P DWGS FOR ALL FLOOR, ROOF, CEILING, AND WALL OPENINGS. GENERAL CONTRACTOR TO COORDINATE LOCATION OF OPENINGS IN FIELD WITH ARCHITECT.
- 24. NON-COMBUSTIBLE PIPES, VENTS, AND FLUES SHALL BE FIRESTOPPED, WHEN THEY PASS THRU THE FLOOR/CEILING
- ASSEMBLY OR THRU RATED WALLS.
- 25. PROVIDE DUST CONTROL AS REQUIRED. SEE SPECIFICATION FOR MORE INFORMATION, TYP.
- 26. NOTIFY OWNER/ARCHITECT 72 HOURS MINIMUM IN ADVANCE OF ANY UTILITY SHUT-OFFS. 27. GENERAL CONTRACTOR TO COORDINATE WITH OTHER CONTRACTS ON SITE HIRED UNDER SEPARATE CONTRACT.
- 28. UNLESS NOTED OTHERWISE, ALL NEW ITEMS SHALL BE FURNISHED BY THE GENERAL CONTRACTOR.
- 29. THE GENERAL CONTRACTOR SHALL PROVIDE CHASES AND RECESSES AS SHOWN, AND AS REQUIRED, TO CONCEAL THE
- WORK OF OTHER TRADES.
- 30. REFER TO THE FIRE RESISTANCE DIRECTORY (LATEST EDITION) BY UNDERWRITERS LABORATORIES FOR CHARACTERISTICS OF ALL SPECIFIED FIRE RATED ASSEMBLIES.
- 31. GENERAL CONTRACTOR TO COORDINATE THE LOCATION OF ALL OUTLETS AND RECEPTACLES WITH CASEWORK. SEE
- ELECTRICAL DRAWINGS FOR ADDITIONAL INFORMATION. CONTACT ARCHITECT WITH ANY CONFLICTING LOCATIONS.
- 32. INSTALL ALL INSULATION WITH VAPOR BARRIER ON THE WARM (WINTER) SIDE, TYP.
- 33. CONTRACTOR SHALL VERIFY ALL REQUIRED ROUGH OPENINGS WITH MANUFACTURERS PRIOR TO START OF ANY CONSTRUCTION AND COORDINATE ANY DISCREPANCIES ON THE PLANS WITH THE RESPECTIVE TRADES.
- 34. ALL WALL PENETRATIONS SHALL BE PATCHED, SEALED, AND FIRE STOPPED AS REQUIRED BY THE RESPECTIVE TRADES.
- 35. REFER TO M.E.P DRAWINGS FOR LOCATIONS OF M.E.P. EQUIPMENT.
- 36. GENERAL CONTRACTOR MUST COORDINATE LOCATION OF PIPING / ELECTRICAL WITH PLUMBING AND/OR ELECTRICAL DEVICES, OUTLETS, THERMOSTATS, ETC. RELOCATE ELECTRICAL DEVICES TO CHASE WALL WHERE OVERLAP OCCURS.
- 37. INSTALL ALL FIXTURES, MATERIALS, AND FINISHES IN STRICT COMPLIANCE WITH MANUFACTURER'S TECHNICAL SPECIFICATIONS, TYP.
- 38. CONTRACTOR RESPONSIBLE FOR ALL UTILITY HOOK-UPS.
- 39. PROPERLY TEST, BALANCE, AND ADJUST ALL EQUIPMENT AND SYSTEMS USED IN THE PROCESS OF COMPLETING THE SCOPE OF WORK. SUBMIT AIR BALANCING REPORT AS A CONDITION OF FINAL PAYMENT.
- 40. ALL DIMENSIONS TAKEN FROM FACE OF FINISH UNLESS NOTED OTHERWISE.
- 41. REFER TO WALL TYPES FOR THOSE WALLS INDICATED TO RECEIVE SOUND ATTENUATION BATT INSULATION.
- 42. FIRESTOP AS REQUIRED ALL PENETRATIONS THRU FIRE RATED WALLS.
- 43. SEE FLOOR PLANS FOR WINDOW AND DOOR DESIGNATIONS.

SPACES. DIAGONAL RUNS ARE PROHIBITED.

44. INSTALL EXPOSED ELECTRIC, MECHANICAL AND PLUMBING SYSTEMS, MATERIALS AND EQUIPMENT LEVEL AND PLUMB, PARALLEL AND PERPENDICULAR TO OTHER SYSTEMS AND COMPONENTS WHERE INSTALLED IN EXPOSED UNFINISHED

DWG.NO.	DWG.NO. DRAWING TITLE	
GENERAL		
CS	COVER SHEET	N.T.S.
G-001	GENERAL INFORMATION	N.T.S.
G-002	ADA CLEARANCES AND FIXTURE MOUNTING HEIGHTS	N.T.S.
G-003	WALL PARTITION TYPES	N.T.S.
LIFE AND	SAFETY	
LS-101	LIFE SAFETY AND CODE ANALYSIS	AS NOTE
ARCHITEC	TURALS	
A-100	FIRST FLOOR PLAN	AS NOTE
A-101	ROOF PLAN	AS NOTE
A-102	ROOF DETAILS	AS NOTE
A-201	EXTERIOR ELEVATIONS	AS NOTE
A-202	EXTERIOR ELEVATIONS	AS NOTE
A-301	BUILDING SECTIONS	AS NOTE
A-302	BUILDING SECTIONS	AS NOTE
A-303	BUILDING SECTIONS	AS NOTE
A-401	INTERIOR ELEVATIONS	AS NOTE
A-402	INTERIOR ELEVATIONS	AS NOTE
A-403	INTERIOR ELEVATIONS	AS NOTE
A-404	INTERIOR ELEVATIONS	AS NOTE
A-601	WALL SECTIONS	AS NOTE
A-602	WALL SECTIONS	AS NOTE
A-603	WALL SECTIONS	AS NOTE
A-604	WALL SECTIONS	AS NOTE
A-701	DETAILS	AS NOTE
A-702	DETAILS	AS NOTE
A-703	DETAILS	AS NOTE
A-801	REFLECTED CEILING PLAN	AS NOTE
A-901	DOOR SCHEDULE AND DETAILS	AS NOTE
A-902	WINDOW SCHEDULE AND DETAILS	AS NOTE
A-1000	FIRST FLOOR FINISH PLAN	AS NOTE
A-1100	MILLWORK DETAILS	AS NOTE
A-1101	MILLWORK DETAILS	AS NOTE
A-1102	MILLWORK DETAILS	AS NOTE
STRUCTU	RAL	
S-101	FOUNDATION PLAN	AS NOTE
S-102	ROOF FRAMING PLAN	AS NOTE
S-103	TYPICAL DETAILS AND GENERAL NOTES	AS NOTE
MECHANIC	CAL	
M1.0	MECHANICAL FLOOR PLAN	AS NOTE
M2.0	MECHANICAL ROOF PLAN	AS NOTE
M3.0	MECHANICAL SCHEDULES AND DETAILS	AS NOTE
PLUMBING		
P1.0	PLUMBING FLOOR PLAN - SANITARY	AS NOTE
P1.1	PLUMBING FLOOR PLAN - DOMESTIC WATER	AS NOTE
P2.0	PLUMBING SCHEDULES AND DETAILS	AS NOTE
D2 1	DITIMPING FLOOD DIACDAMS	AS NOTE

DWG.NO.	DRAWING TITLE	SCALE
GENERAL		·
CS	COVER SHEET	N.T.S.
G-001	GENERAL INFORMATION	N.T.S.
G-002	ADA CLEARANCES AND FIXTURE MOUNTING HEIGHTS	N.T.S.
G-003	WALL PARTITION TYPES	N.T.S.
LIFE AND	SAFETY	
LS-101	LIFE SAFETY AND CODE ANALYSIS	AS NOTED
ARCHITEC	TURALS	
A-100	FIRST FLOOR PLAN	AS NOTED
A-101	ROOF PLAN	AS NOTED
A-102	ROOF DETAILS	AS NOTED
A-201	EXTERIOR ELEVATIONS	AS NOTED
A-202	EXTERIOR ELEVATIONS	AS NOTED
A-301	BUILDING SECTIONS	AS NOTED
A-302	BUILDING SECTIONS	AS NOTED
A-303	BUILDING SECTIONS	AS NOTED
A-401	INTERIOR ELEVATIONS	AS NOTED
A-402	INTERIOR ELEVATIONS	AS NOTED
A-403	INTERIOR ELEVATIONS	AS NOTED
A-404	INTERIOR ELEVATIONS	AS NOTED
A-601	WALL SECTIONS	AS NOTED
A-602	WALL SECTIONS	AS NOTED
4-603	WALL SECTIONS	AS NOTED
A-604	WALL SECTIONS	AS NOTED
A-701	DETAILS	AS NOTED
A-702	DETAILS	AS NOTED
A-703	DETAILS	AS NOTED
<u>4-801</u>	REFLECTED CEILING PLAN	AS NOTED
<u>4-901</u>	DOOR SCHEDULE AND DETAILS	AS NOTED
A-902	WINDOW SCHEDULE AND DETAILS	AS NOTED AS NOTED
<u>A-1000</u>	FIRST FLOOR FINISH PLAN	
<u>A-1100</u>	MILLWORK DETAILS	AS NOTED
A-1101	MILLWORK DETAILS	AS NOTED
A-1102 Structuf	MILLWORK DETAILS	AS NOTED
		AC NOTED
S-101	FOUNDATION PLAN	AS NOTED
S-102	ROOF FRAMING PLAN	AS NOTED
S-103	TYPICAL DETAILS AND GENERAL NOTES	AS NOTED
MECHANIC		
M1.0	MECHANICAL FLOOR PLAN	AS NOTED
M2.0	MECHANICAL ROOF PLAN	AS NOTED
M3.0	MECHANICAL SCHEDULES AND DETAILS	AS NOTED
PLUMBING		
P1.0	PLUMBING FLOOR PLAN — SANITARY	AS NOTED
P1.1	PLUMBING FLOOR PLAN - DOMESTIC WATER	AS NOTED
P2.0	PLUMBING SCHEDULES AND DETAILS	AS NOTED
P2.1	PLUMBING FLOOR DIAGRAMS	AS NOTED
ELECTRIC		
E0.1	SITE LAYOUT AND DETAILS	AS NOTED
E1.0	ELECTRICAL FLOOR PLAN - POWER	AS NOTED
E1.1	ELECTRICAL FLOOR PLAN - LIGHTING	AS NOTED
E3.0	ELECTRICAL SCHEDULES AND DETAILS	AS NOTED

Boucher & James, Inc. 1456 Ferry Road, Building 500 Dovlestown, PA 18901 (215) 345-9400 www.bjengineers.com Harrison-Hamnett, P.C. 40 Knowles Street Pennington, NJ 08534 (609) 818-1808 www.hhpccse.com Holstein White, Inc. 210 E. Street Road, Suite 2d Feasterville, PA 19053 (215) 322-7711 www.holsteinwhite.com . DATE DESCRIPTION 3/4/2015 ISSUED FOR CONSTRUCTION

Township of Lower Makefield

SITE / CIVIL/GEOTECHNICAL/ENVIRONMENTAL:

1100 Edgewood Road

Yardley, PA 19067

(267) 274-1100

Makefield unity Center 20-34-47 Lower Communate TMP TIMP Awood Road 8

3/4/201 TR, ER DRAWN BY: CHECKED BY: MJH, GH


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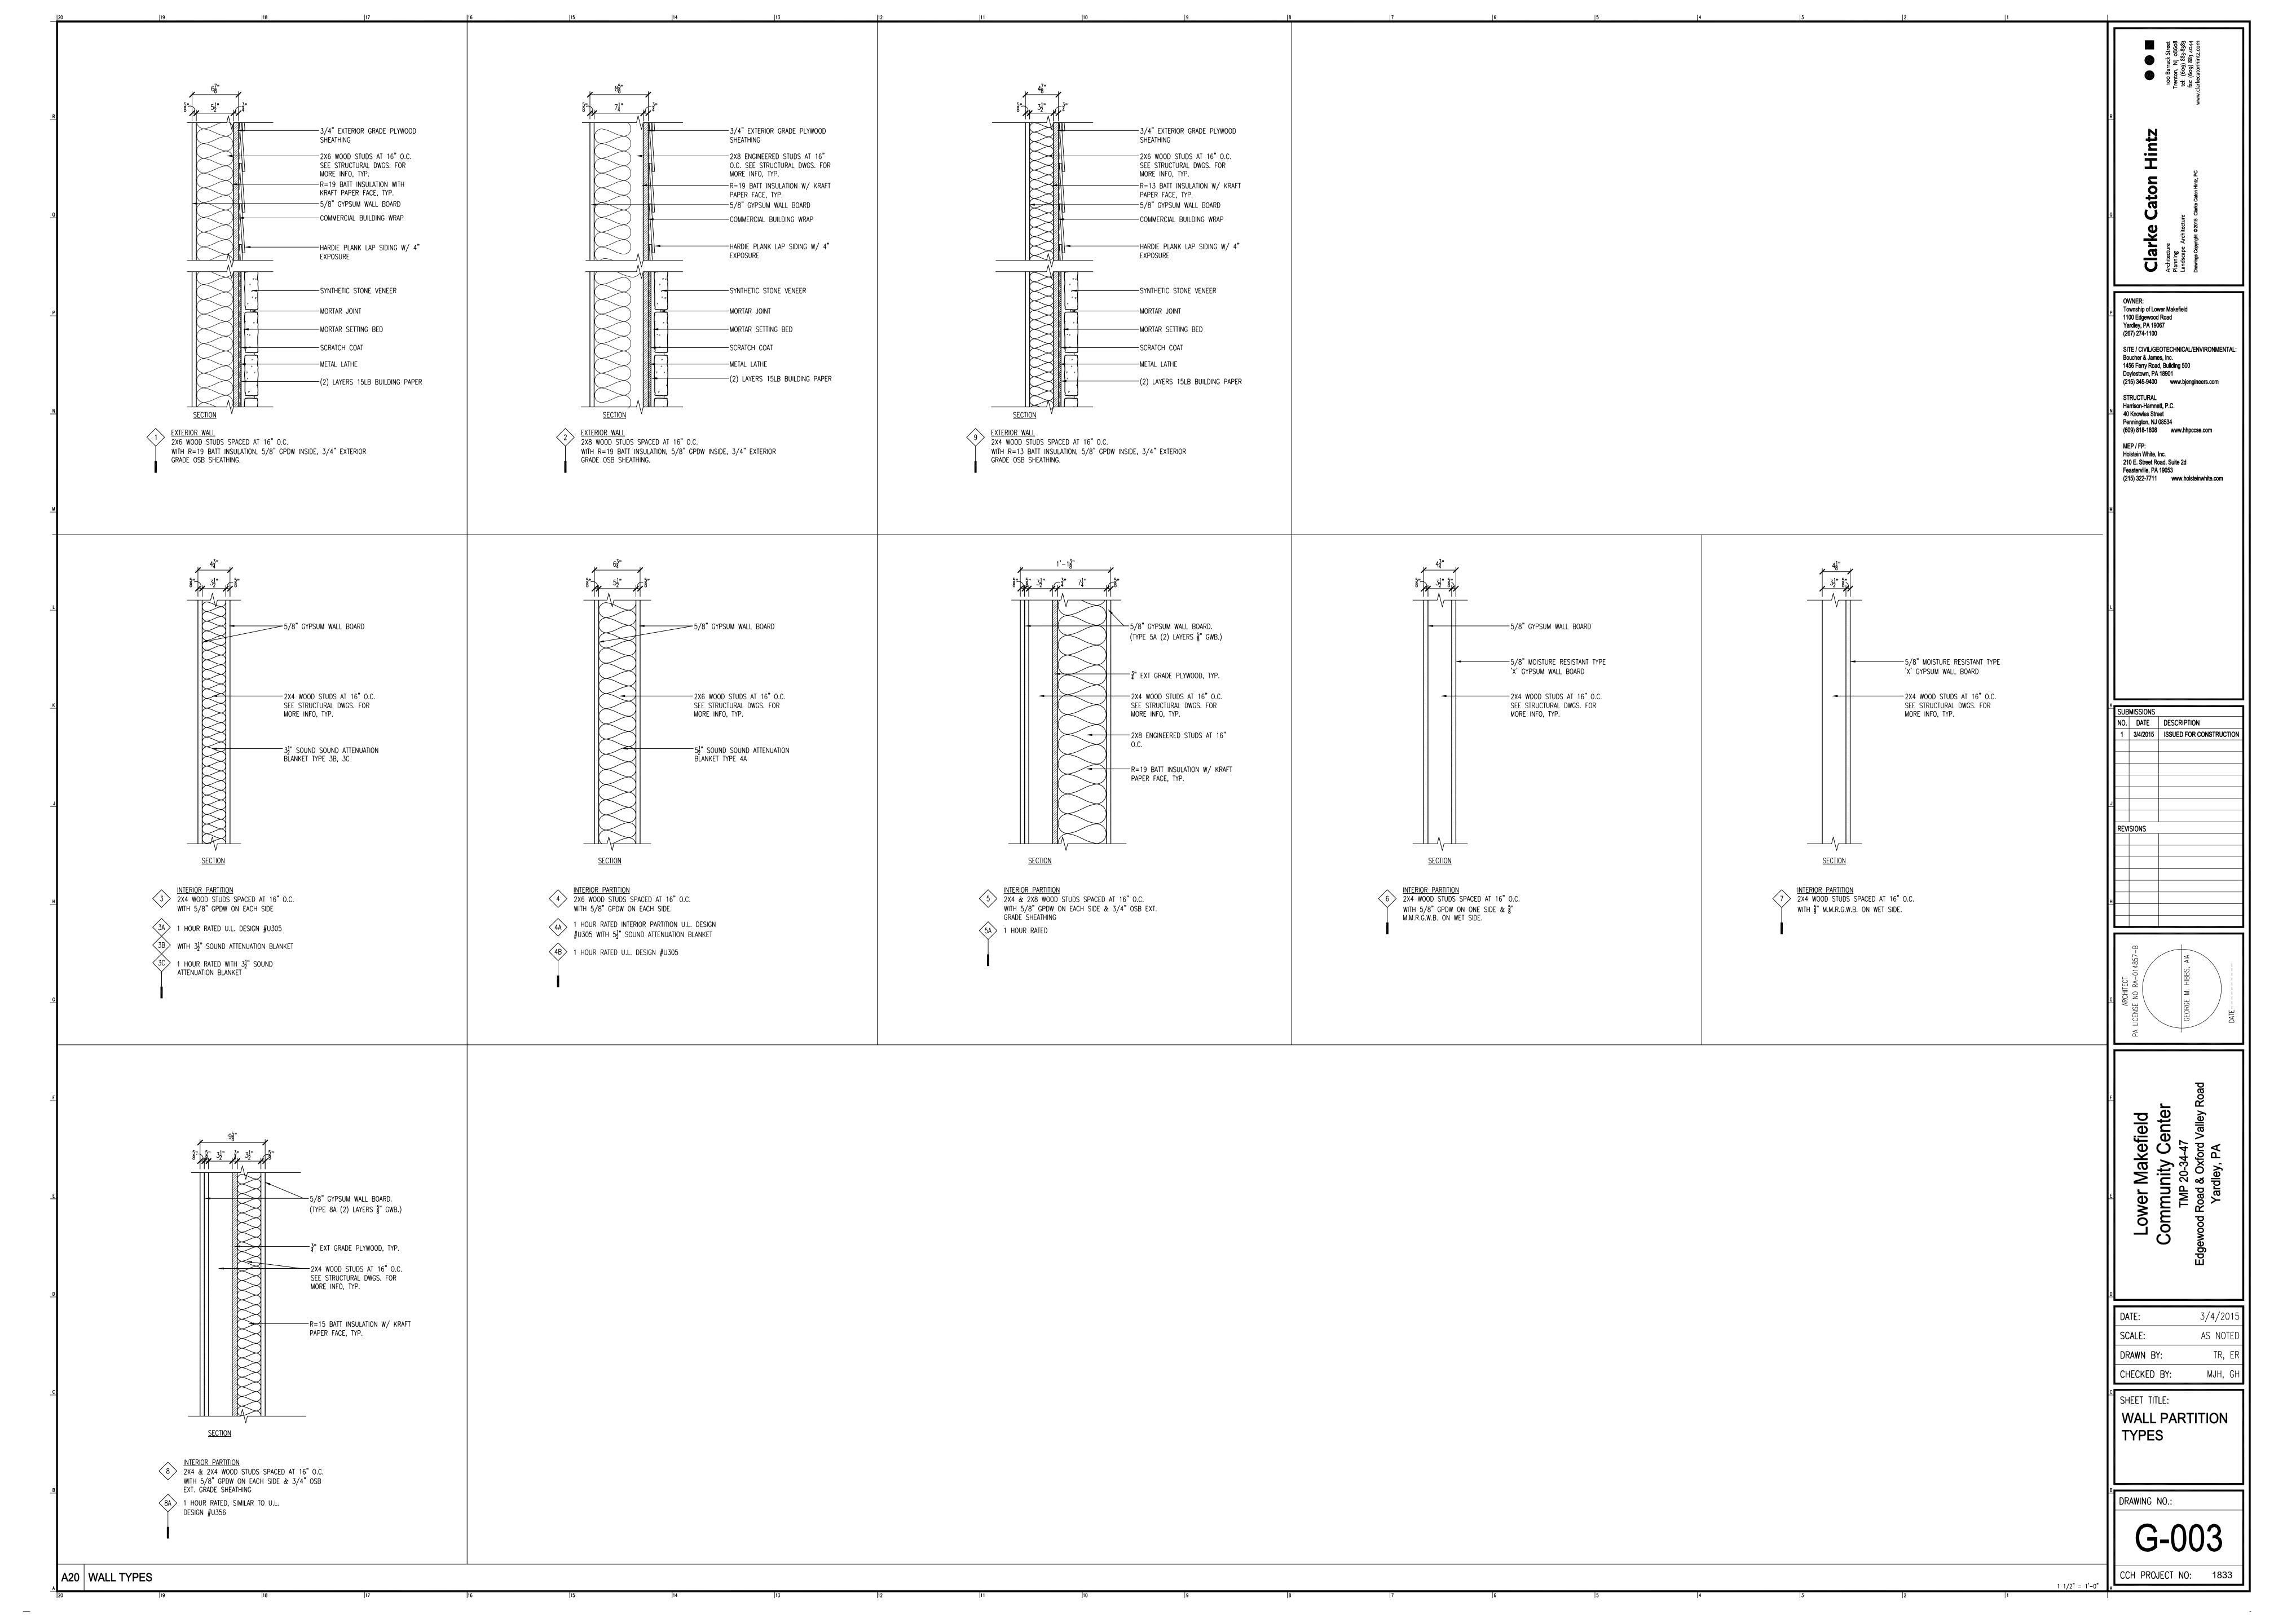
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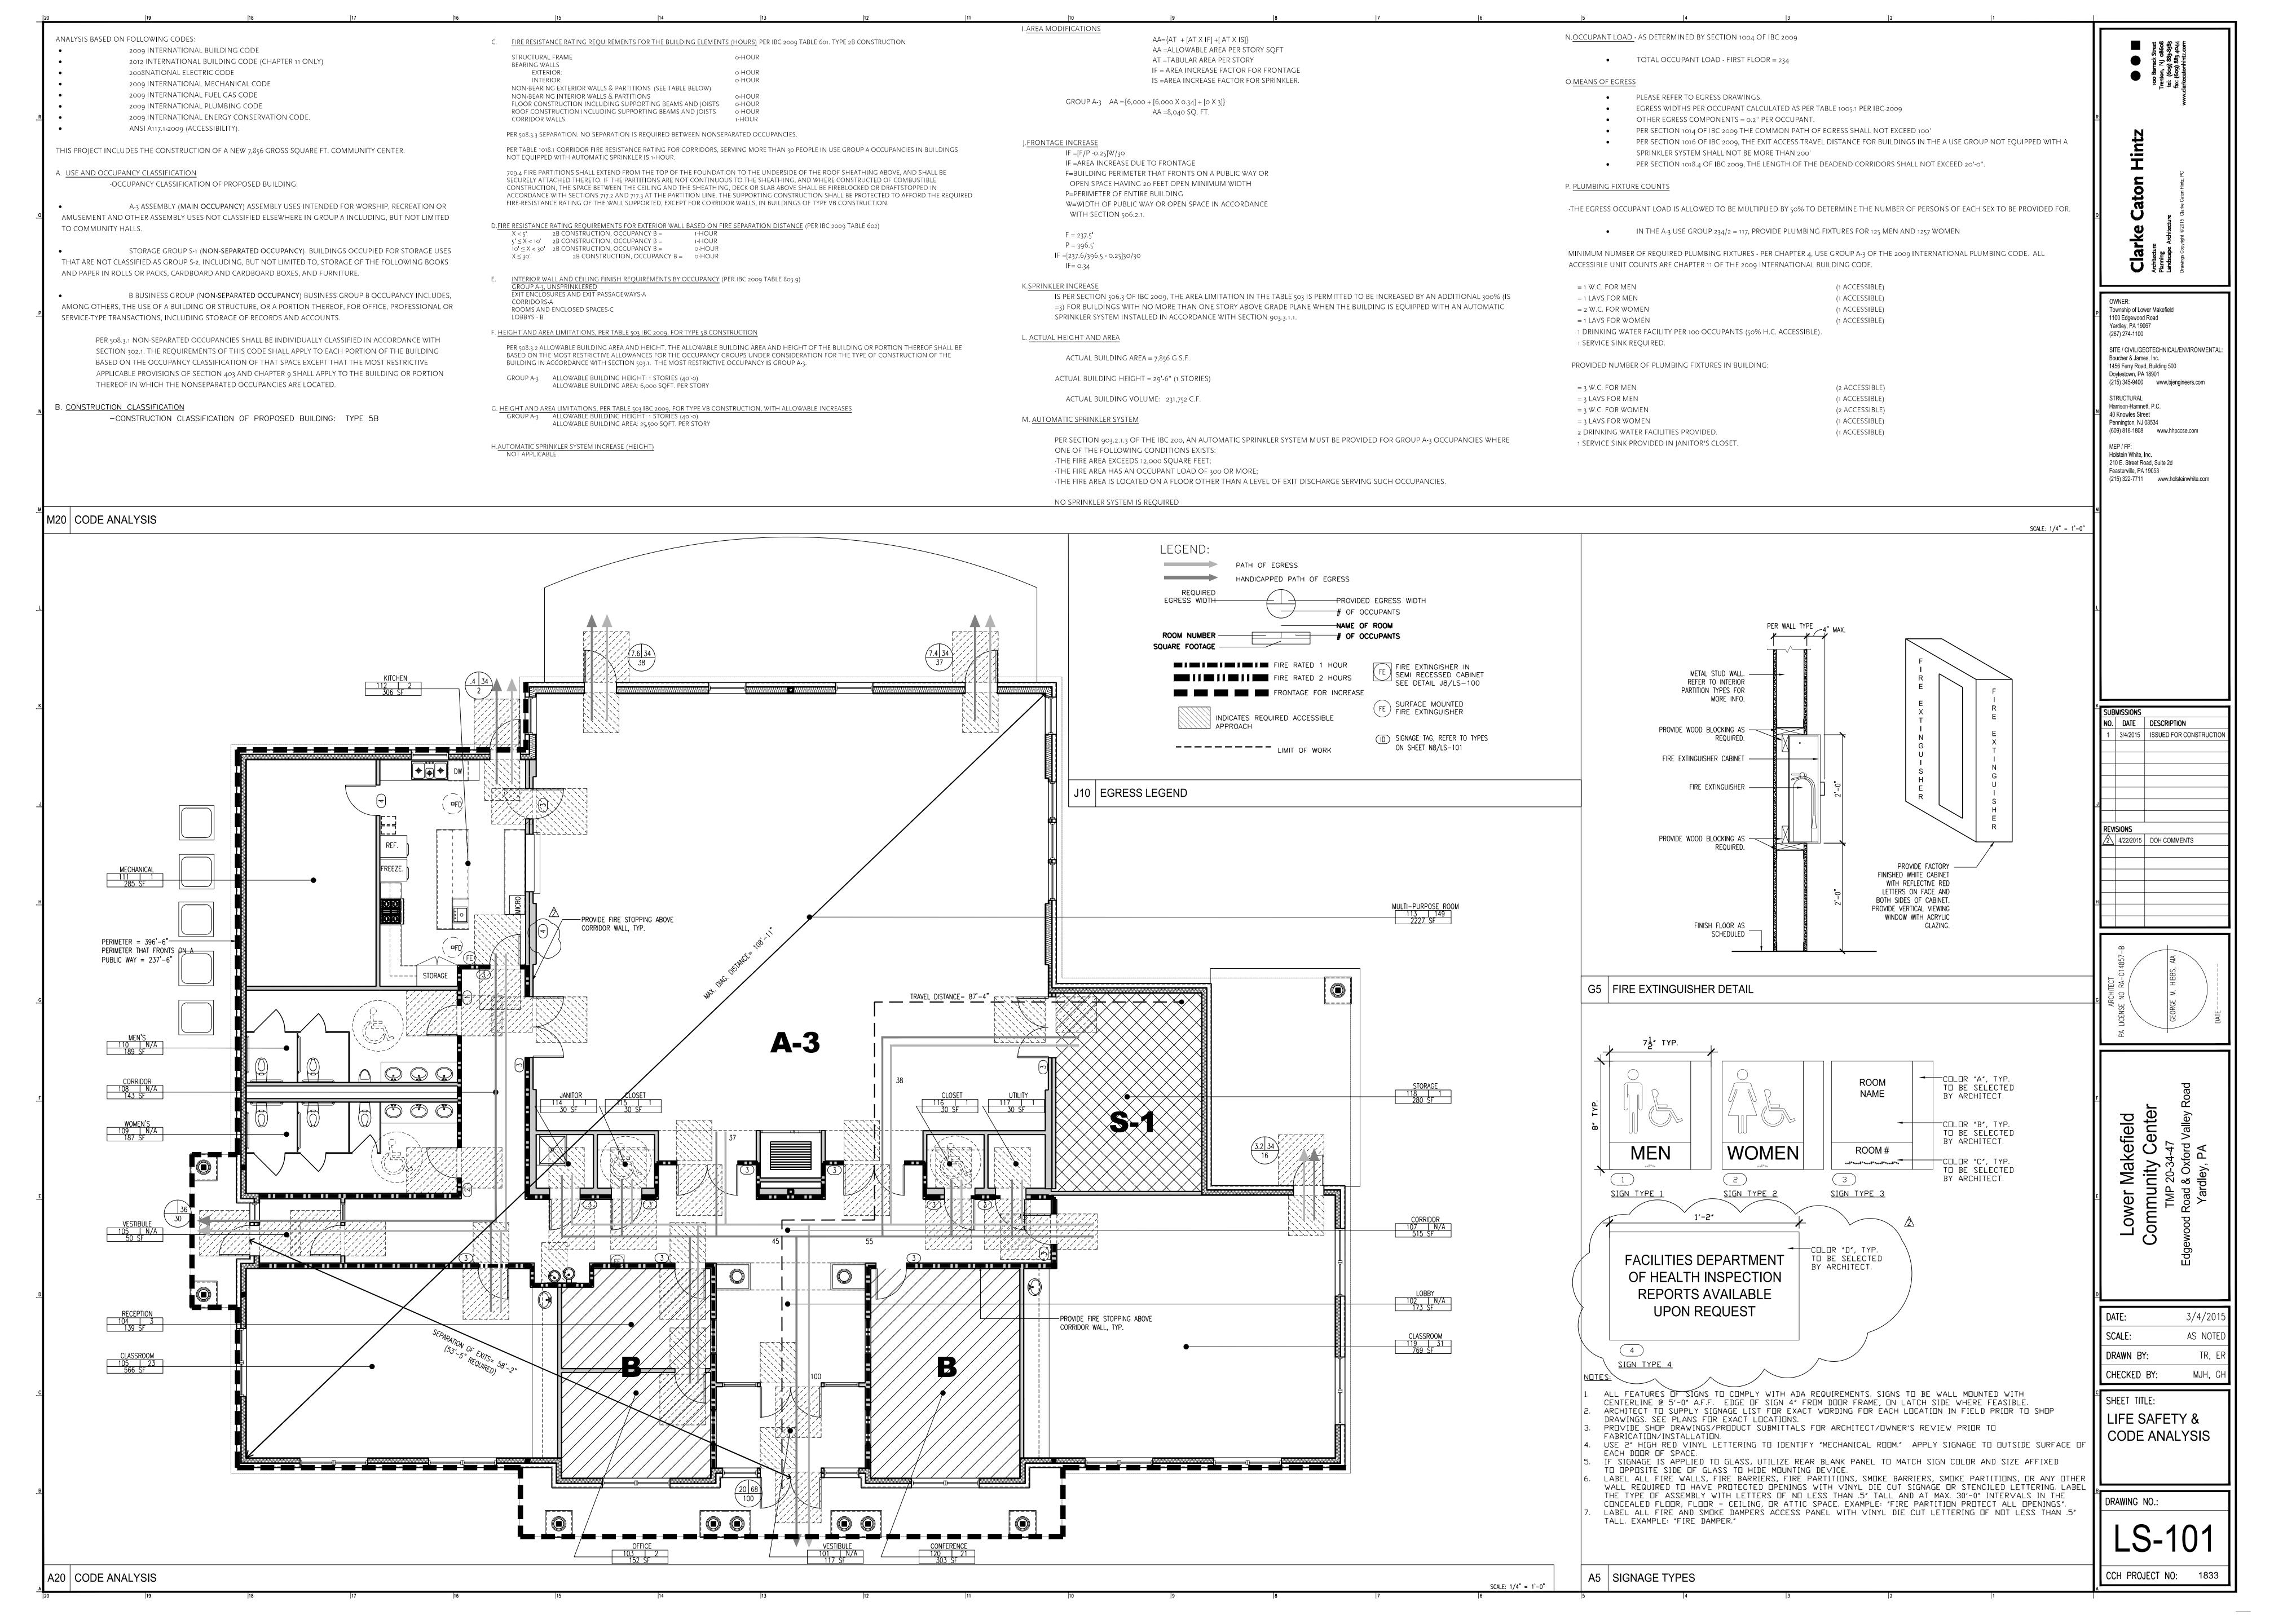
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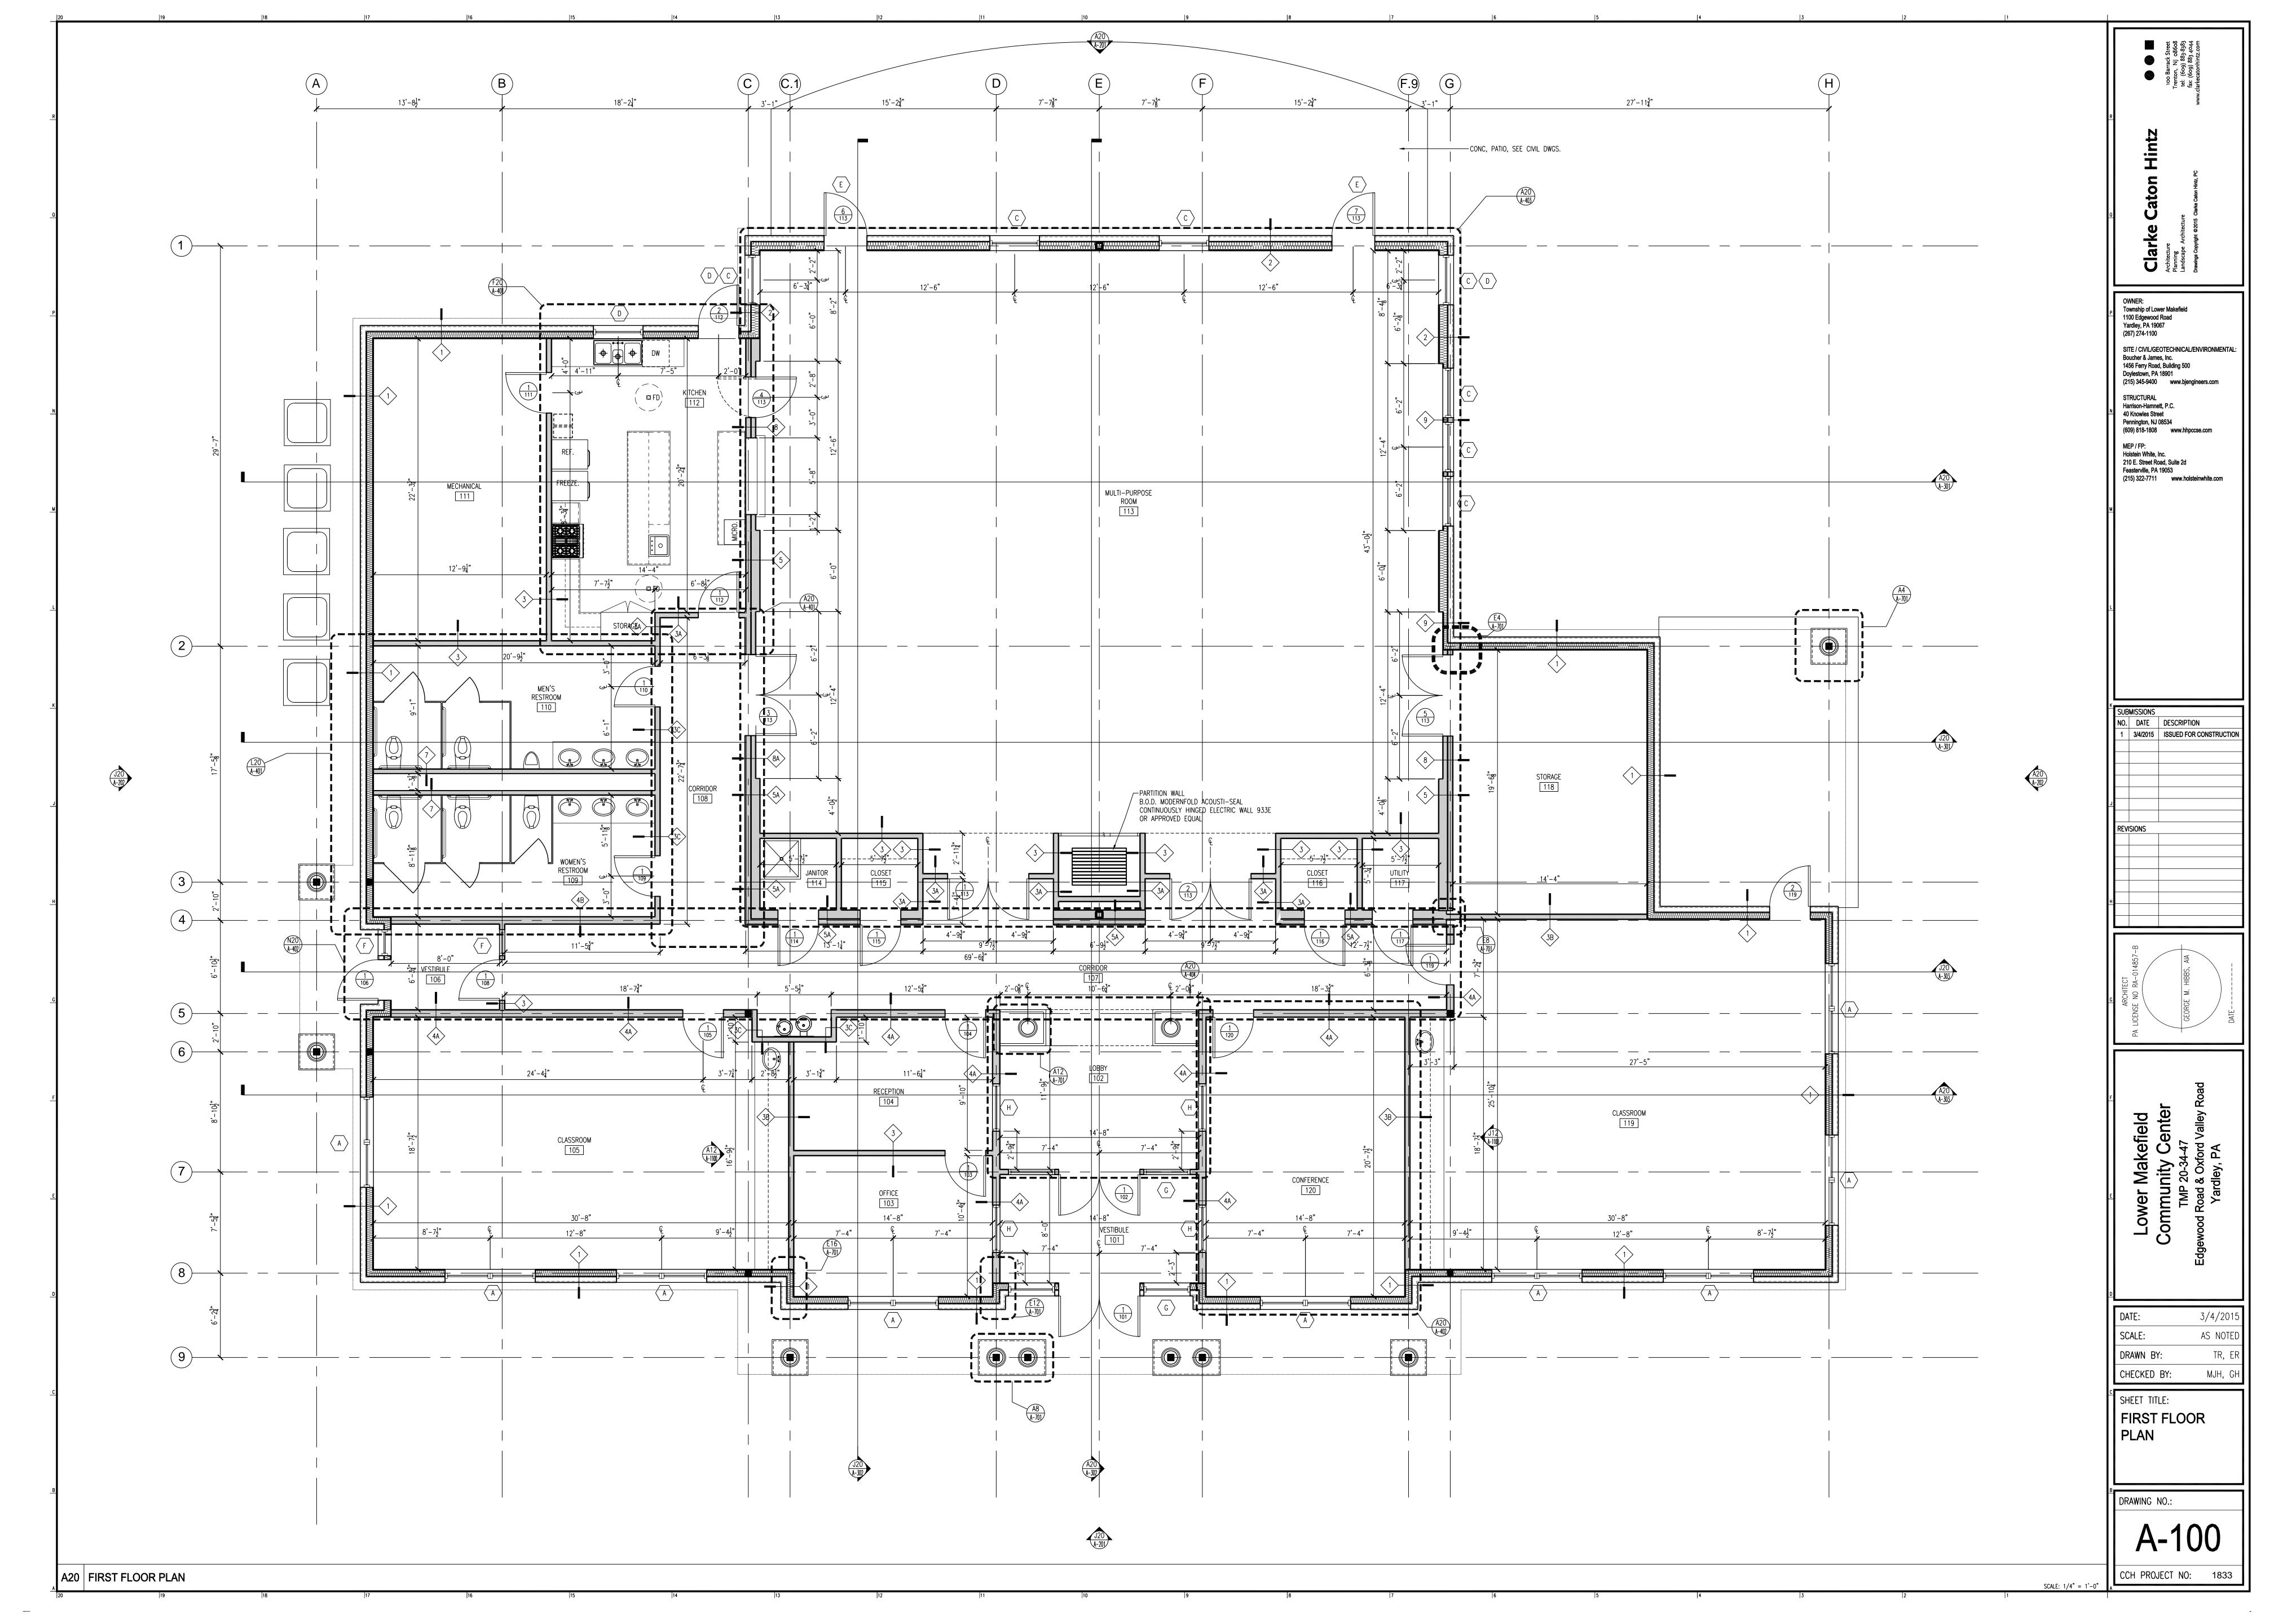
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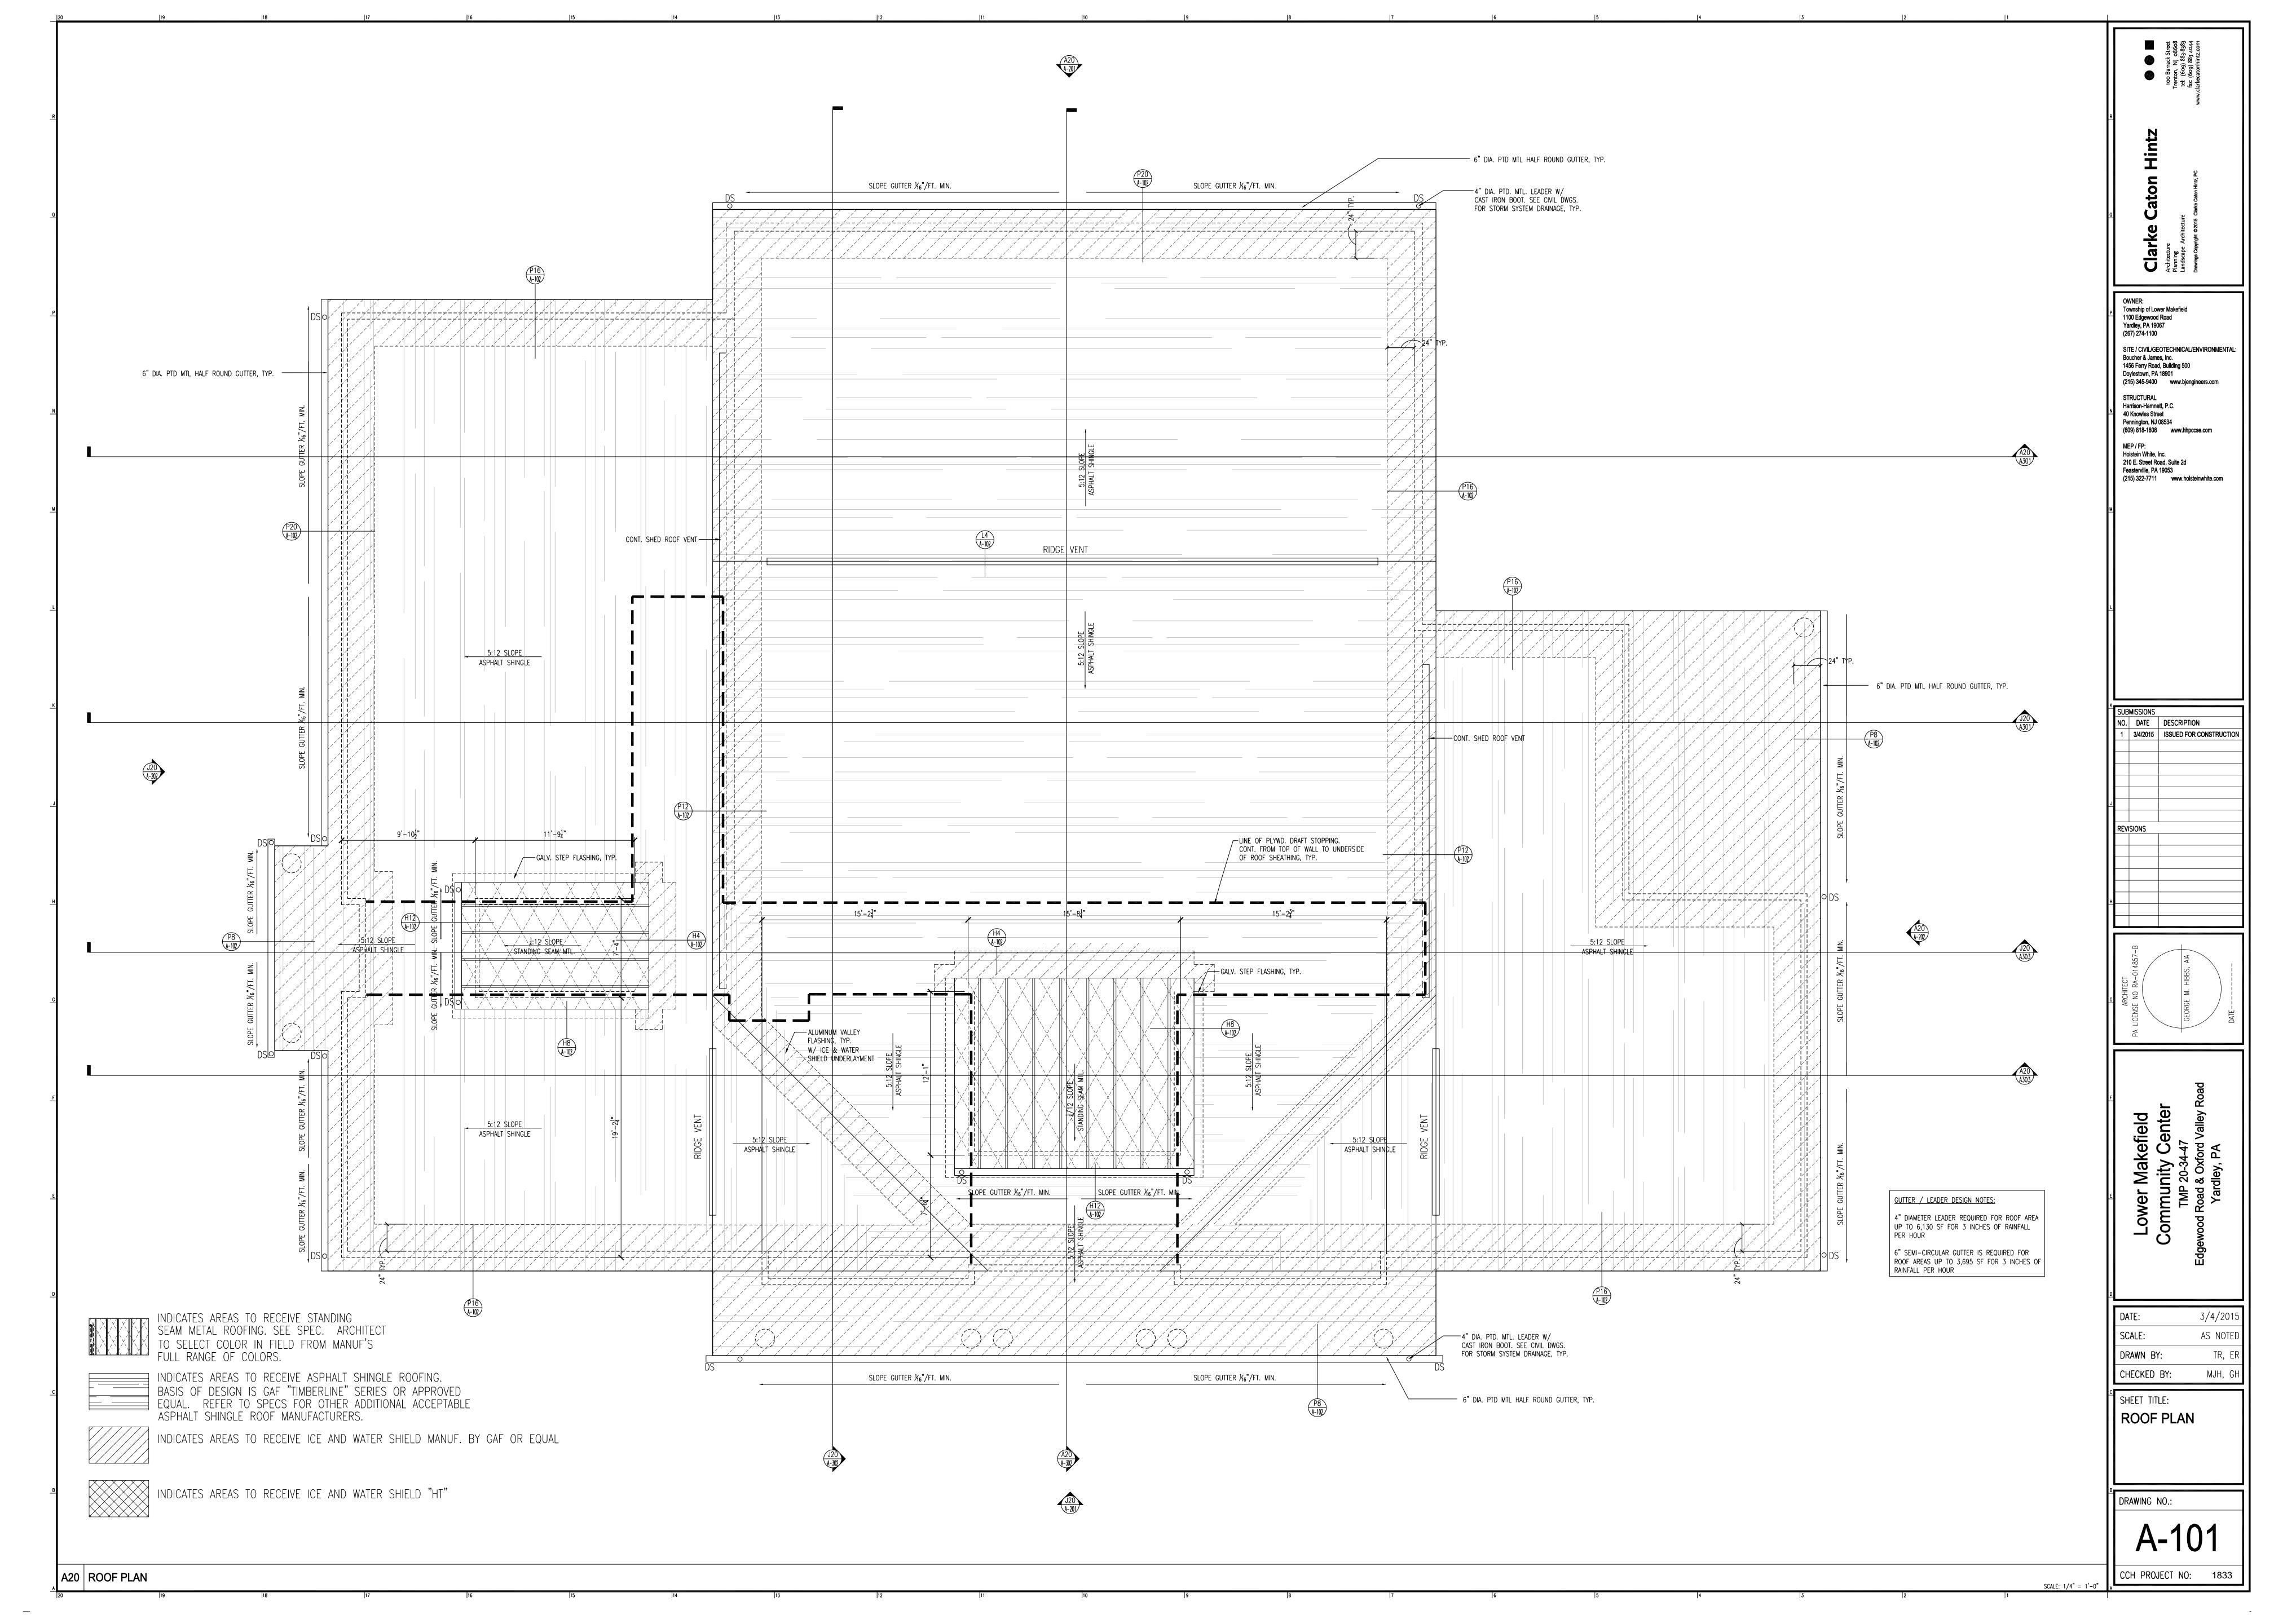
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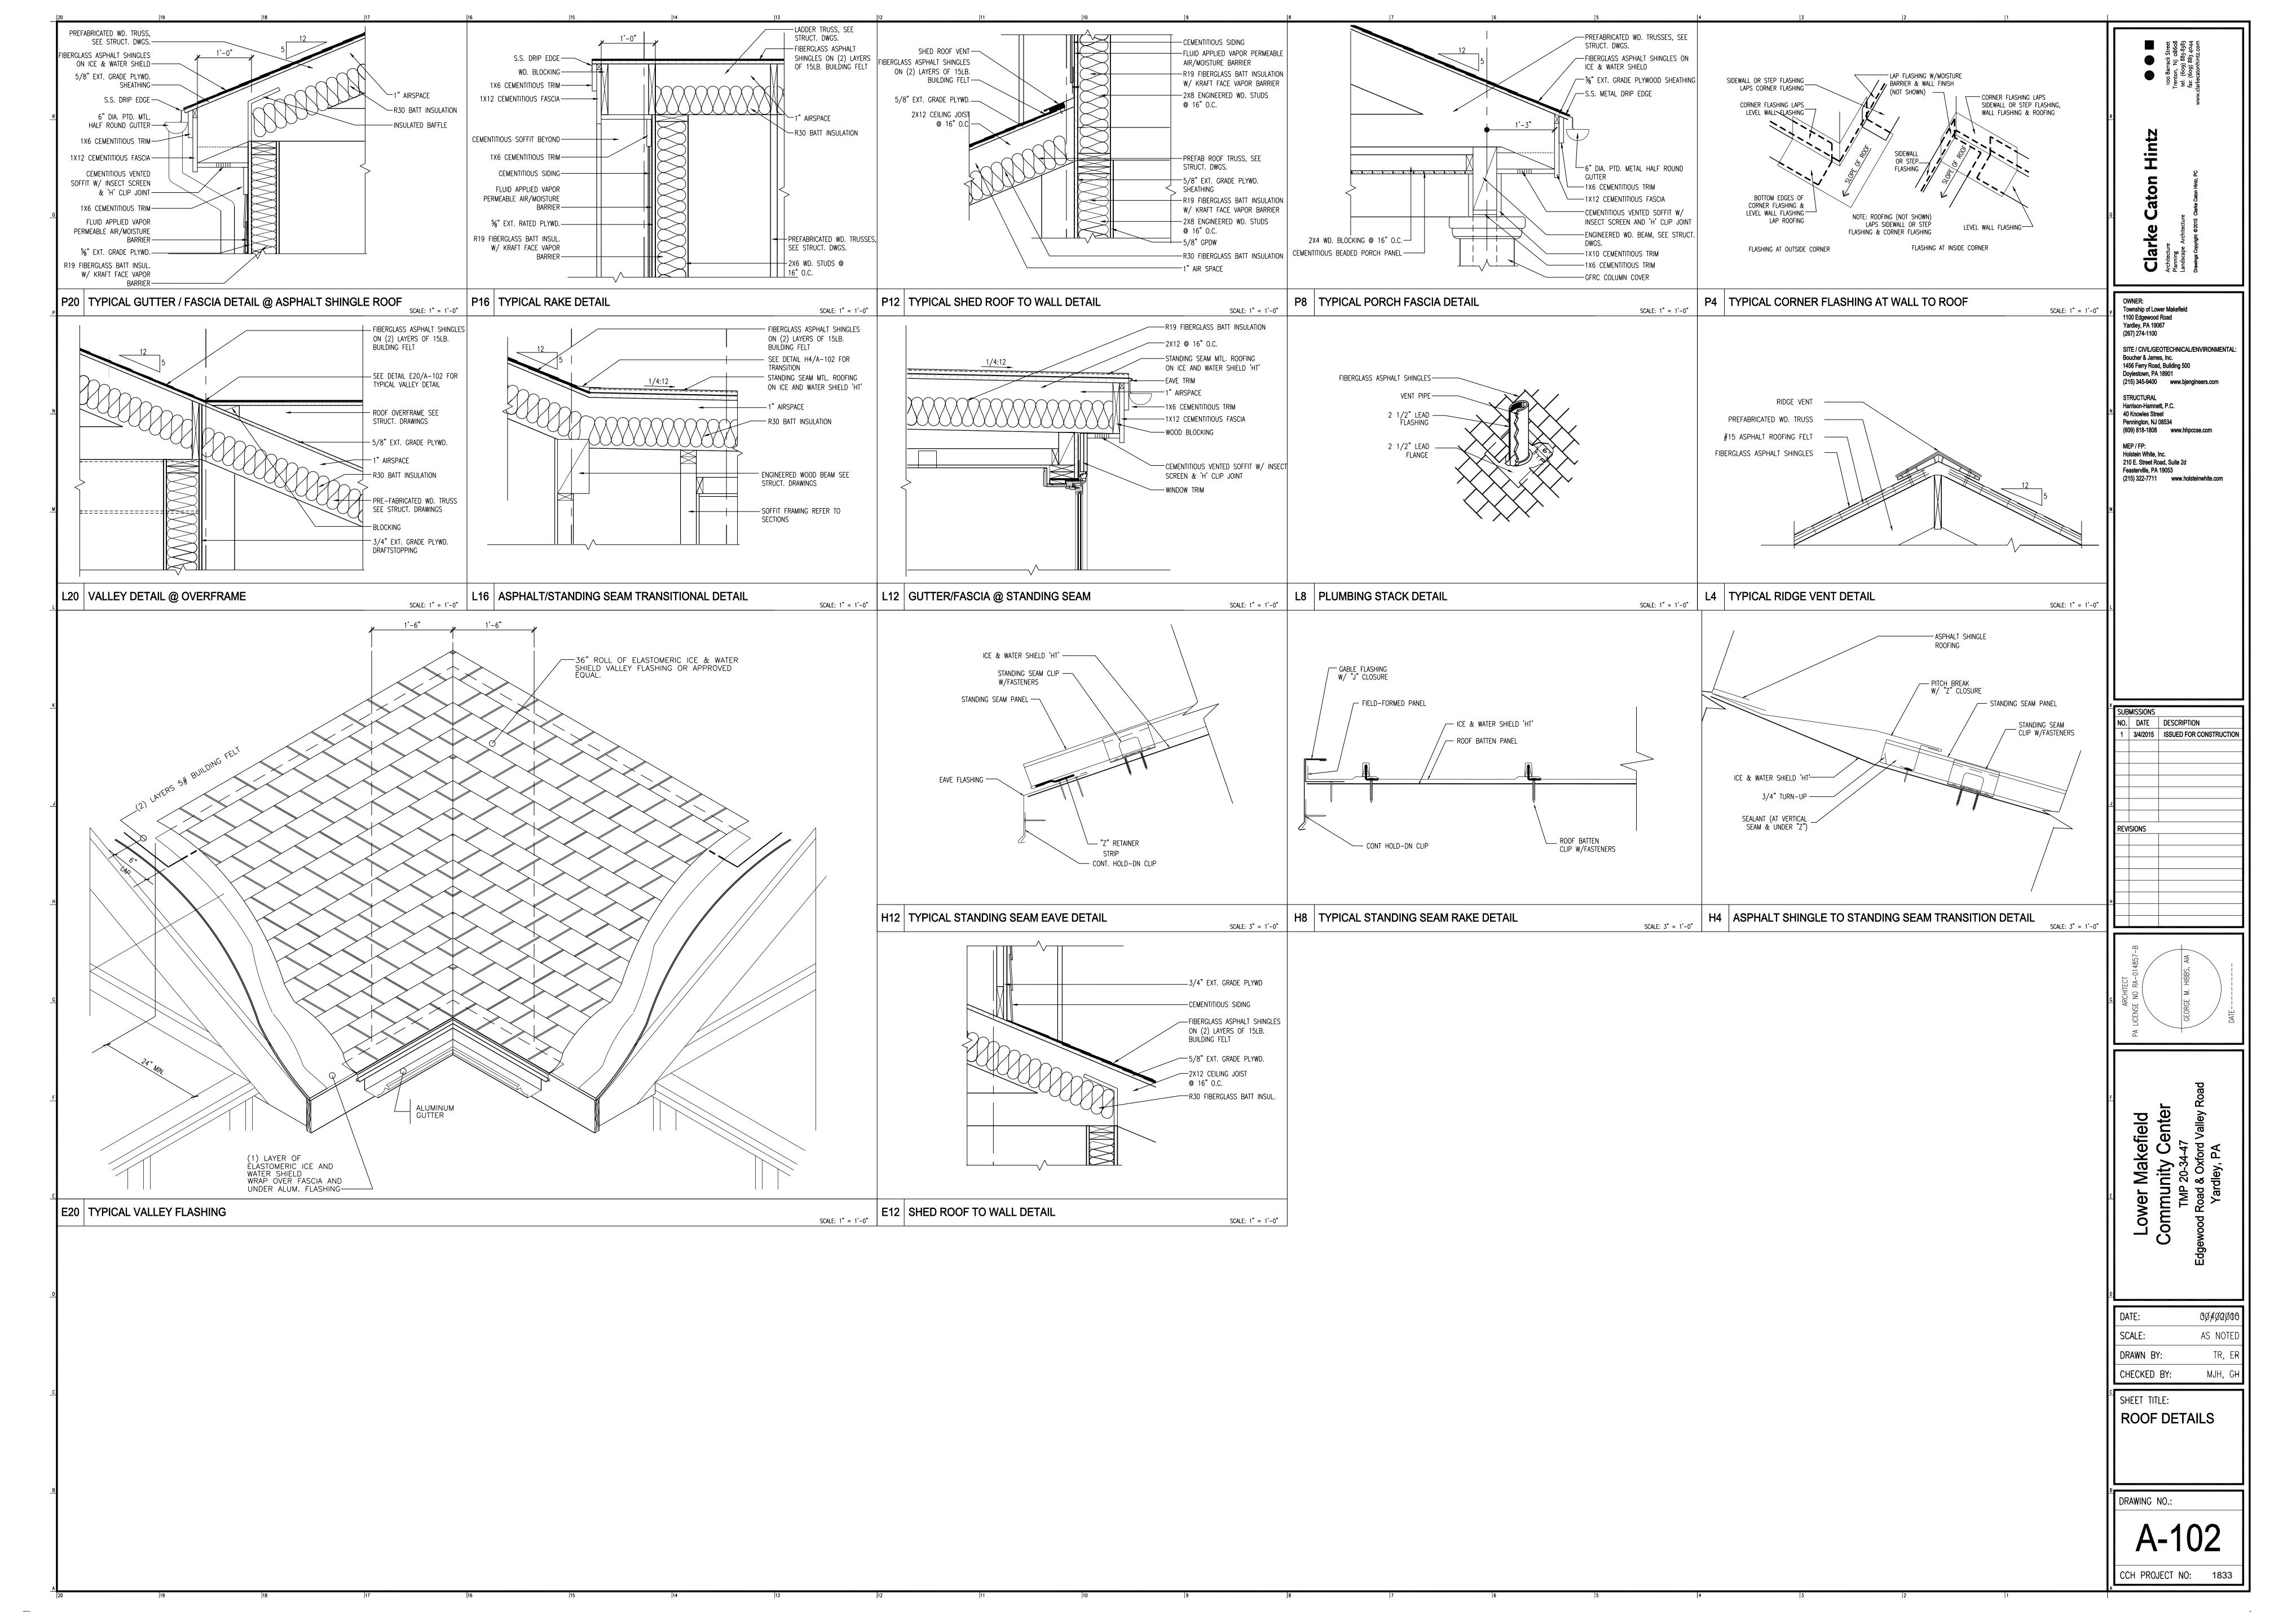














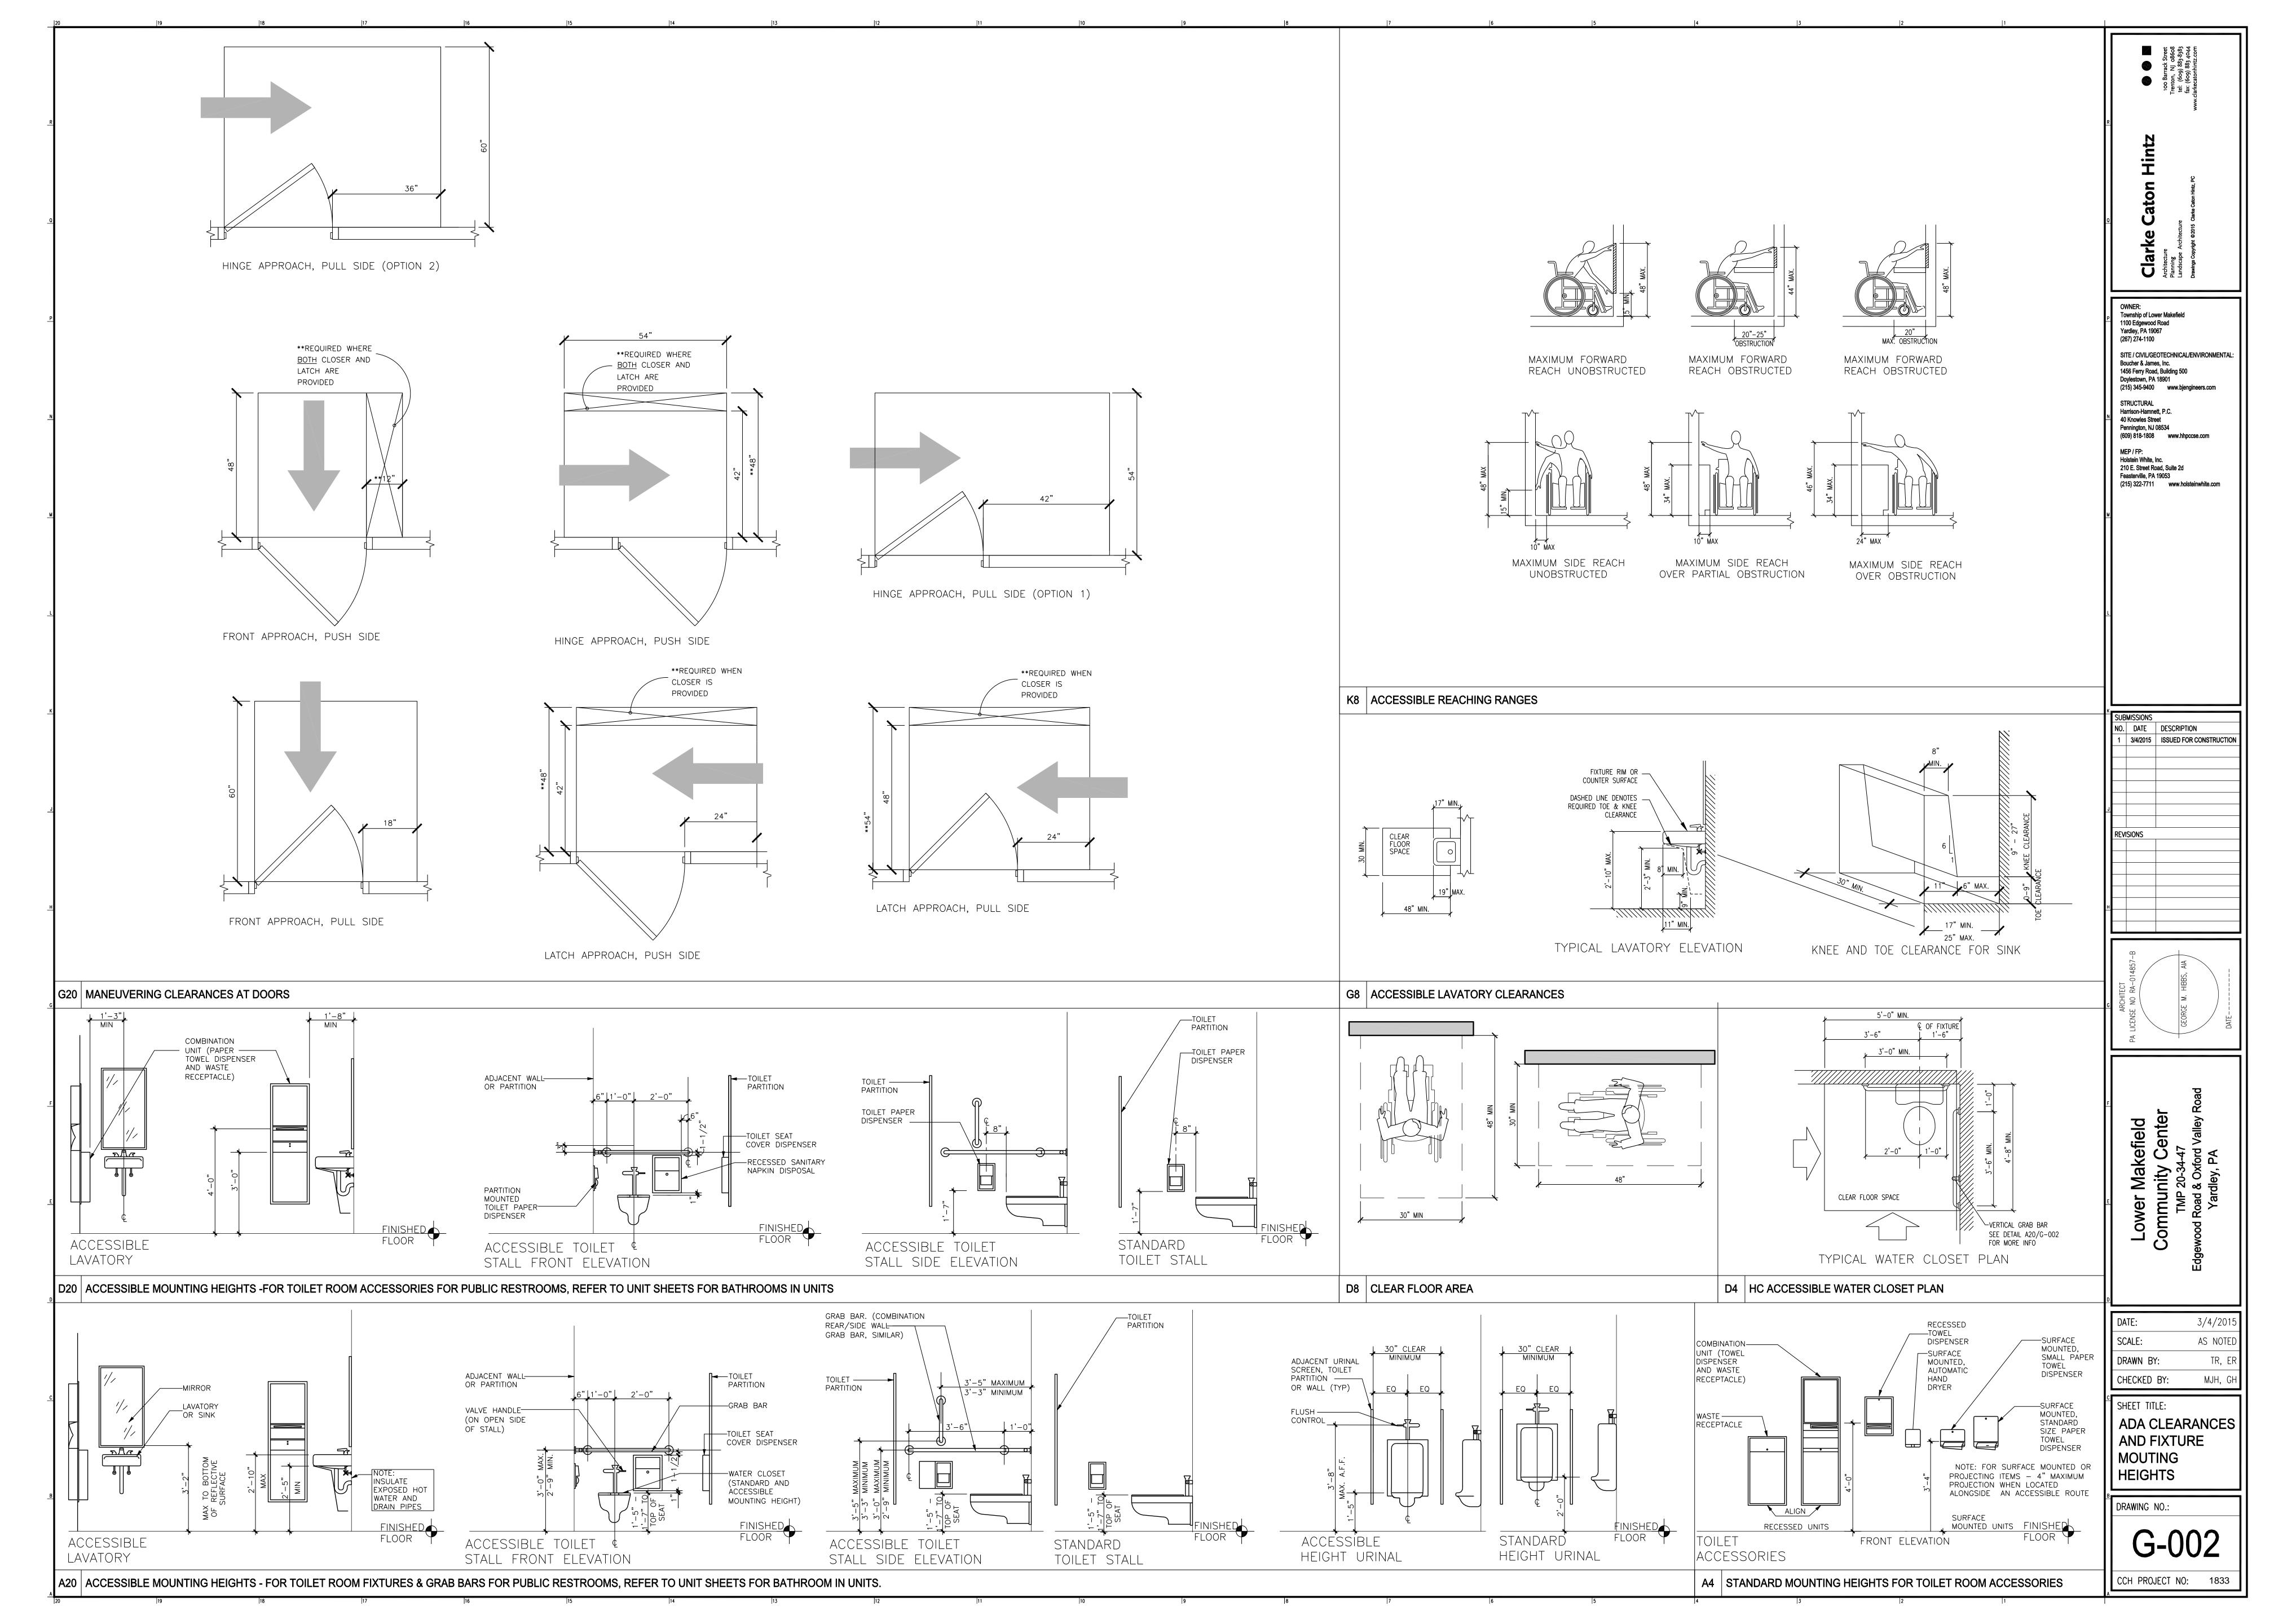


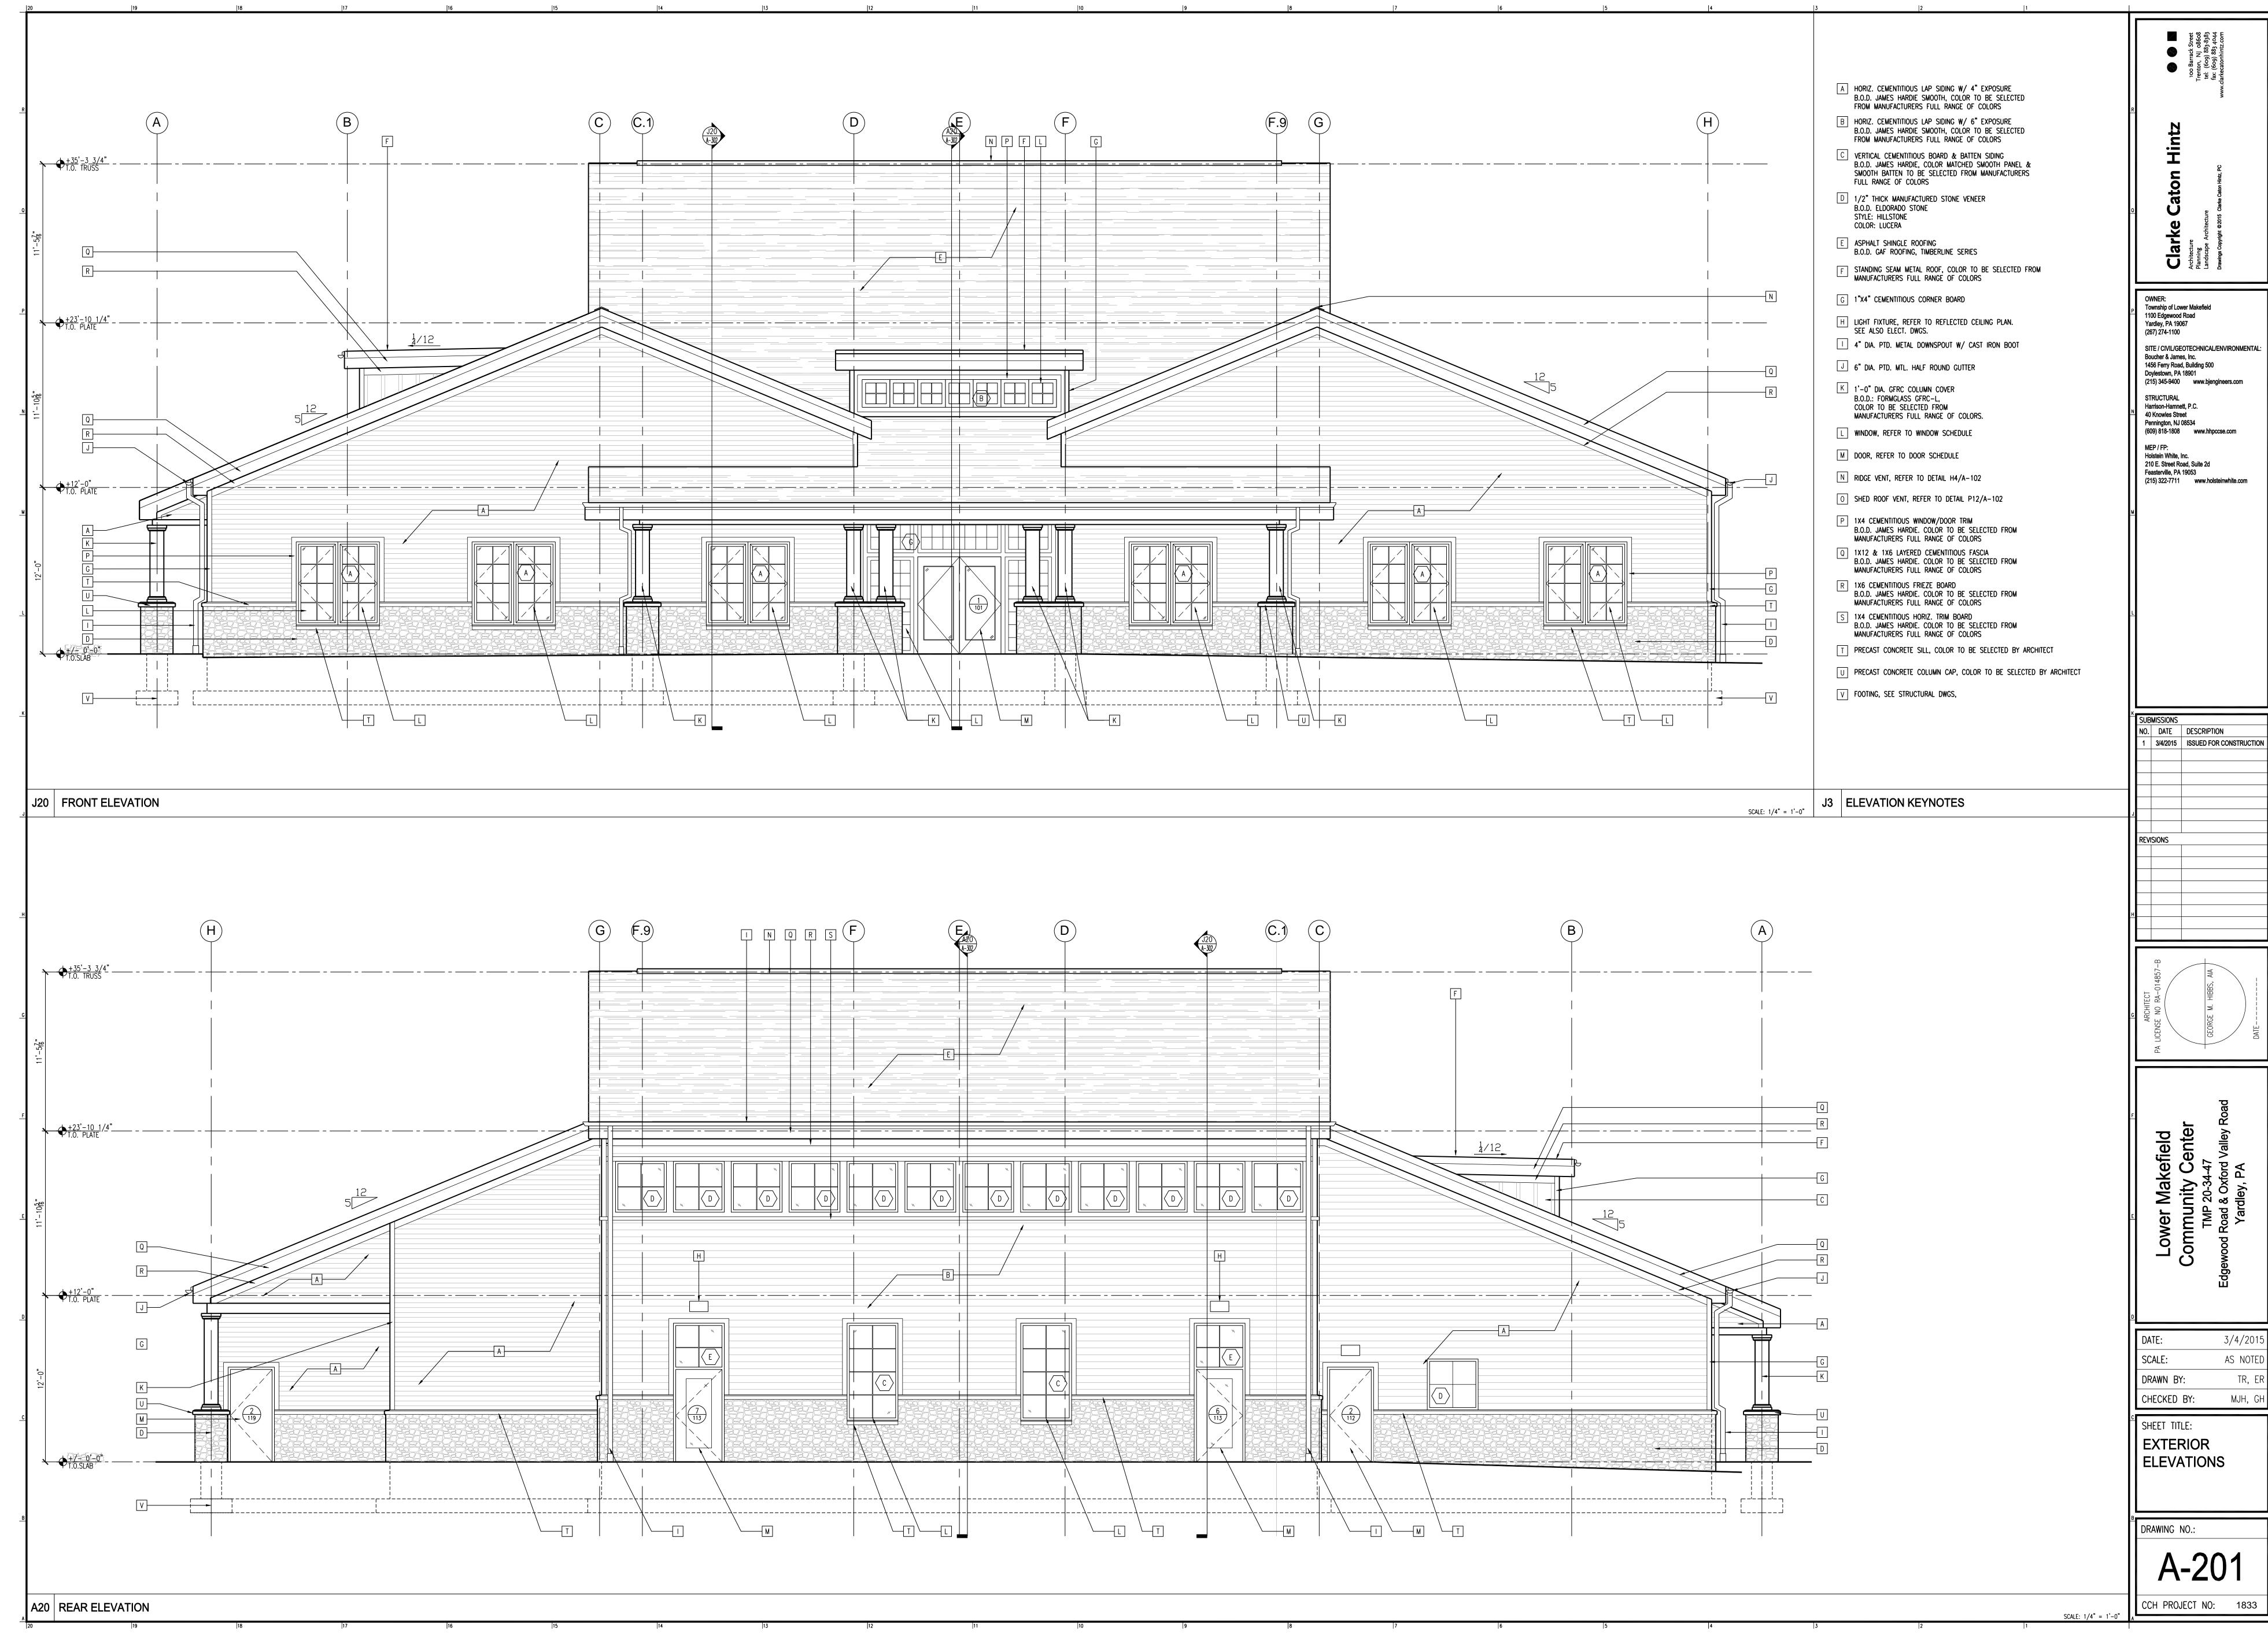


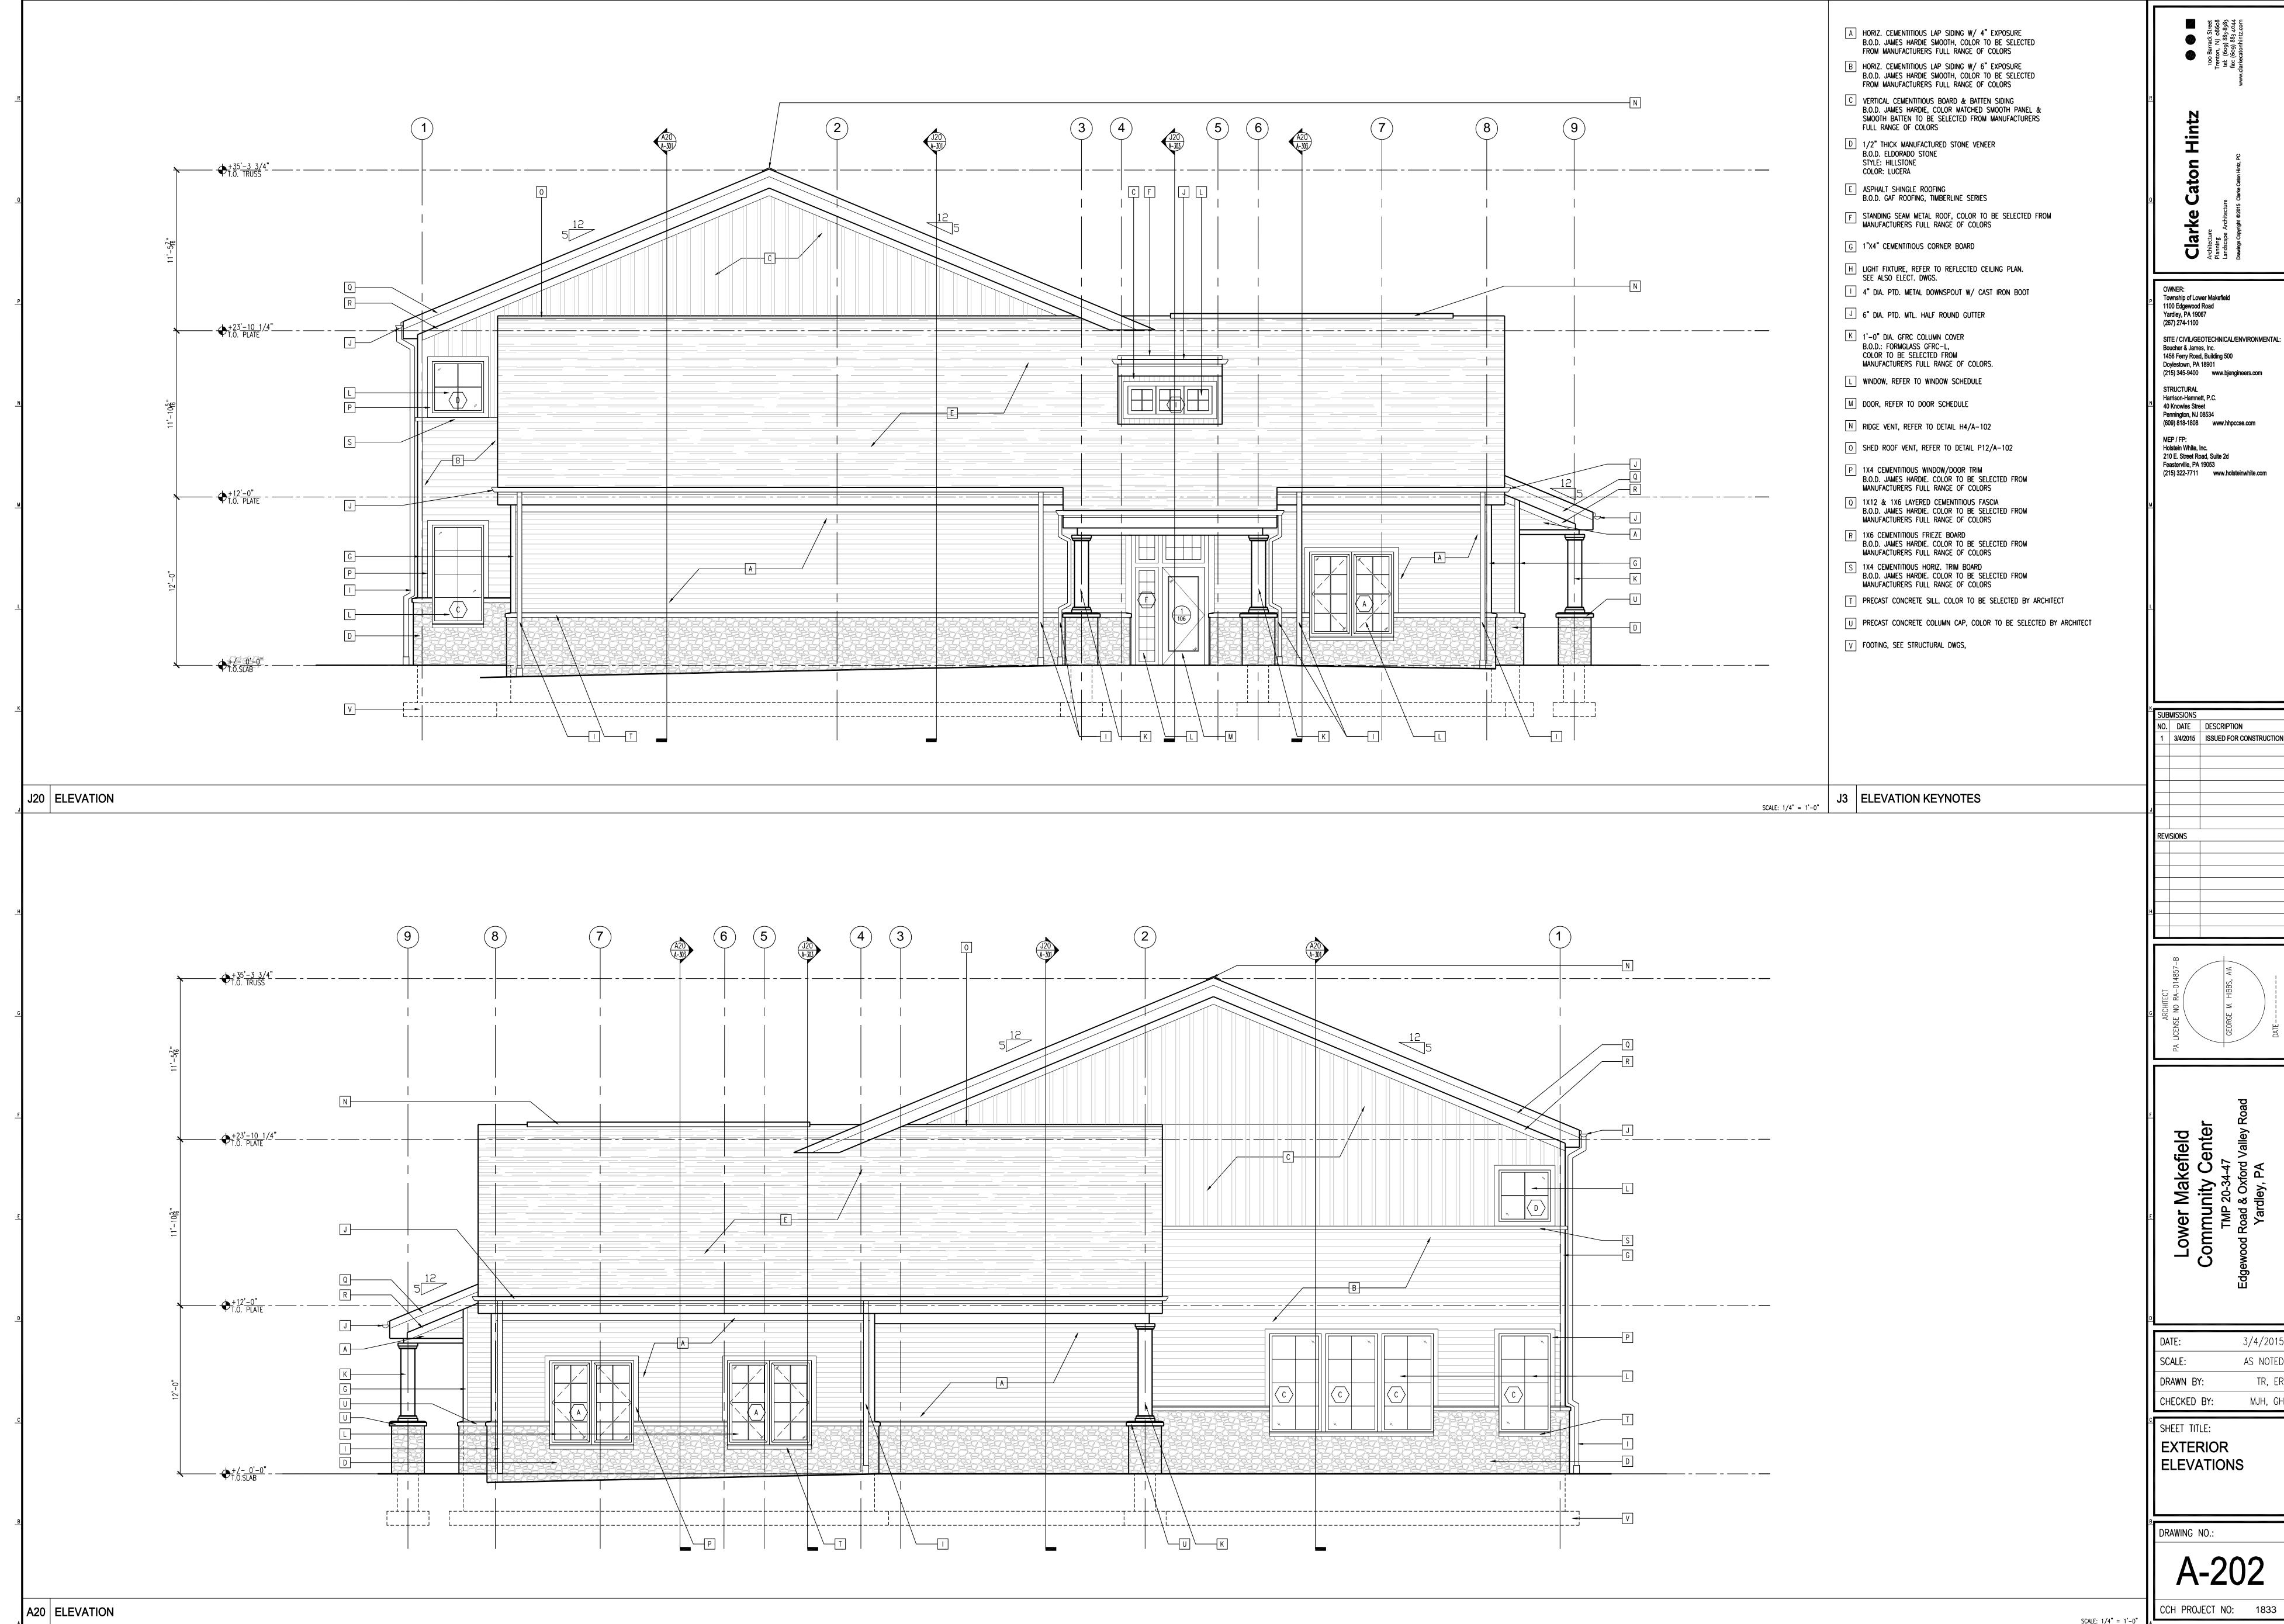


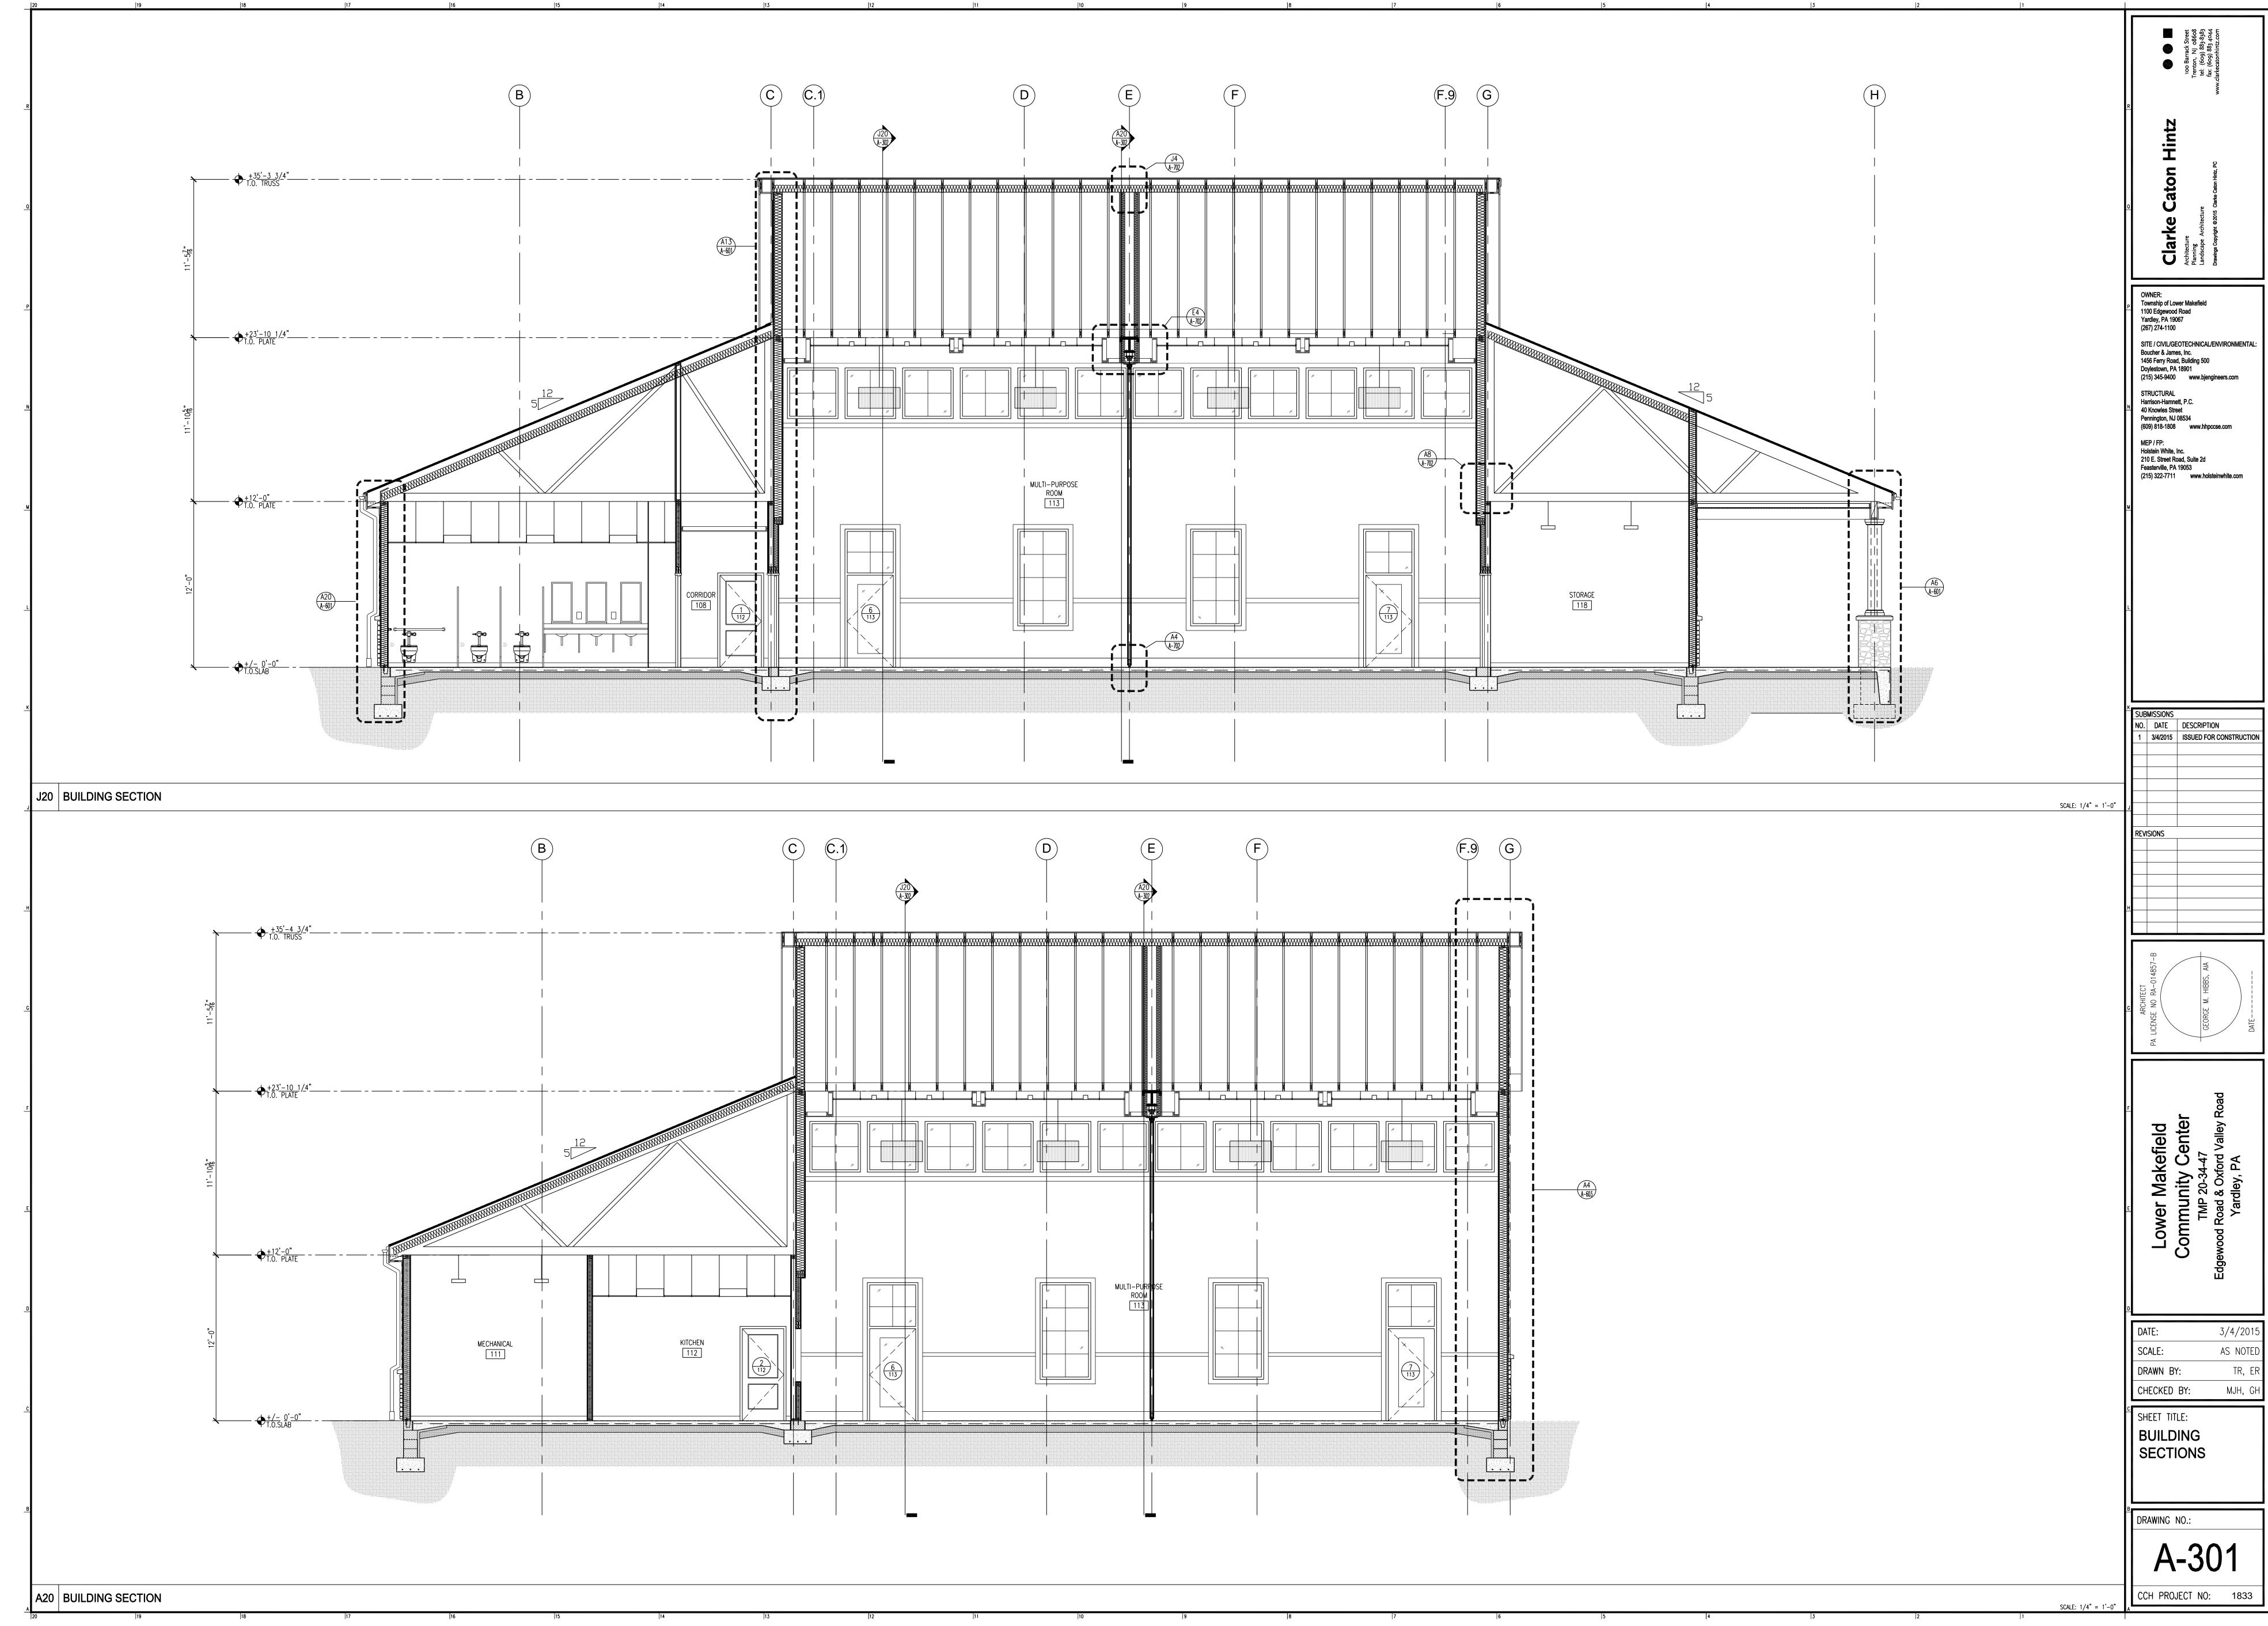


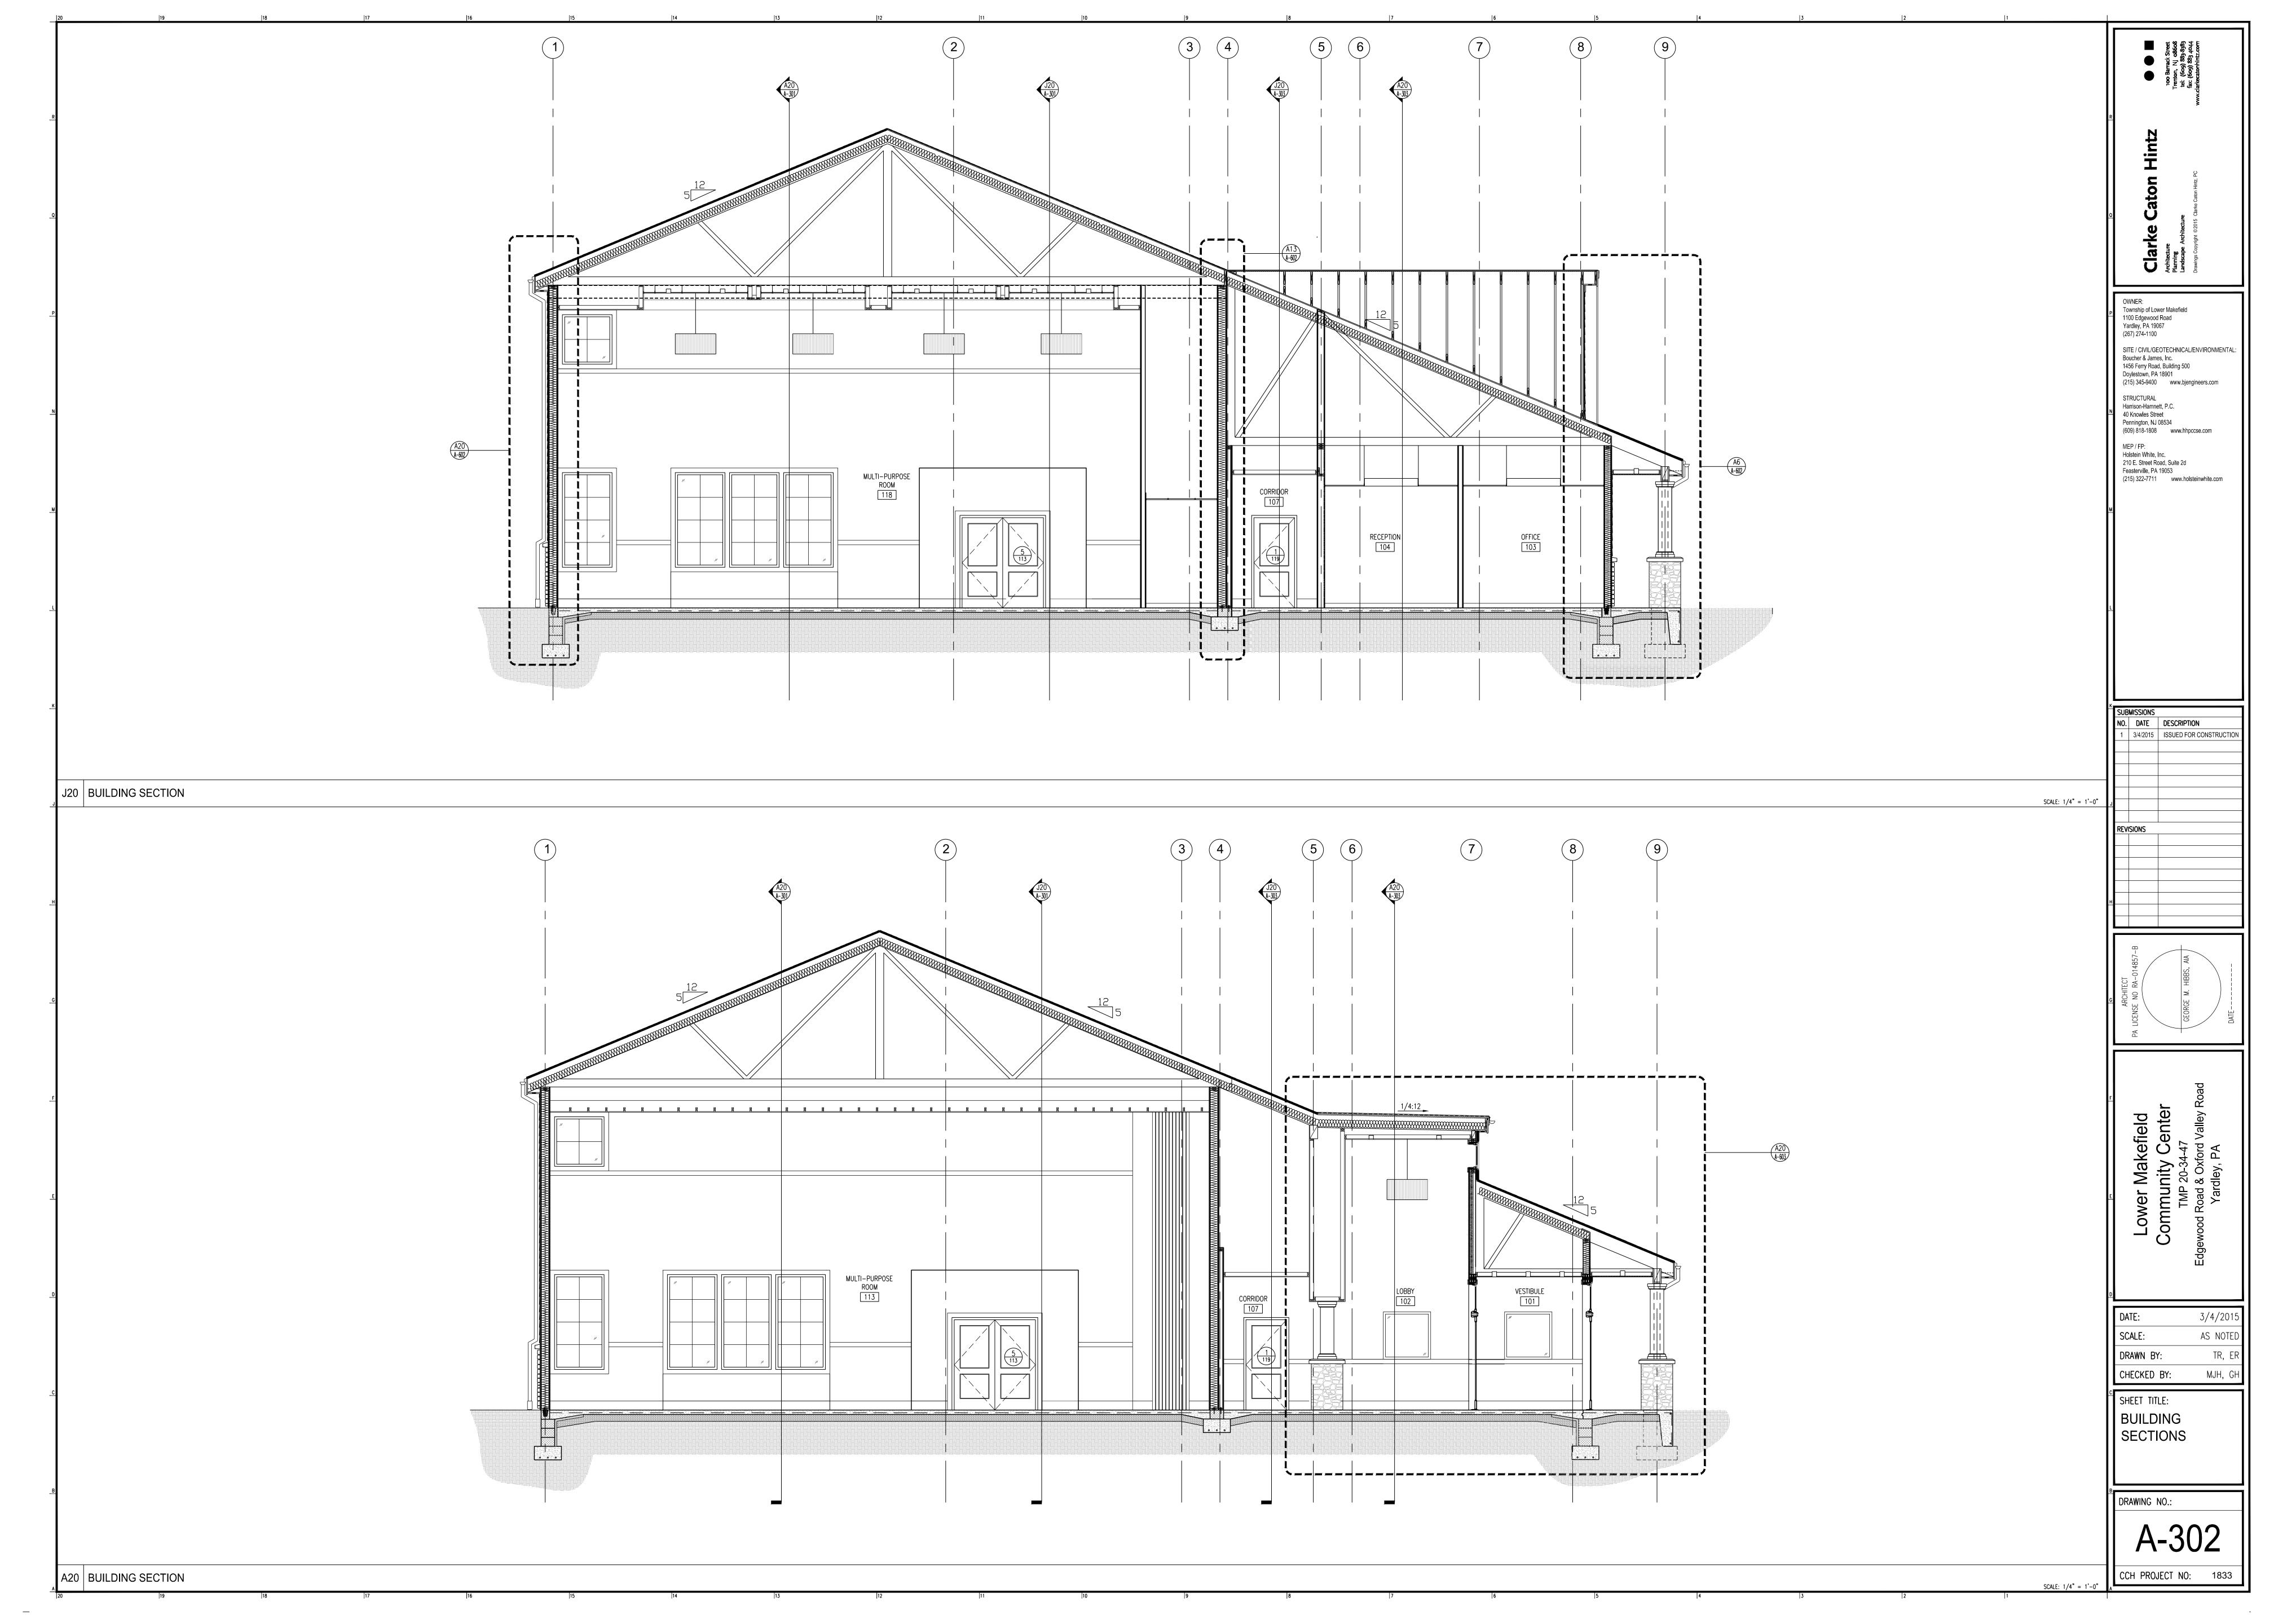


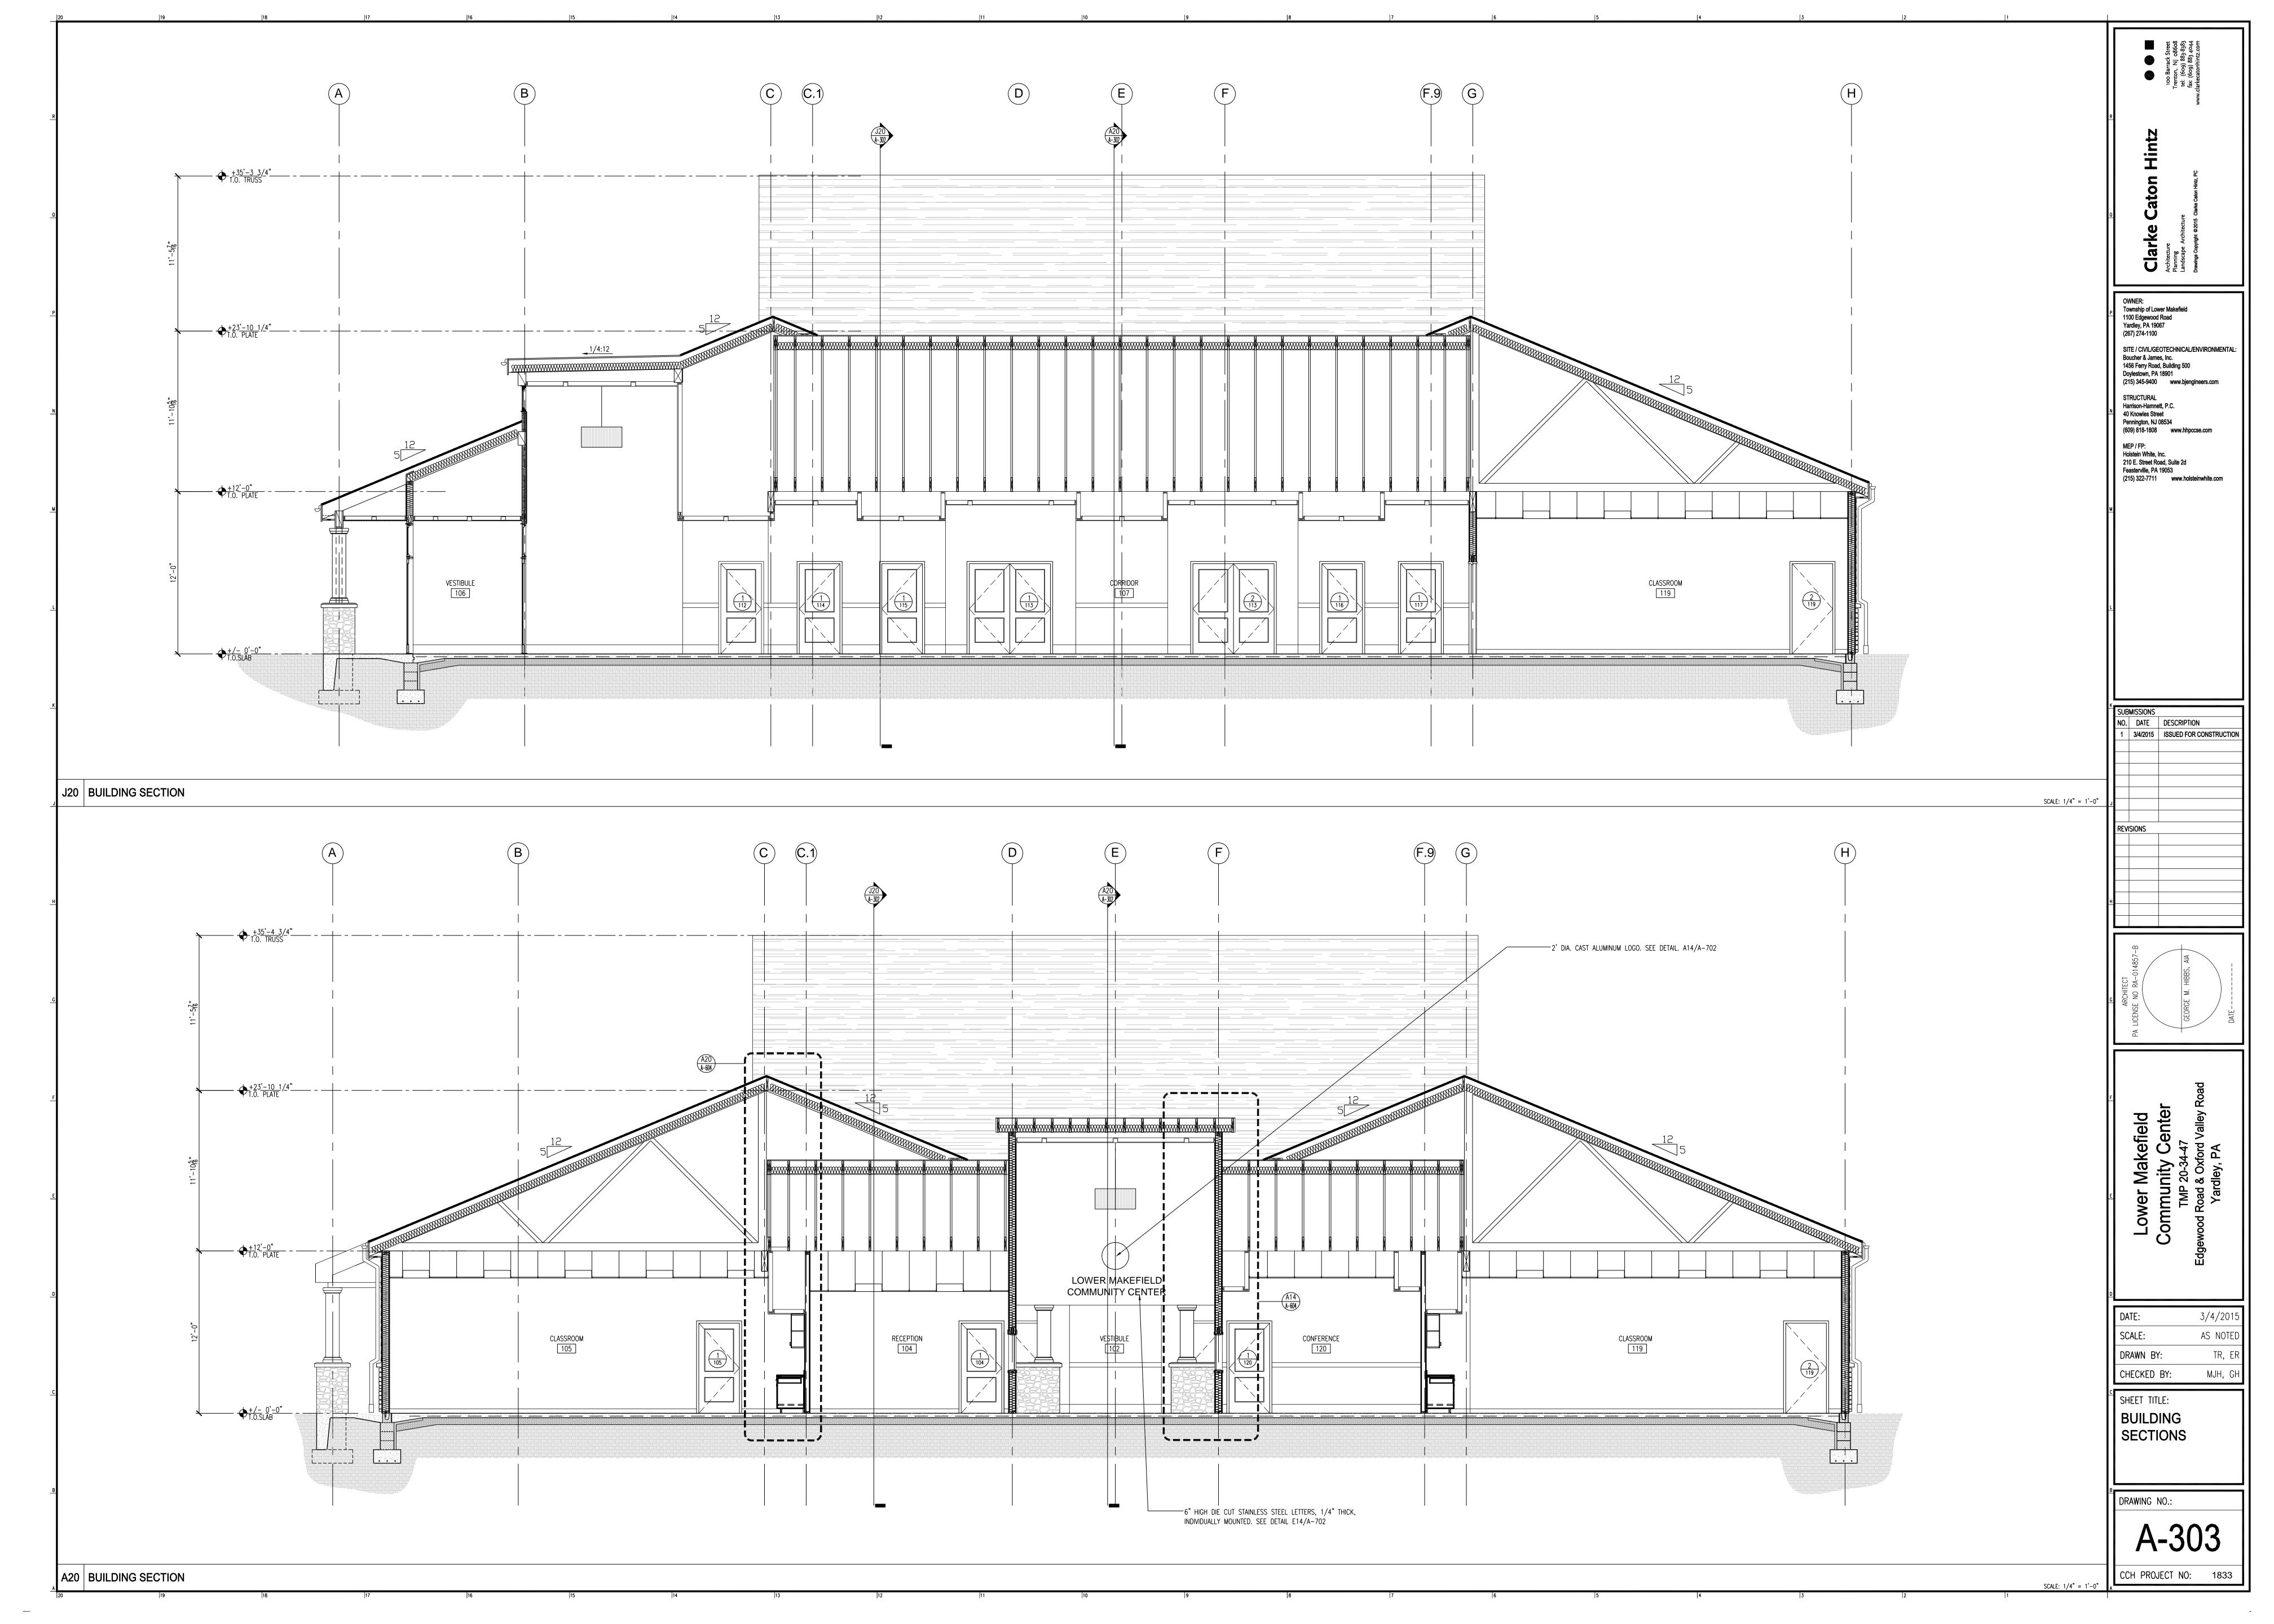


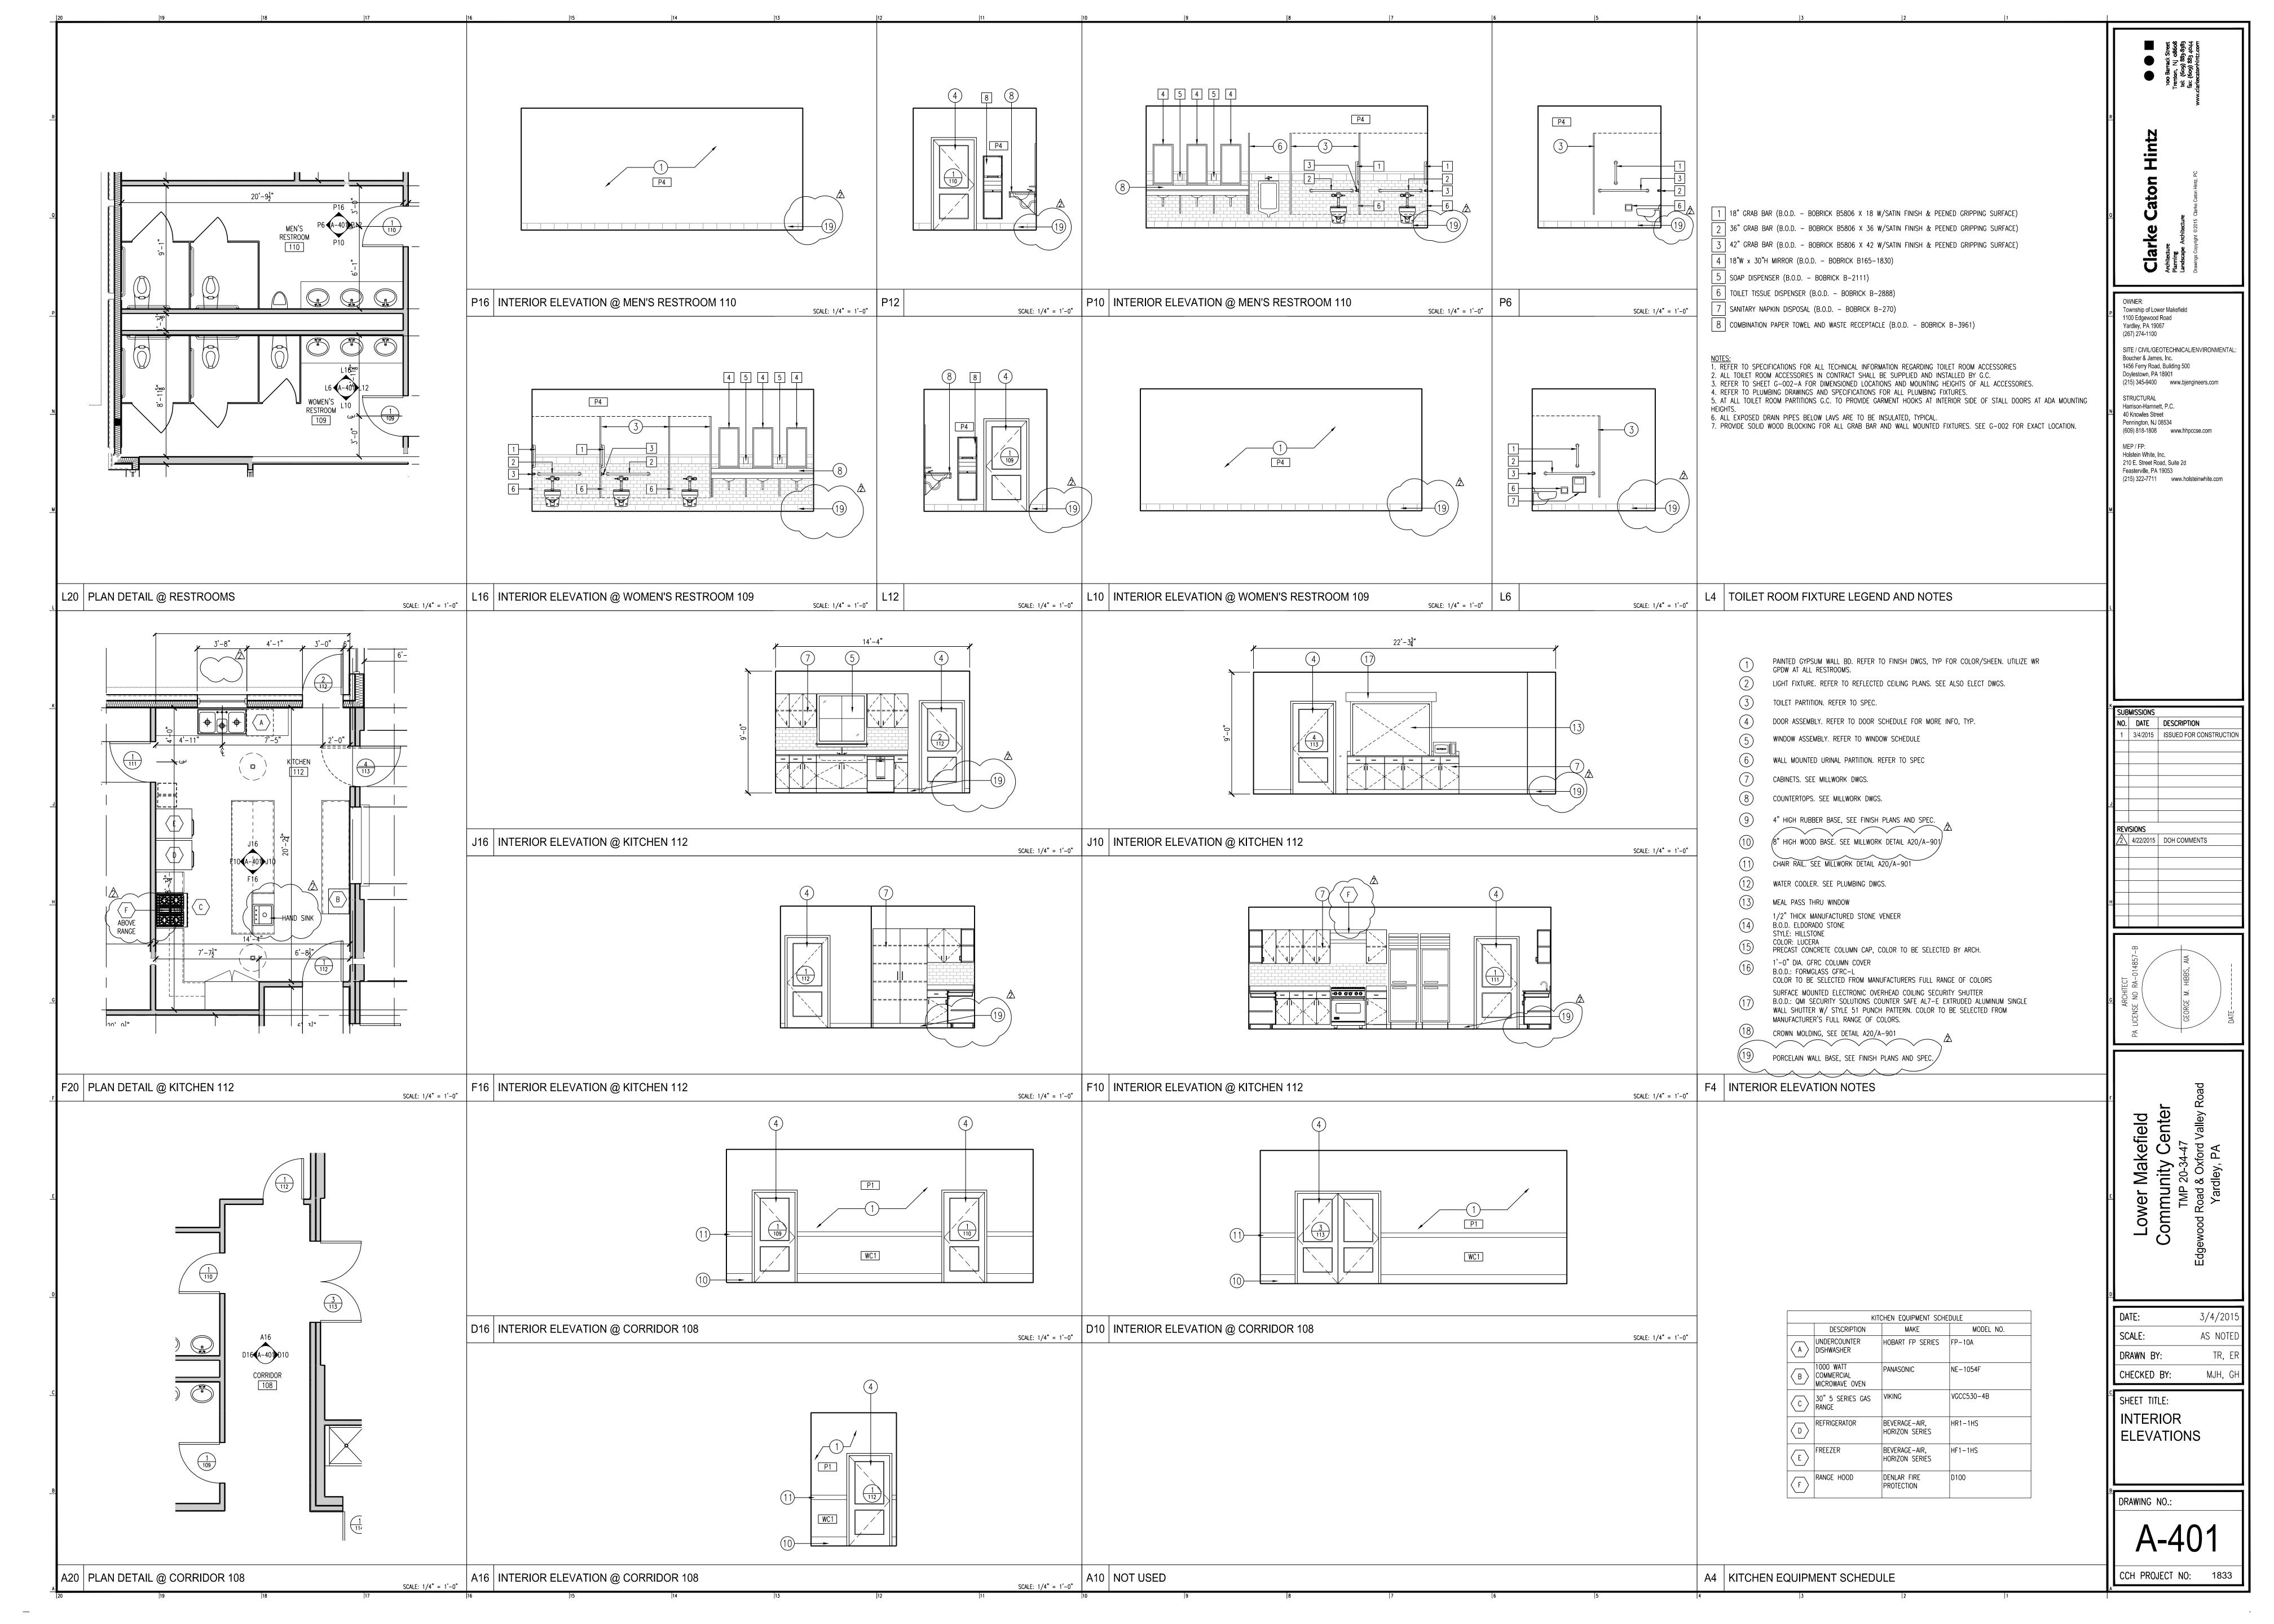


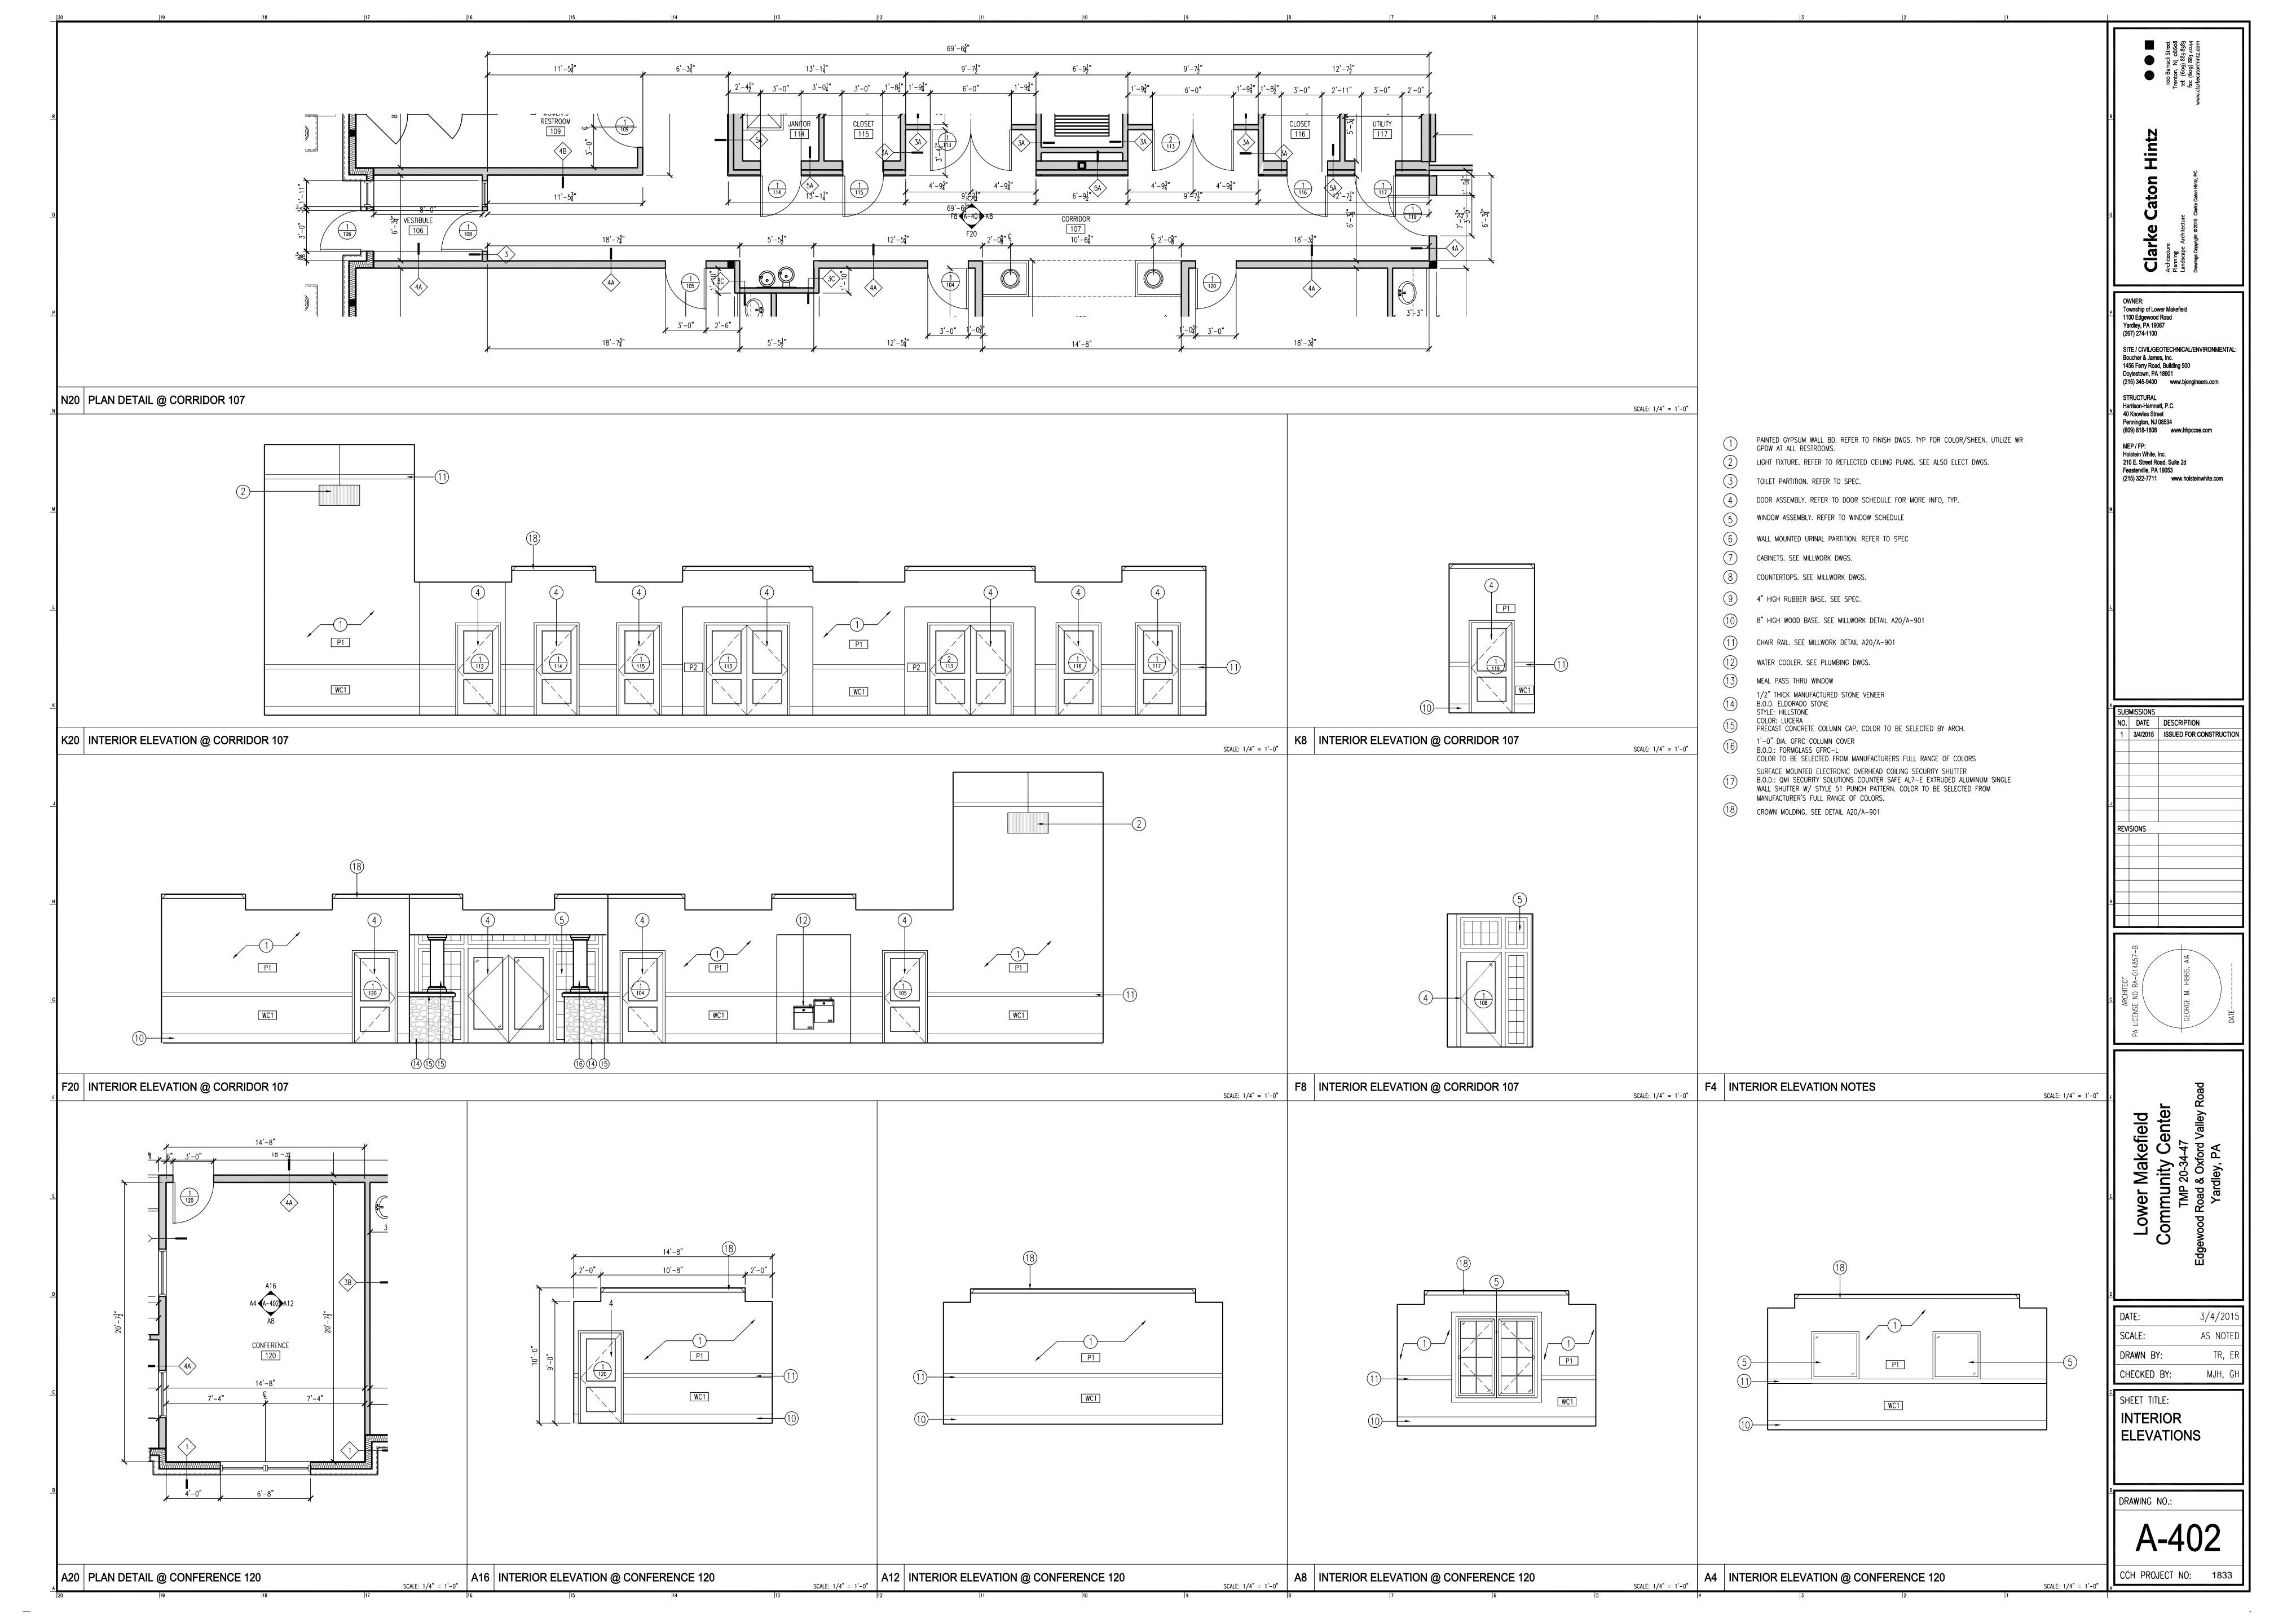


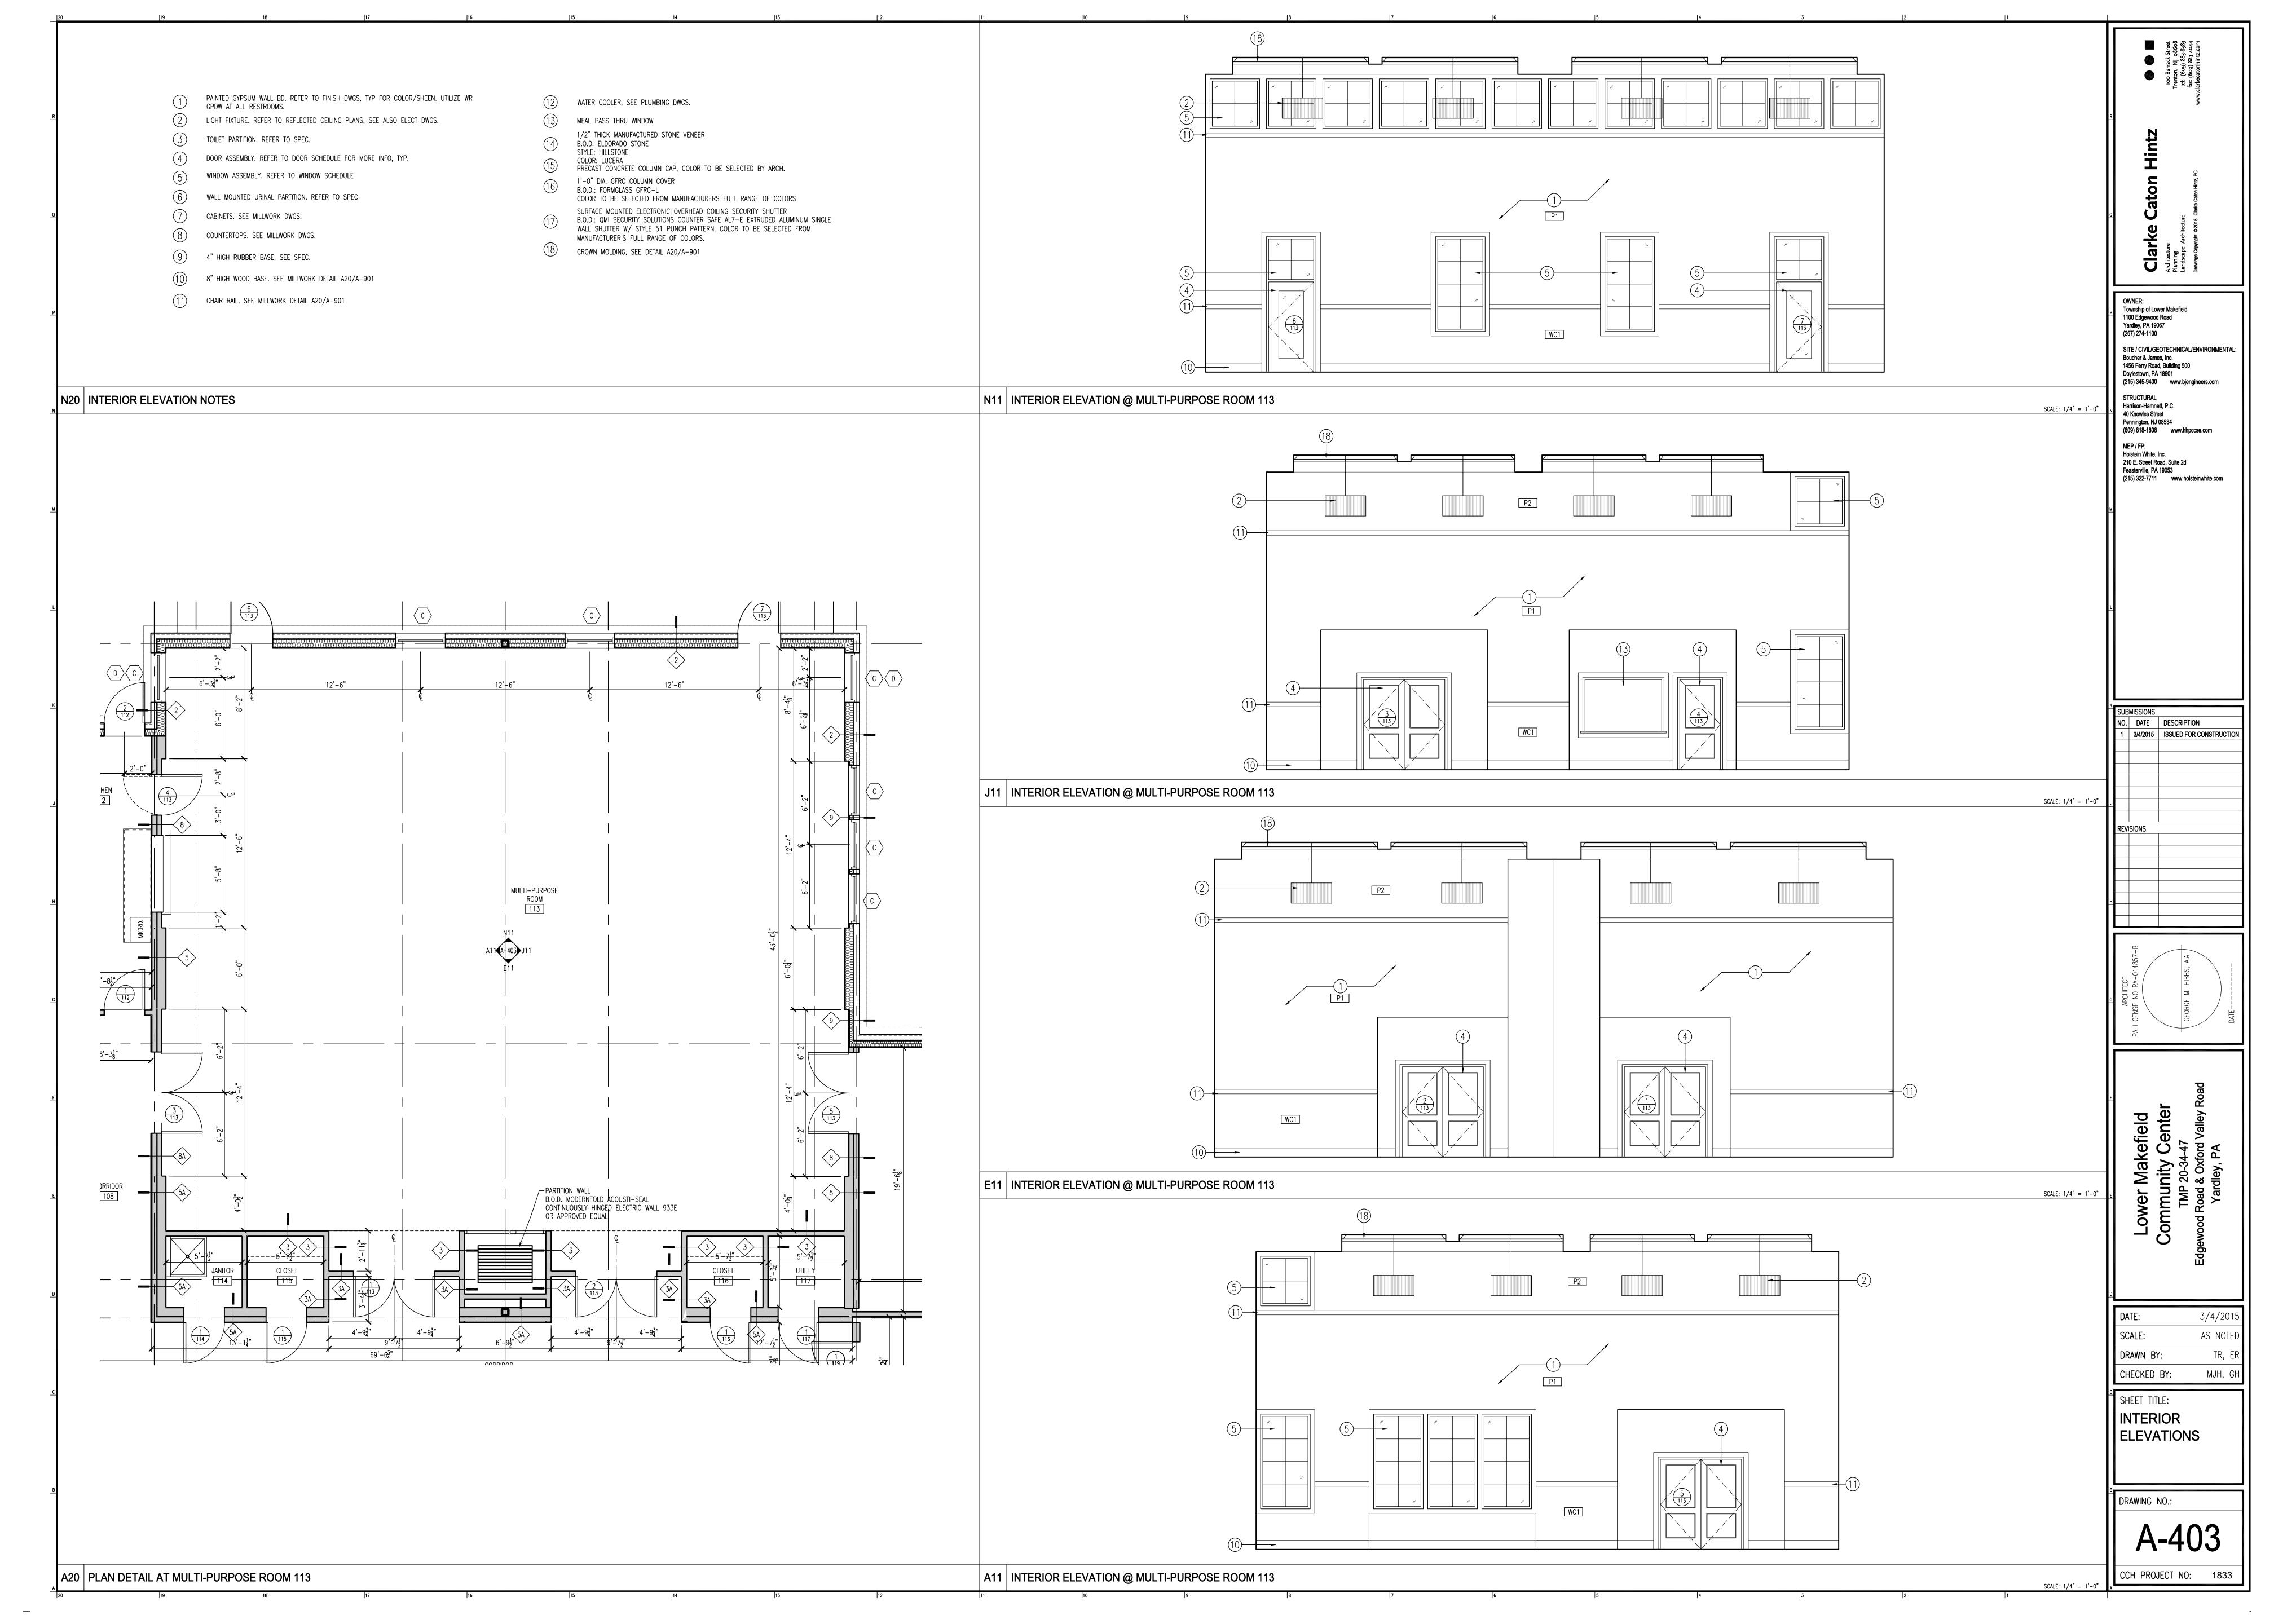


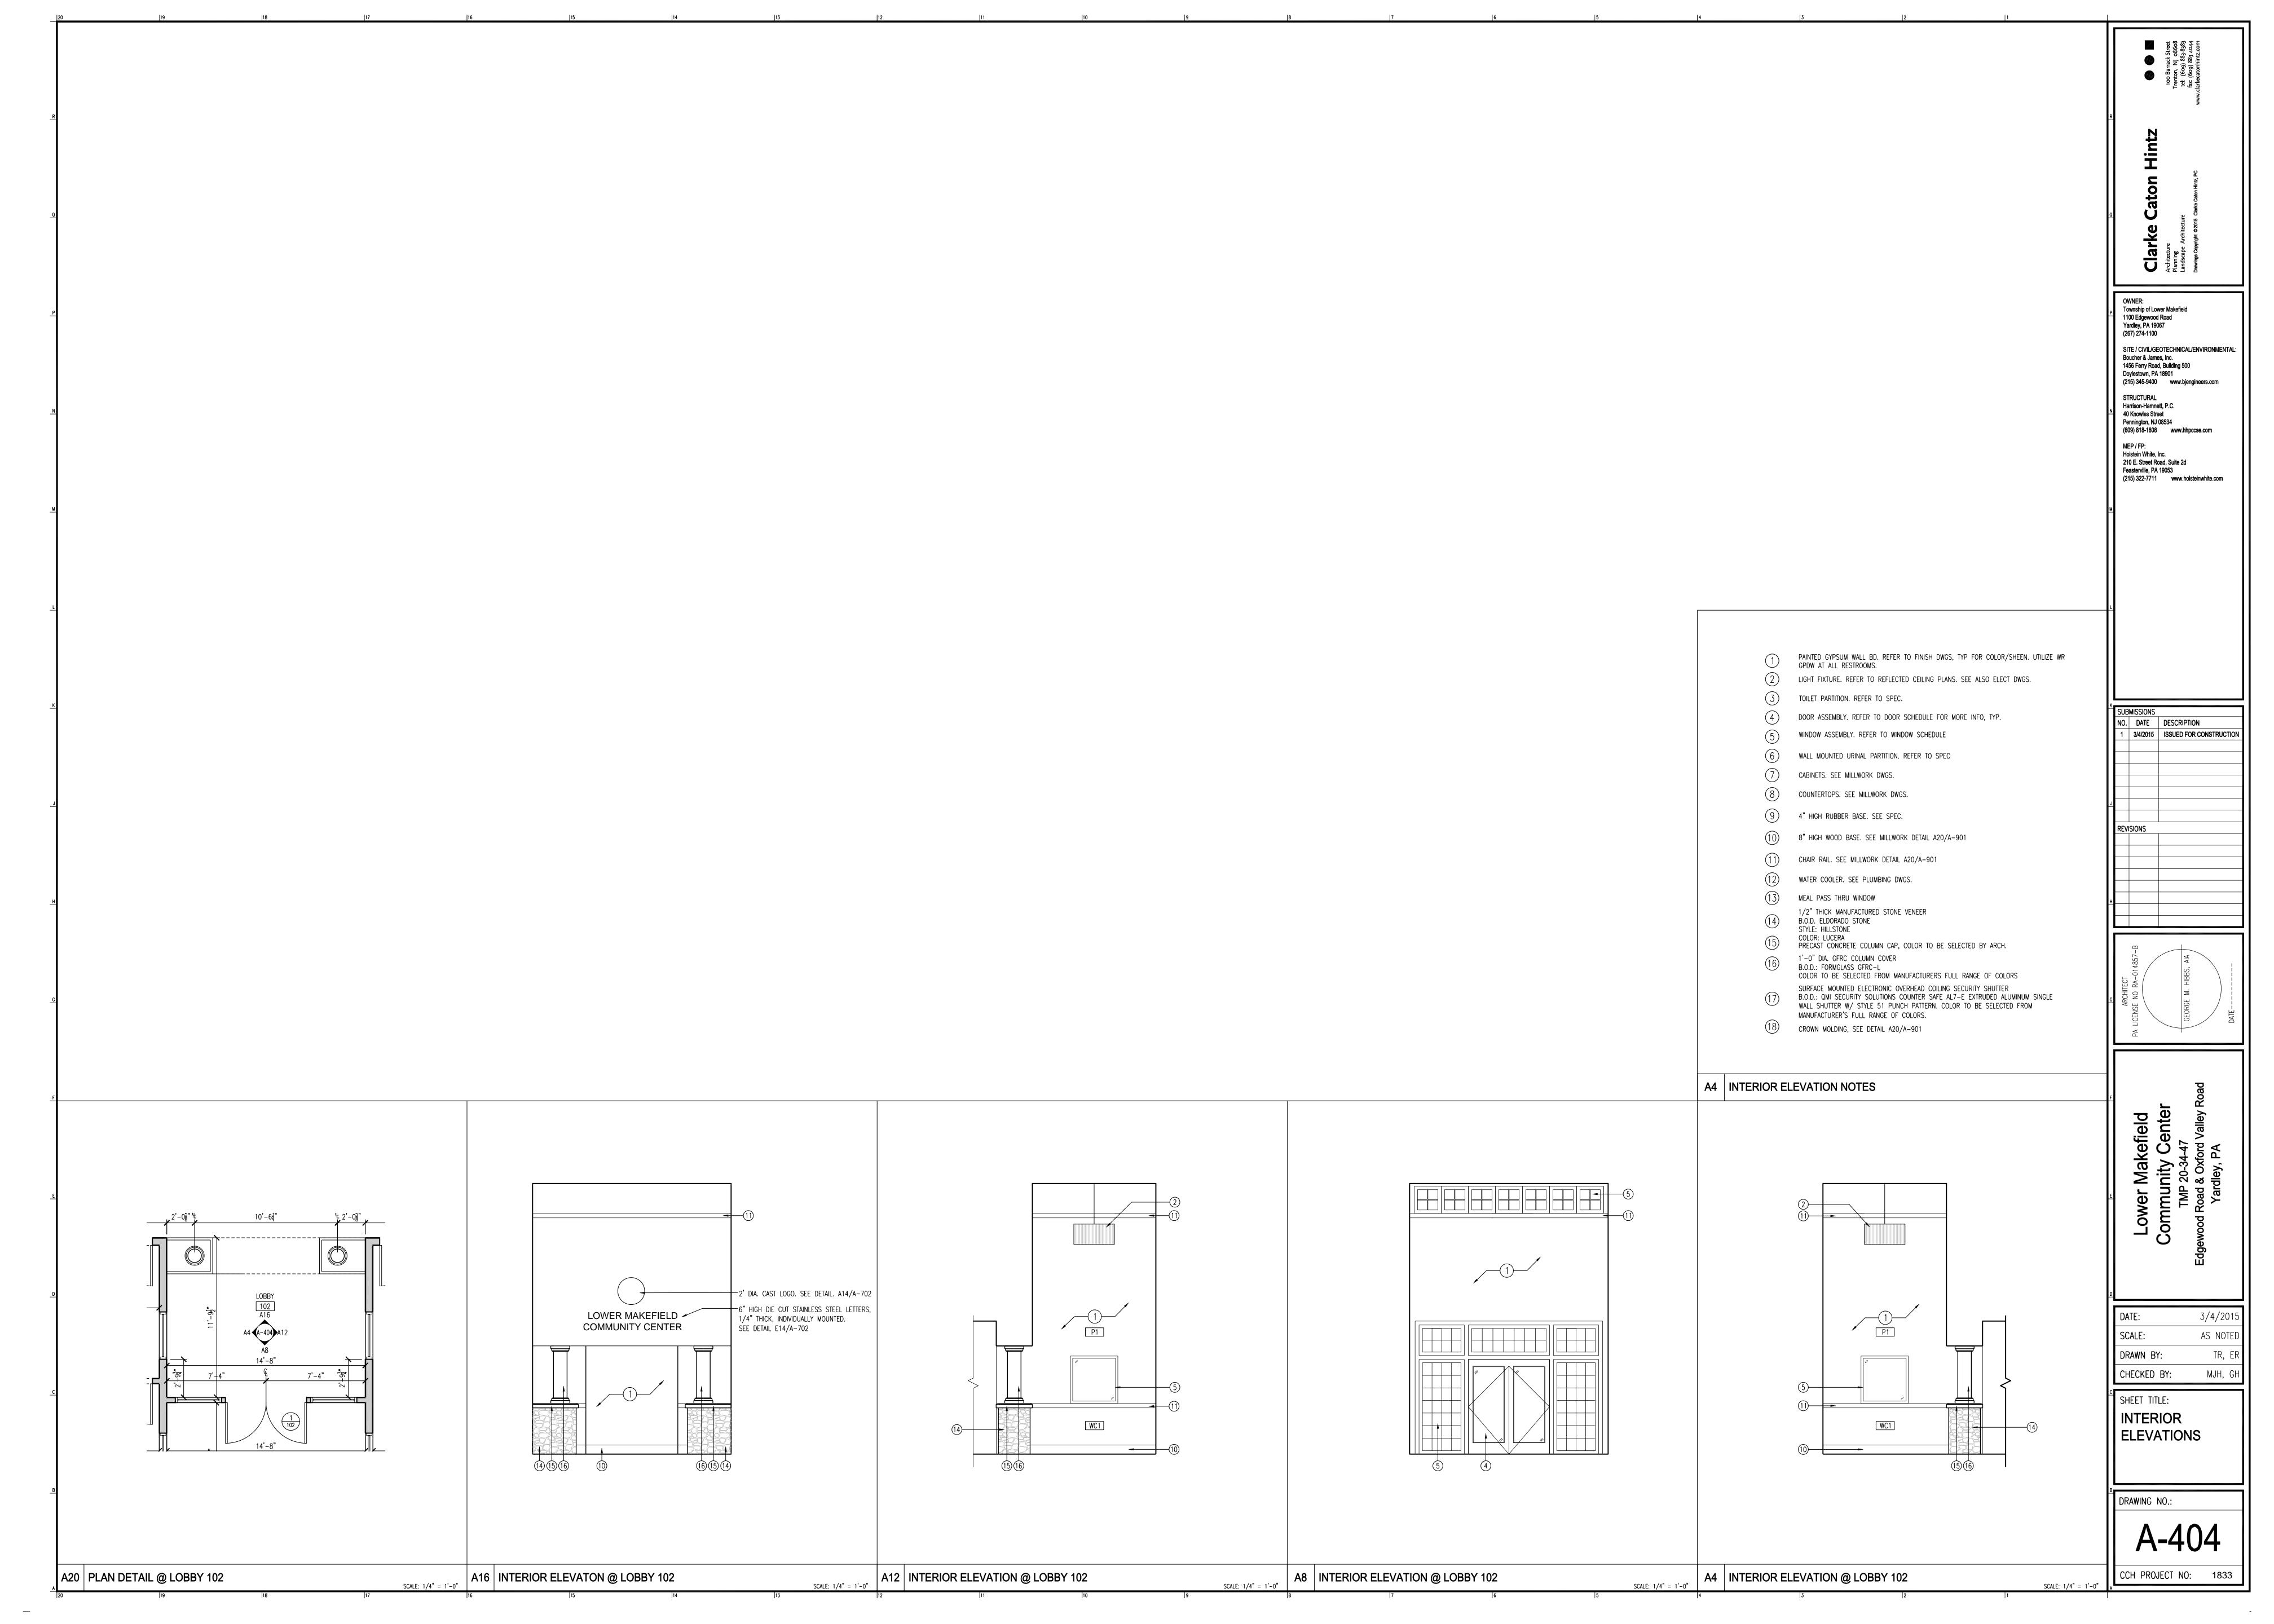


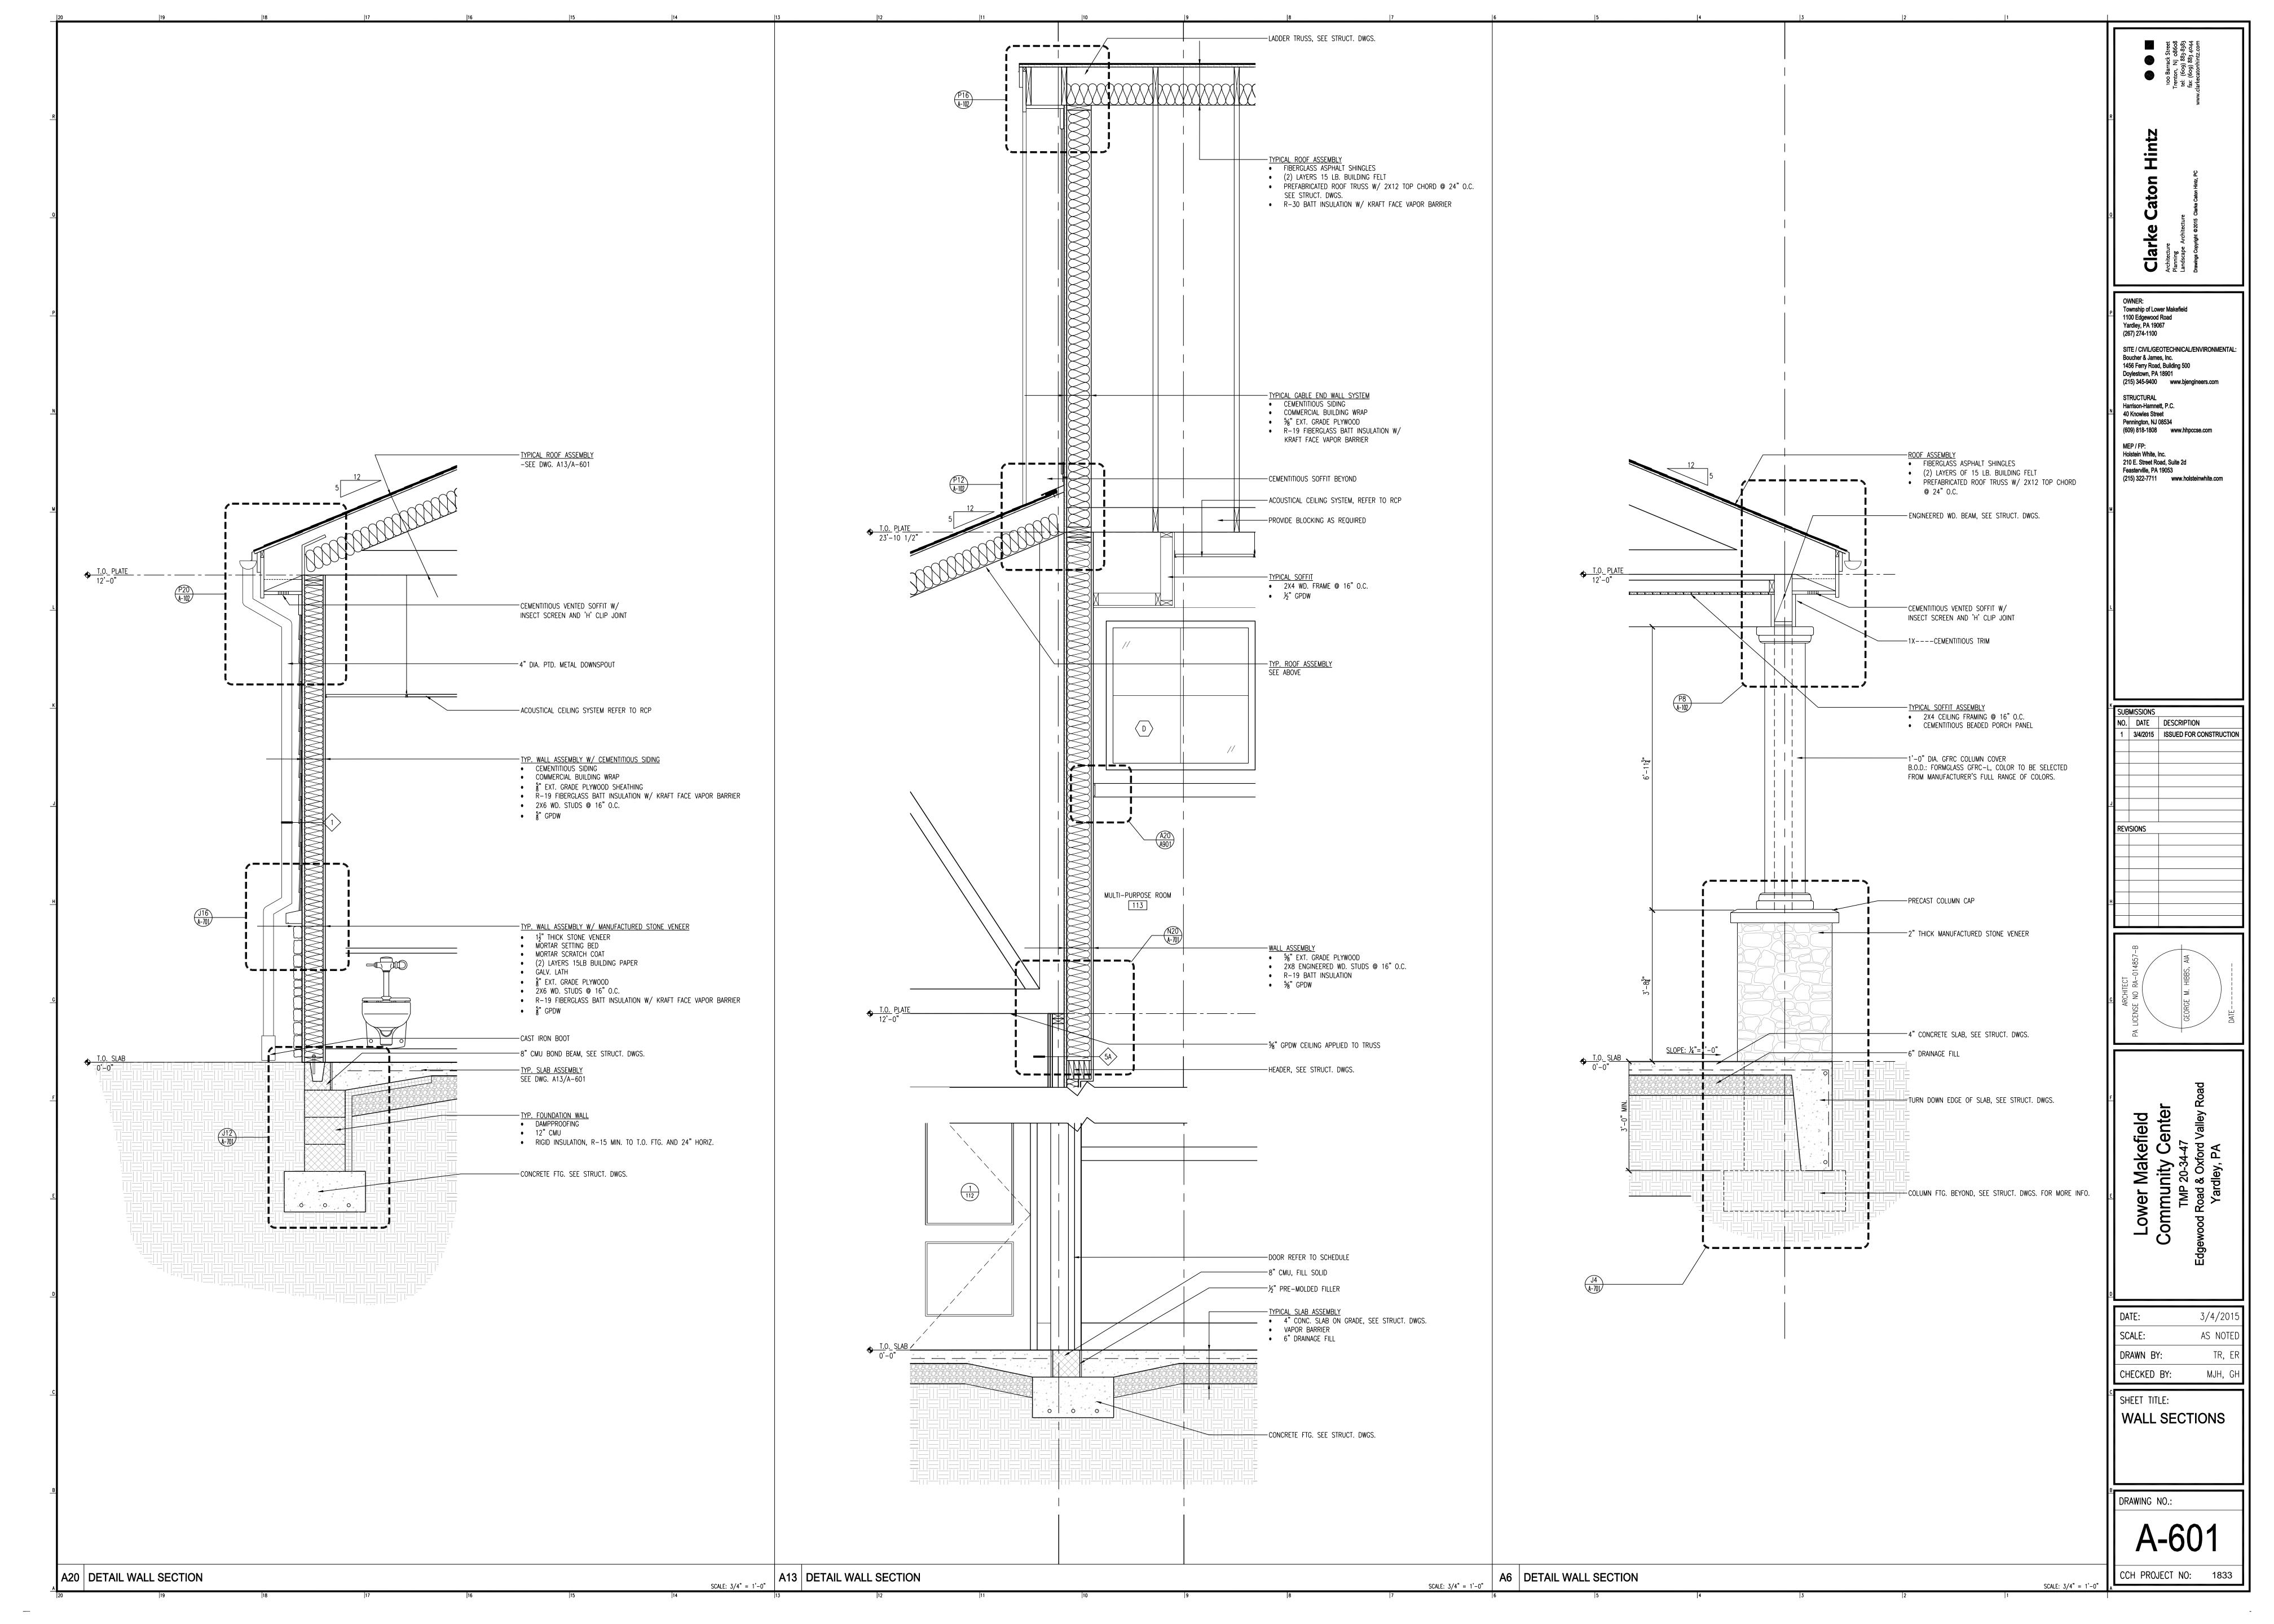


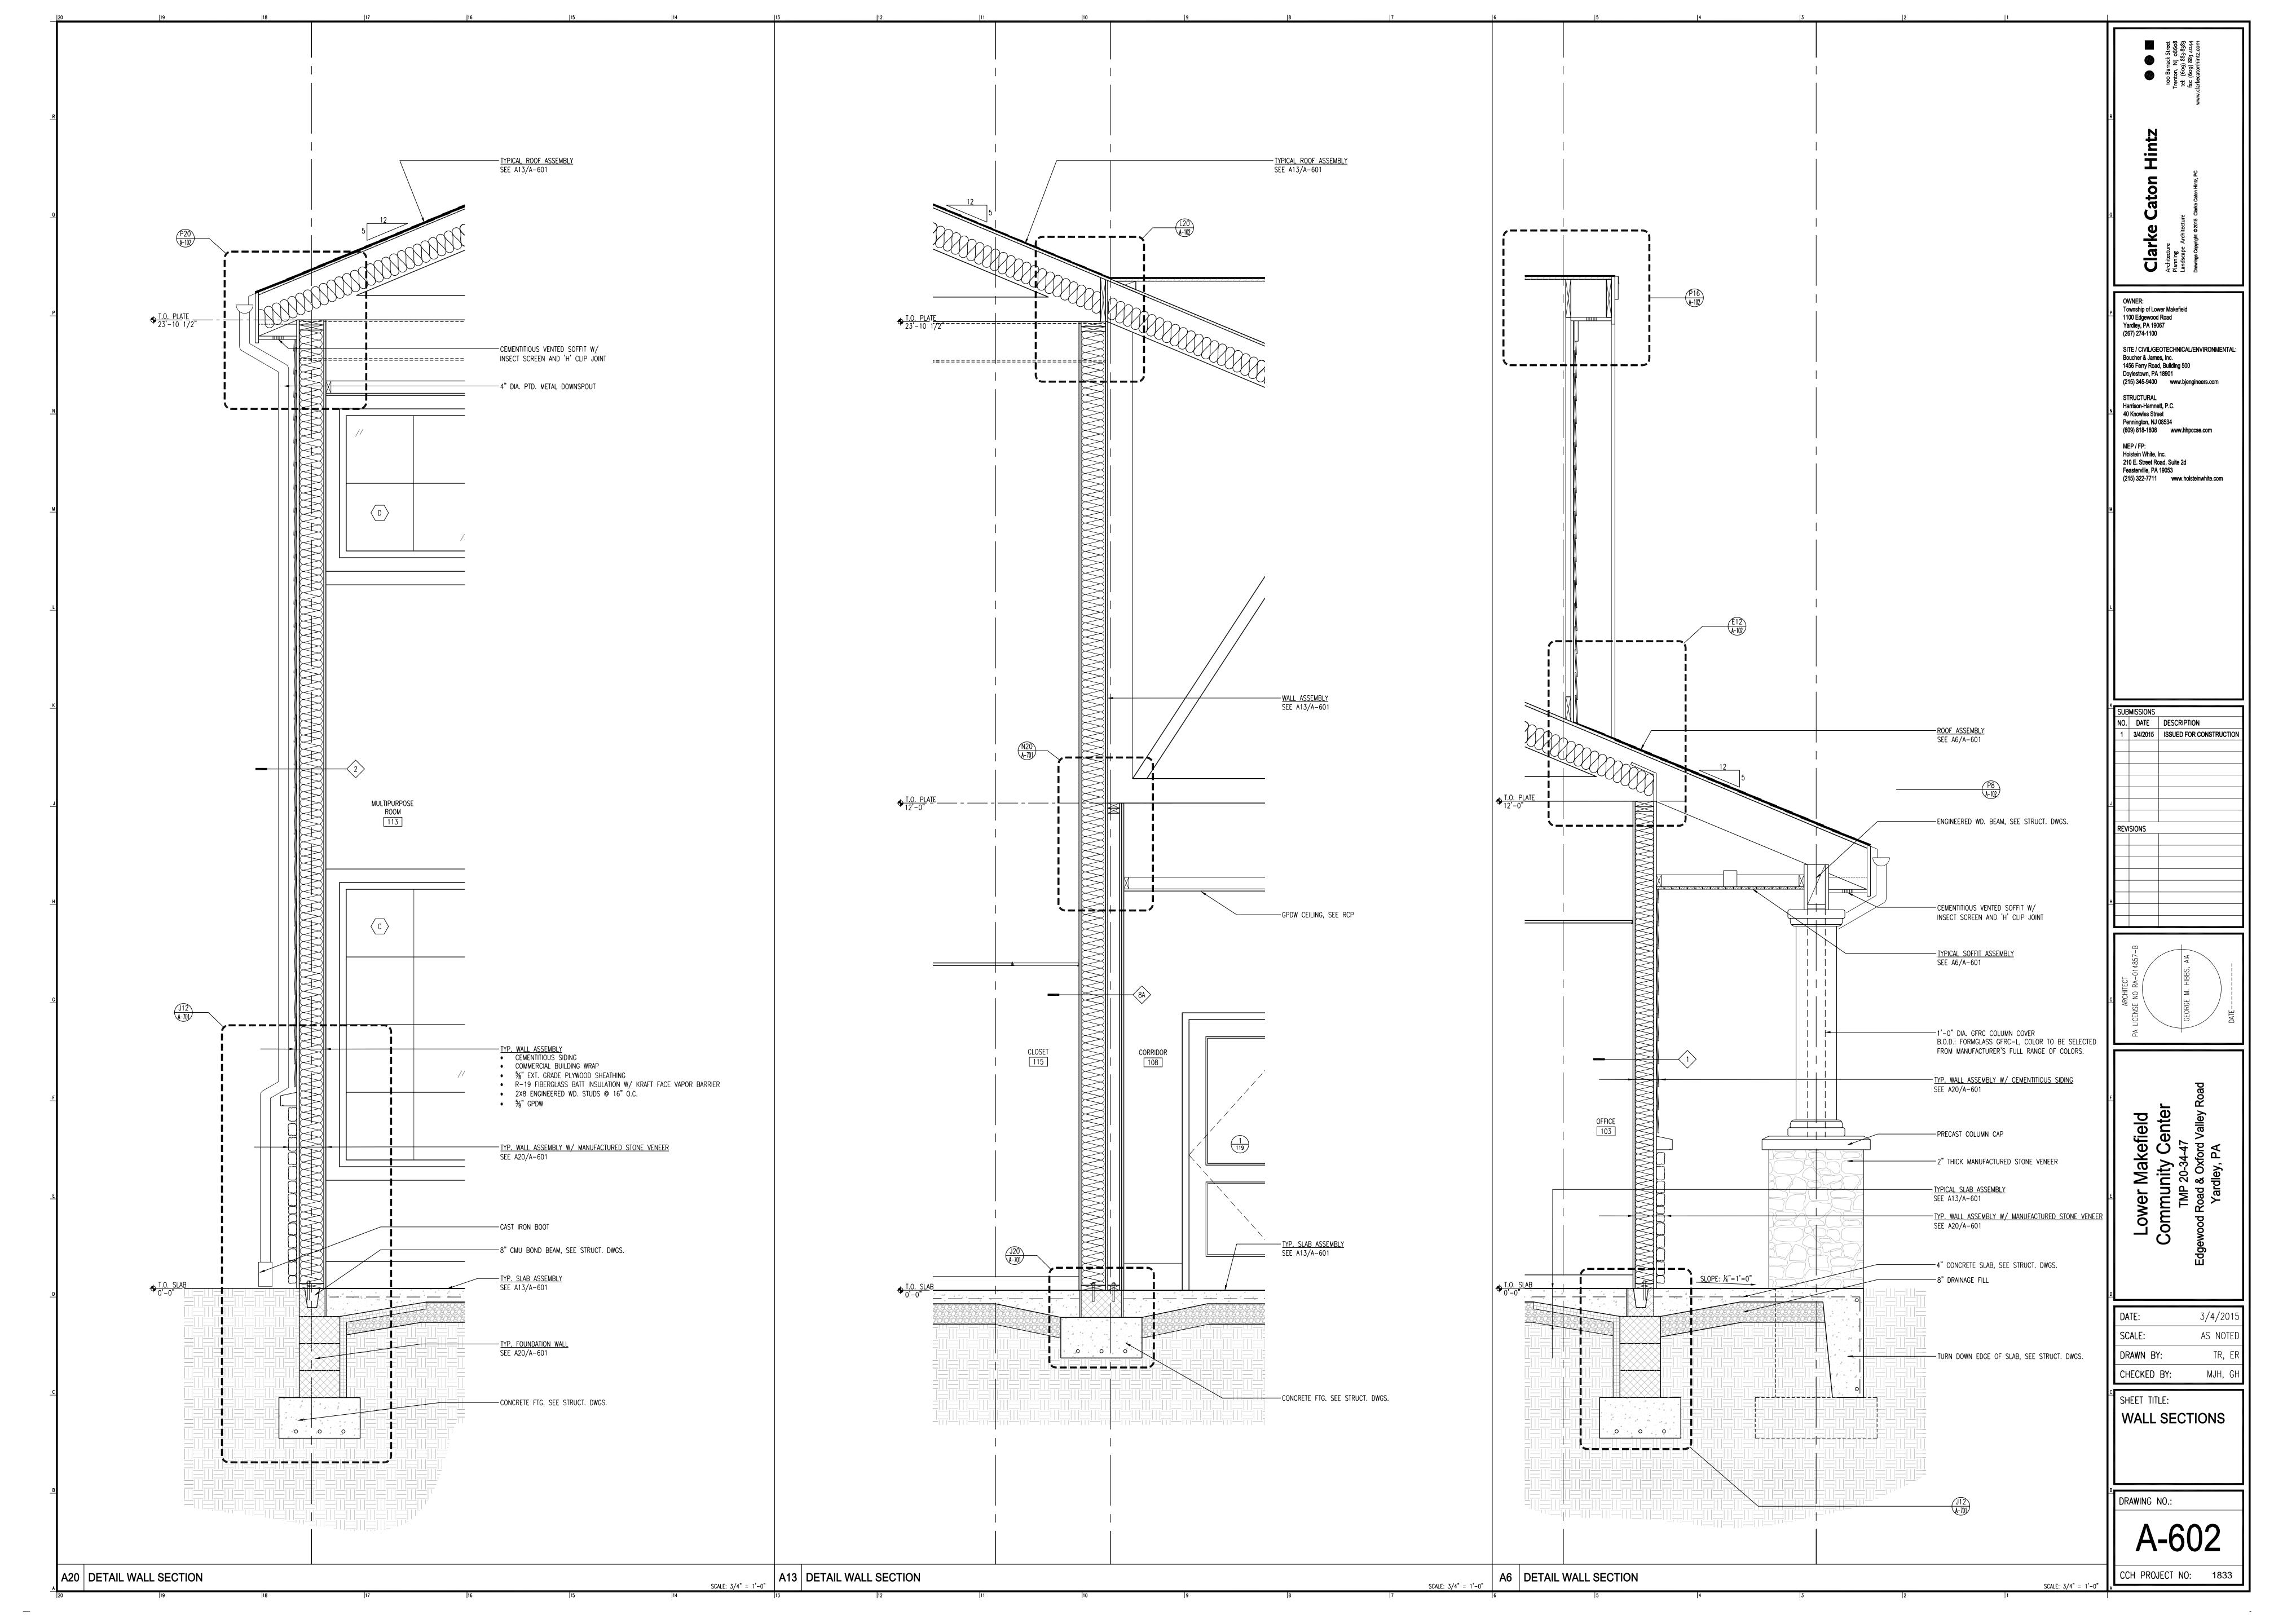


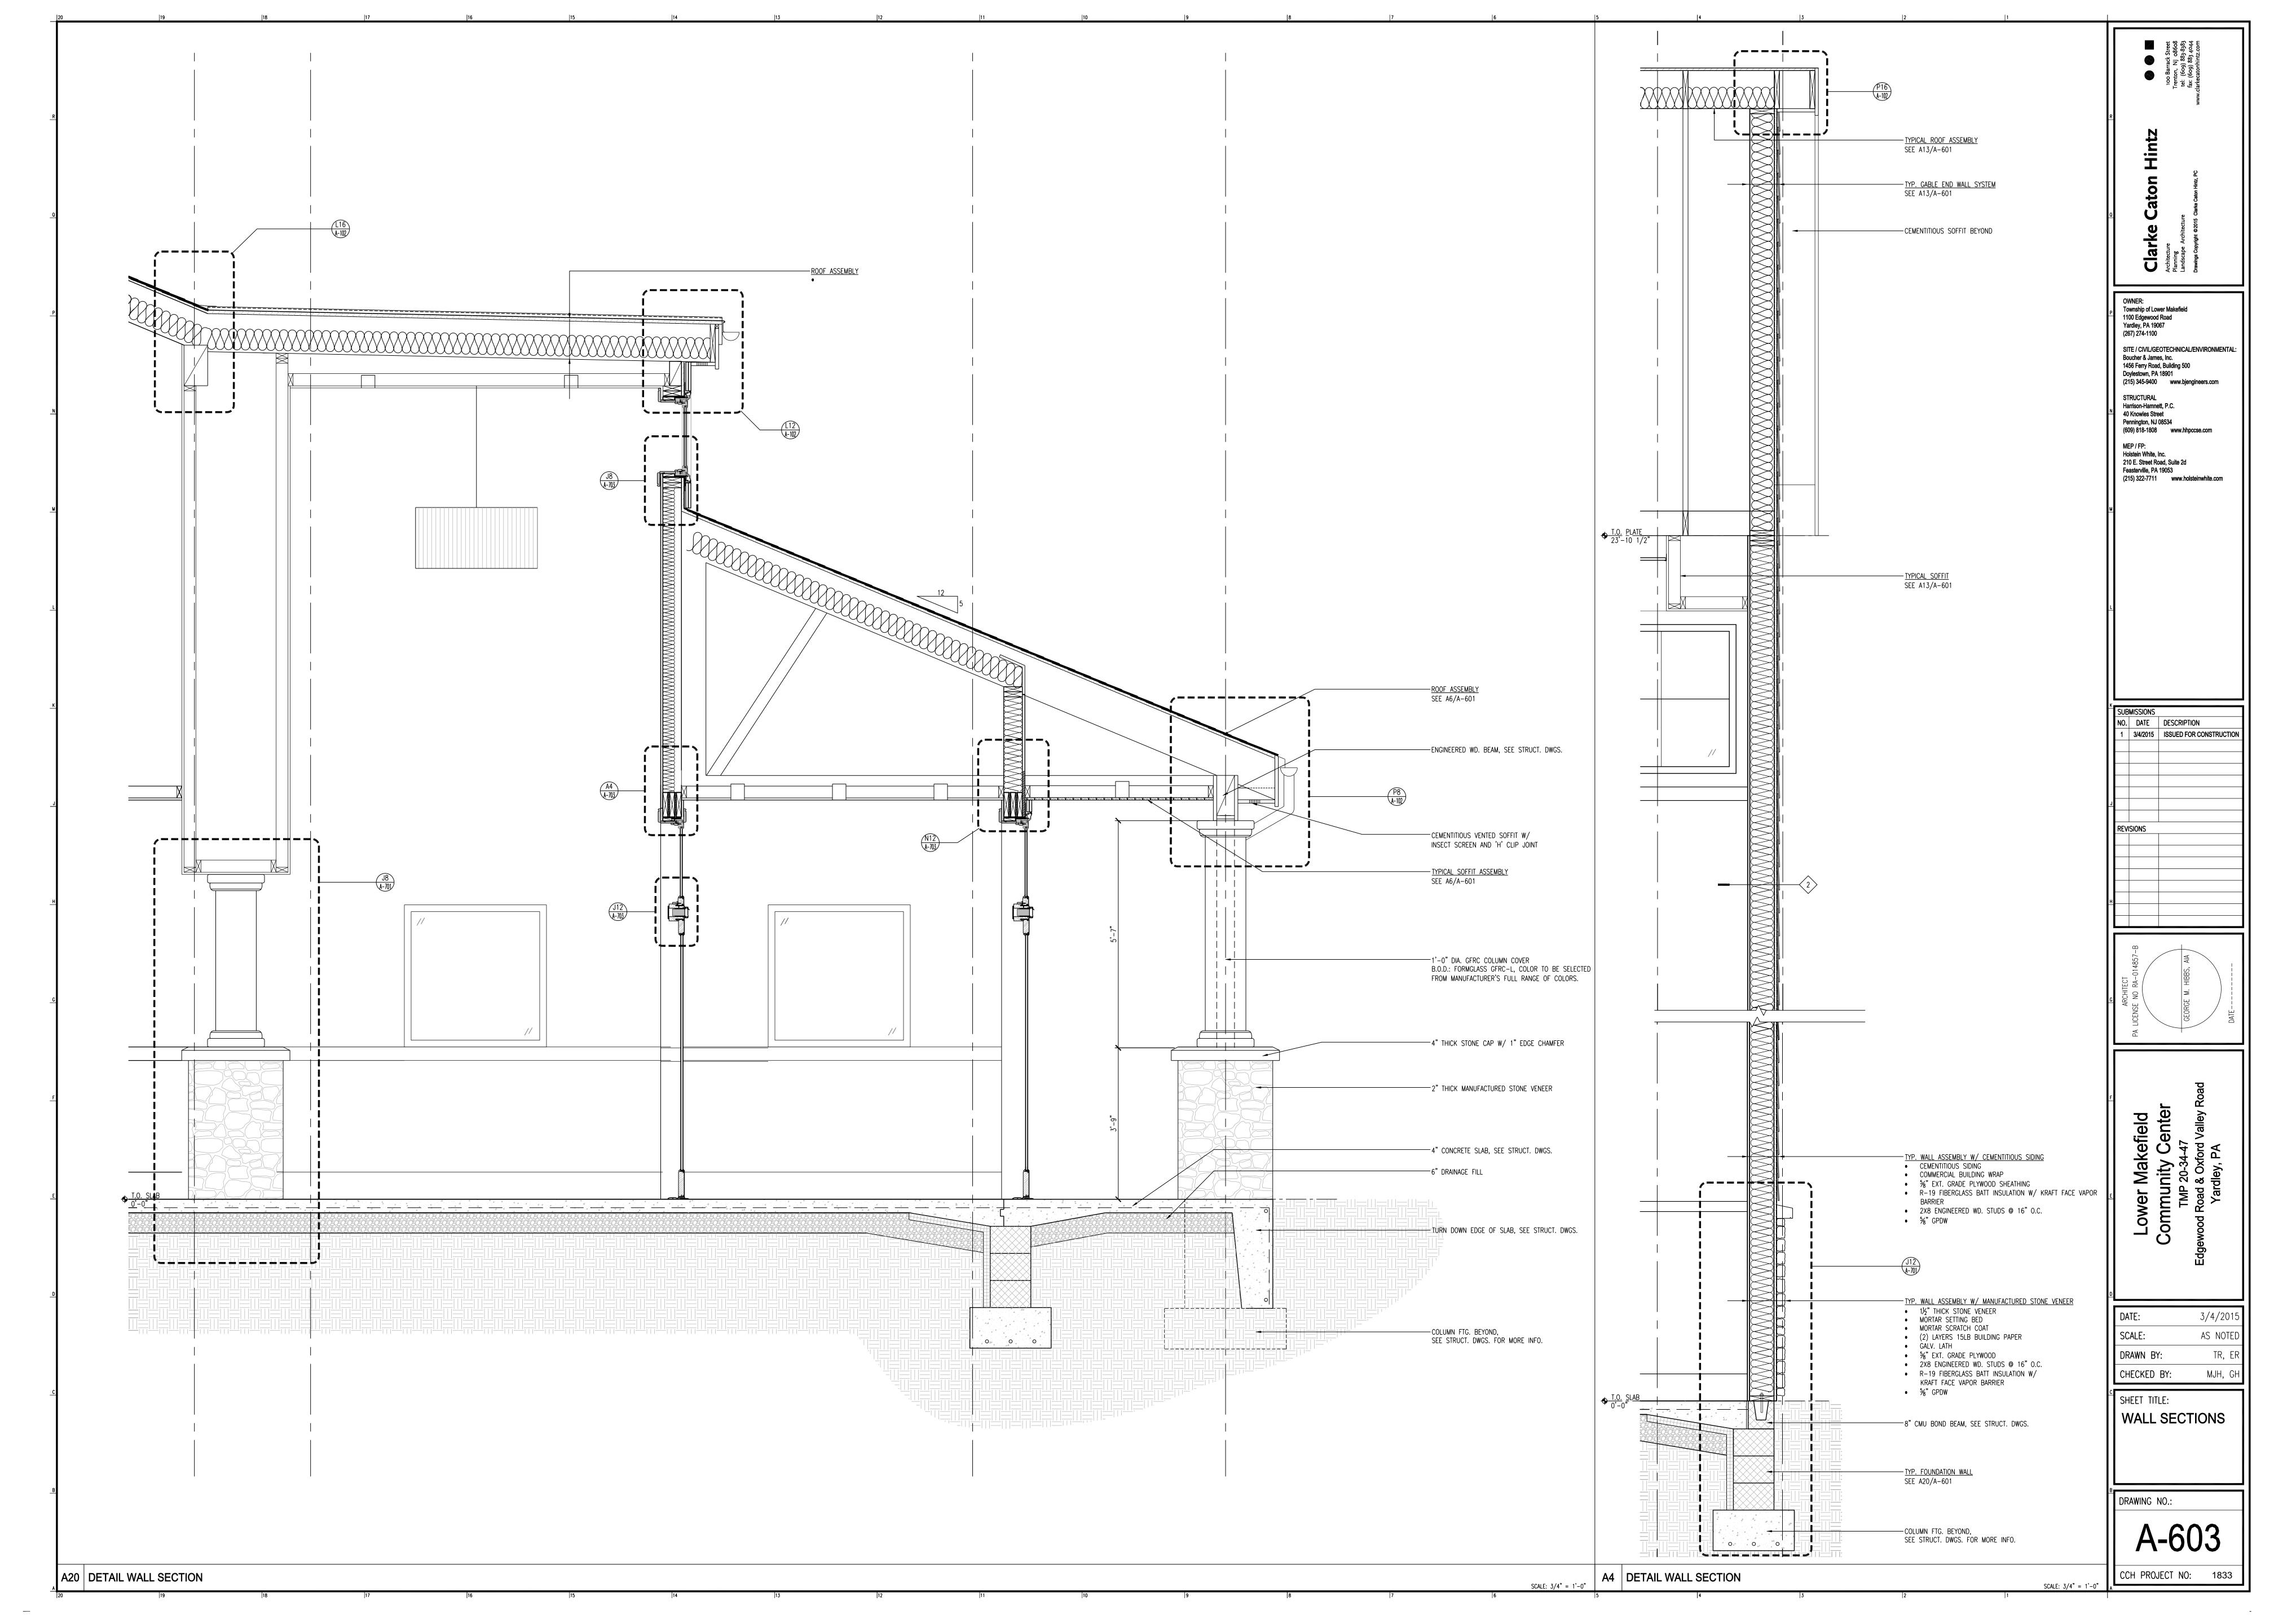


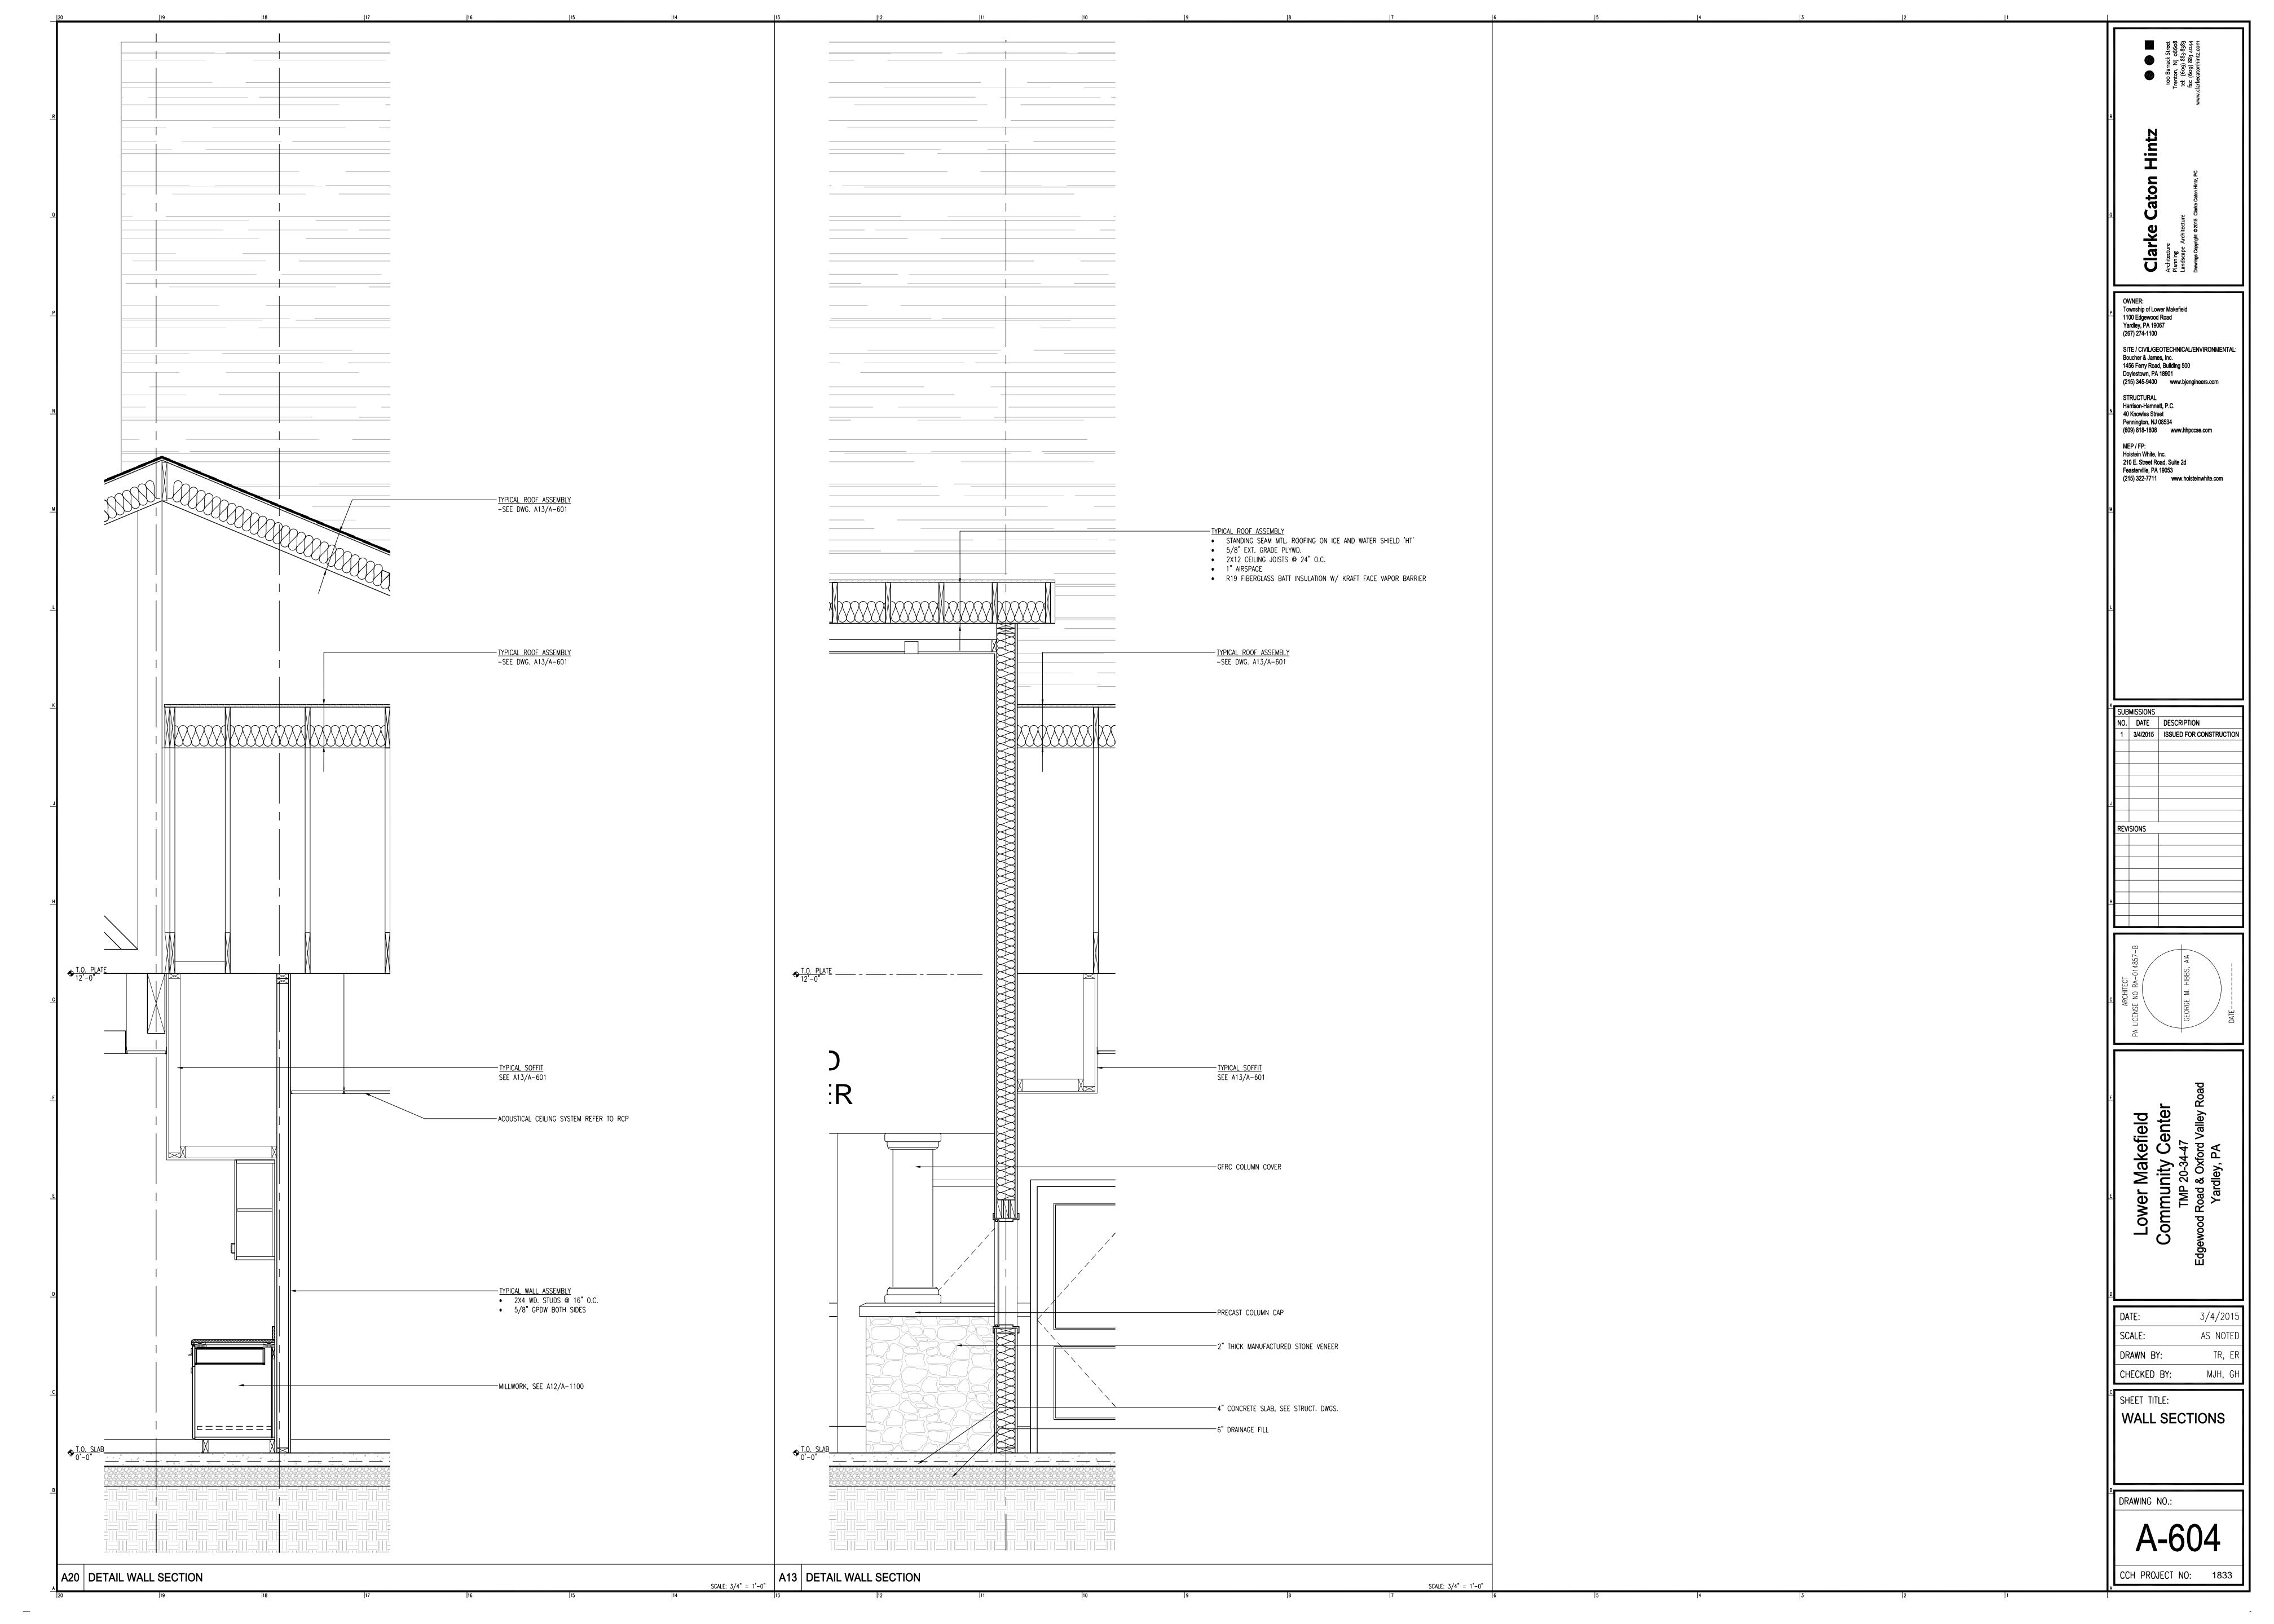


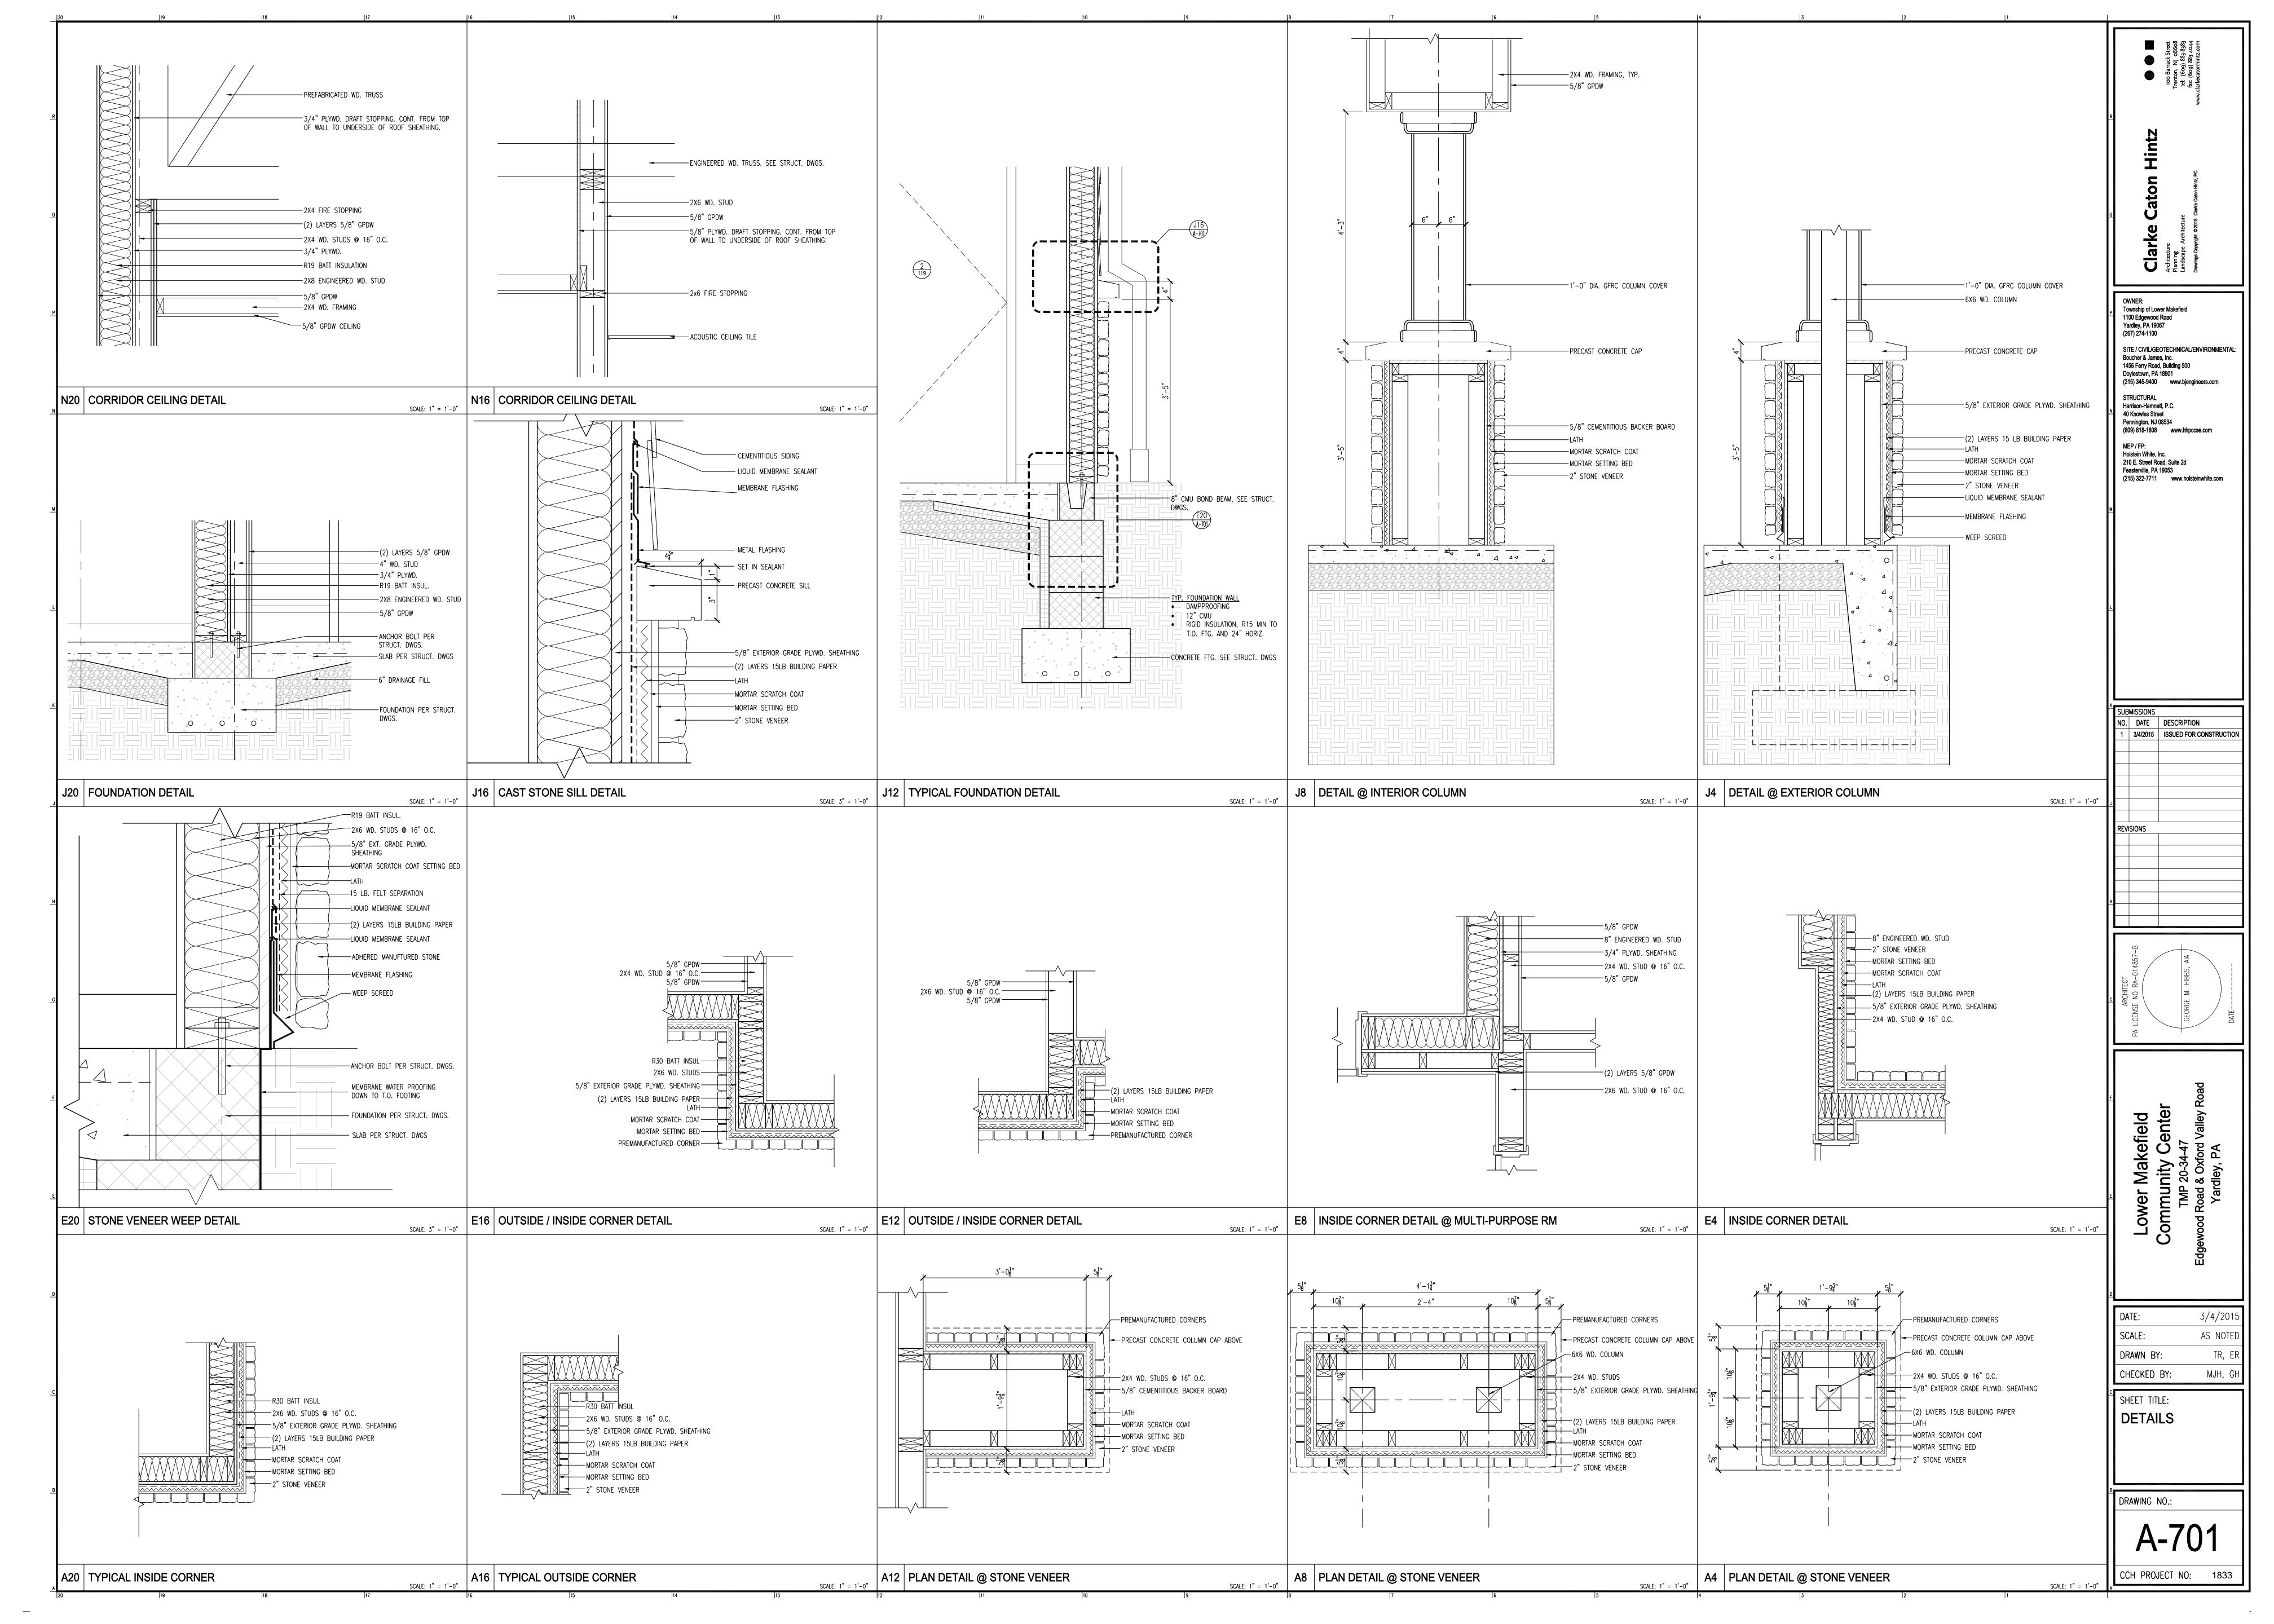


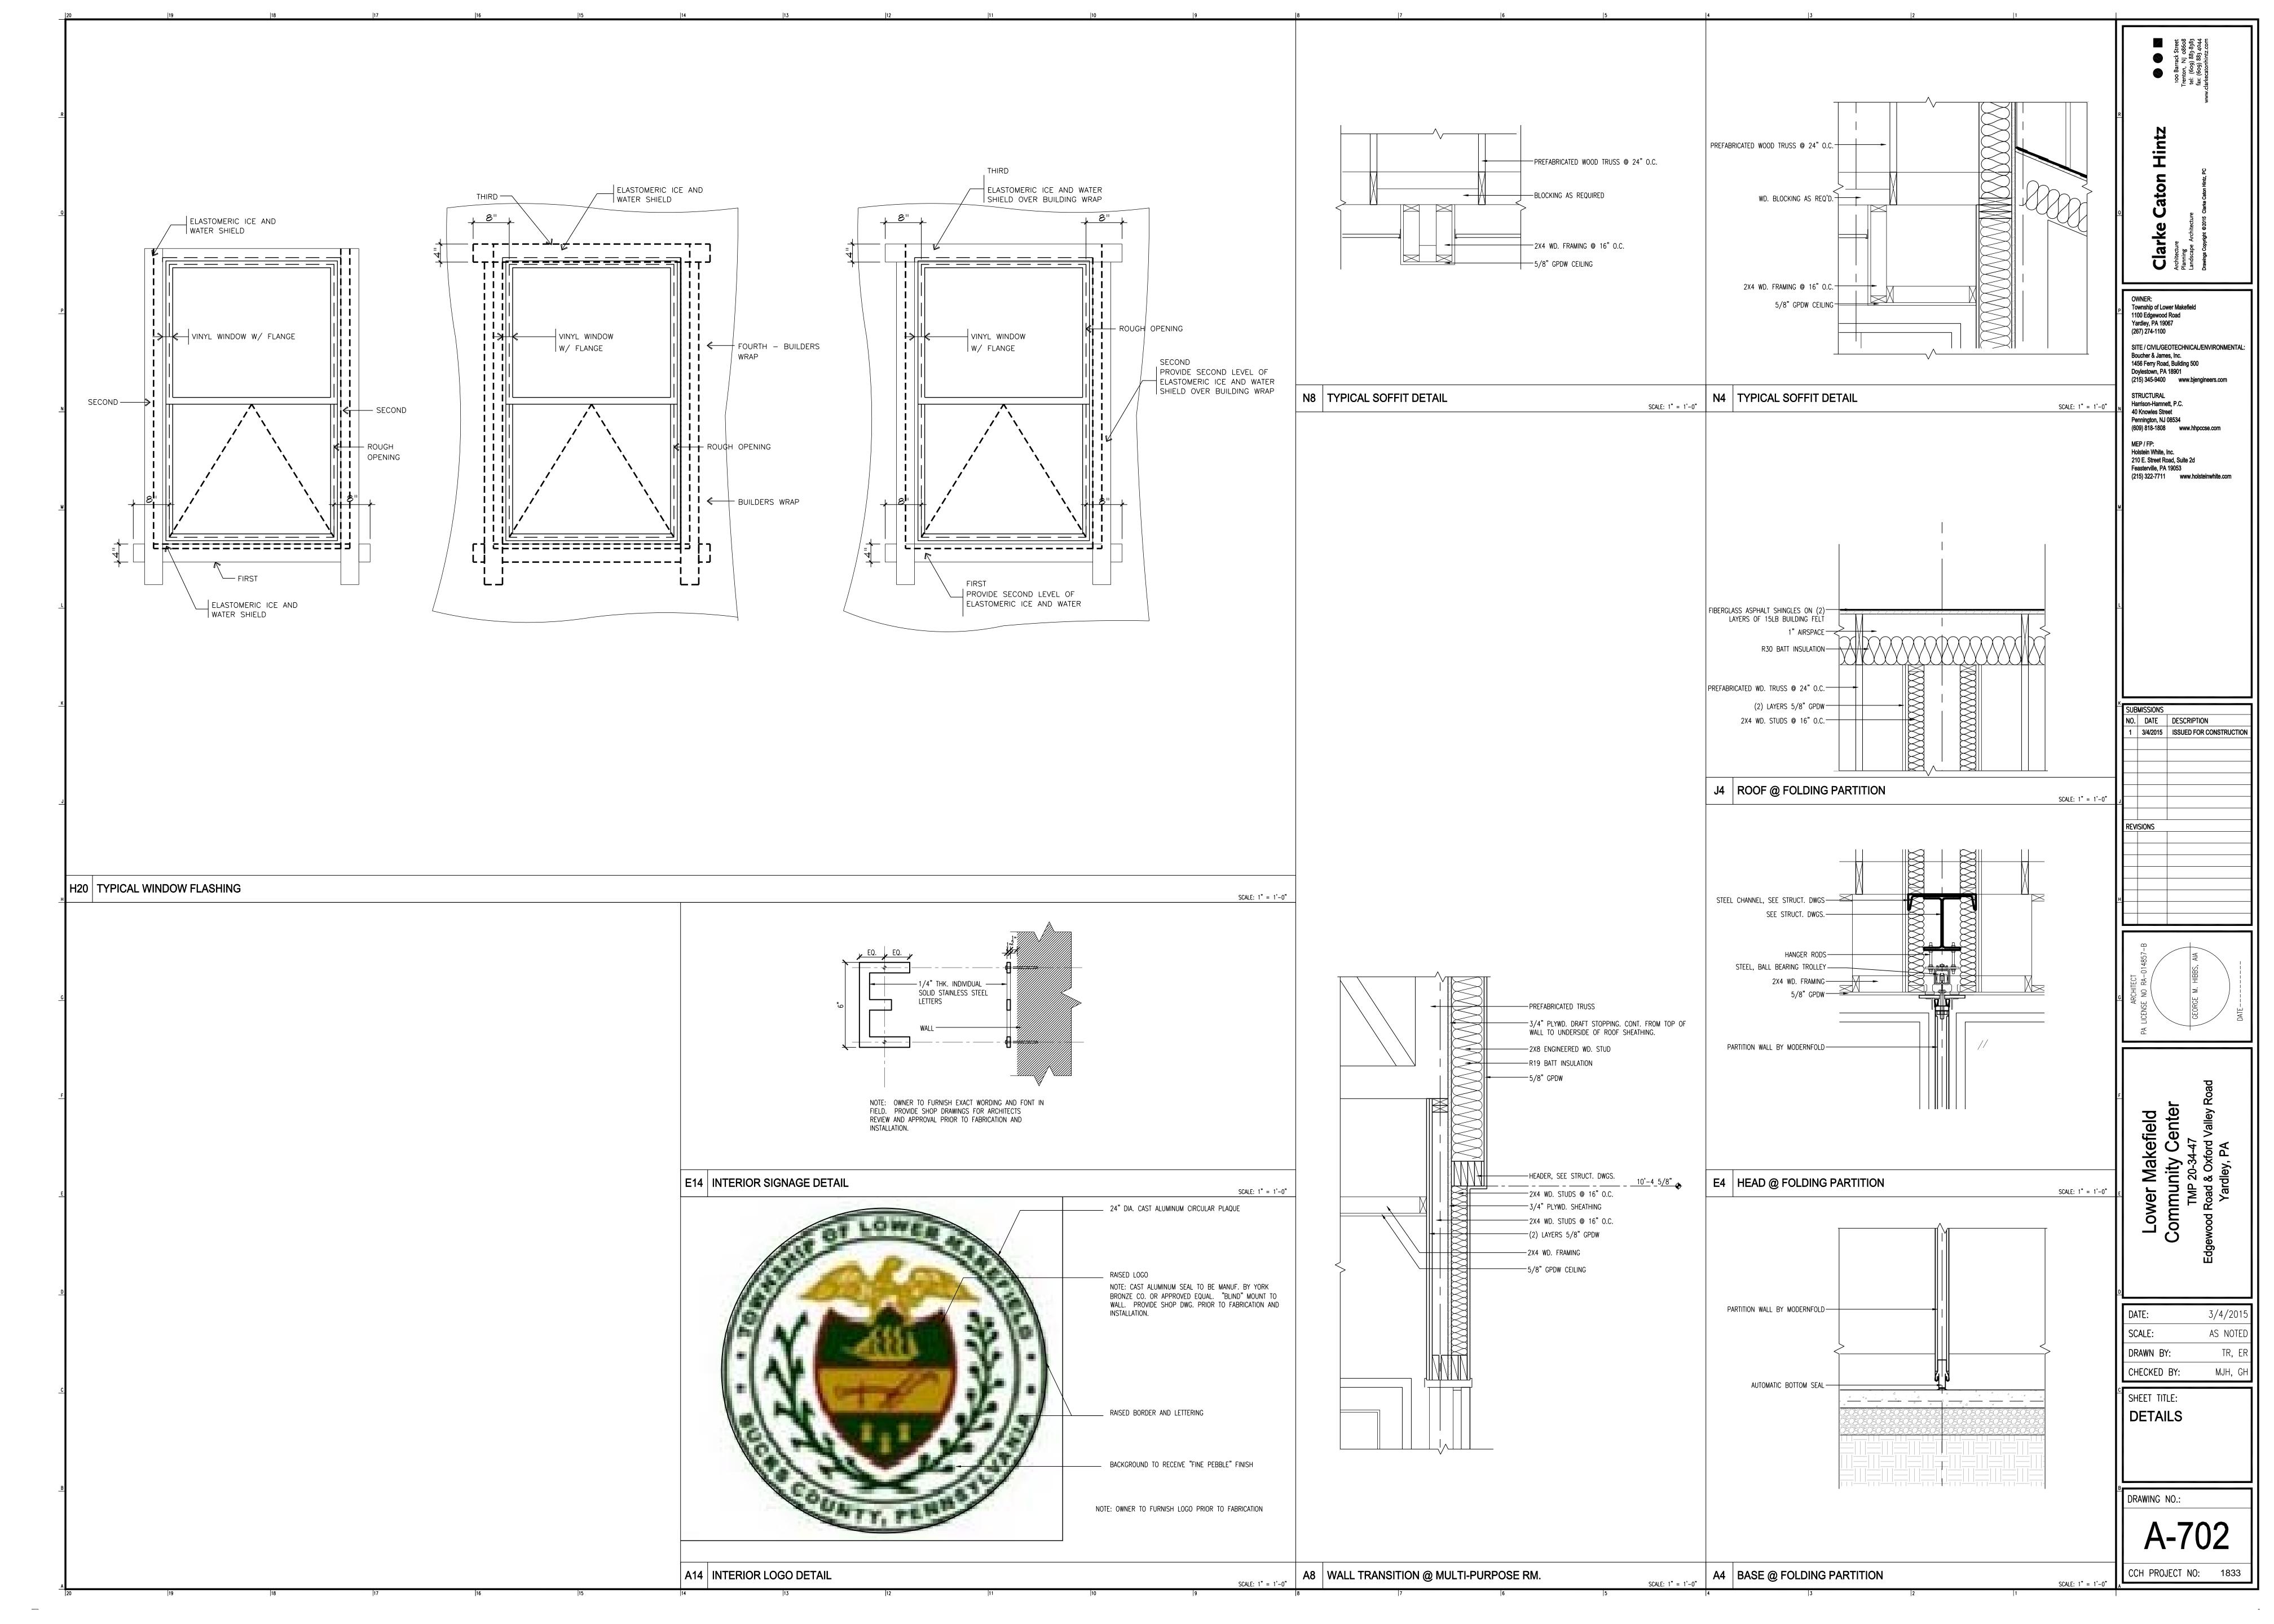

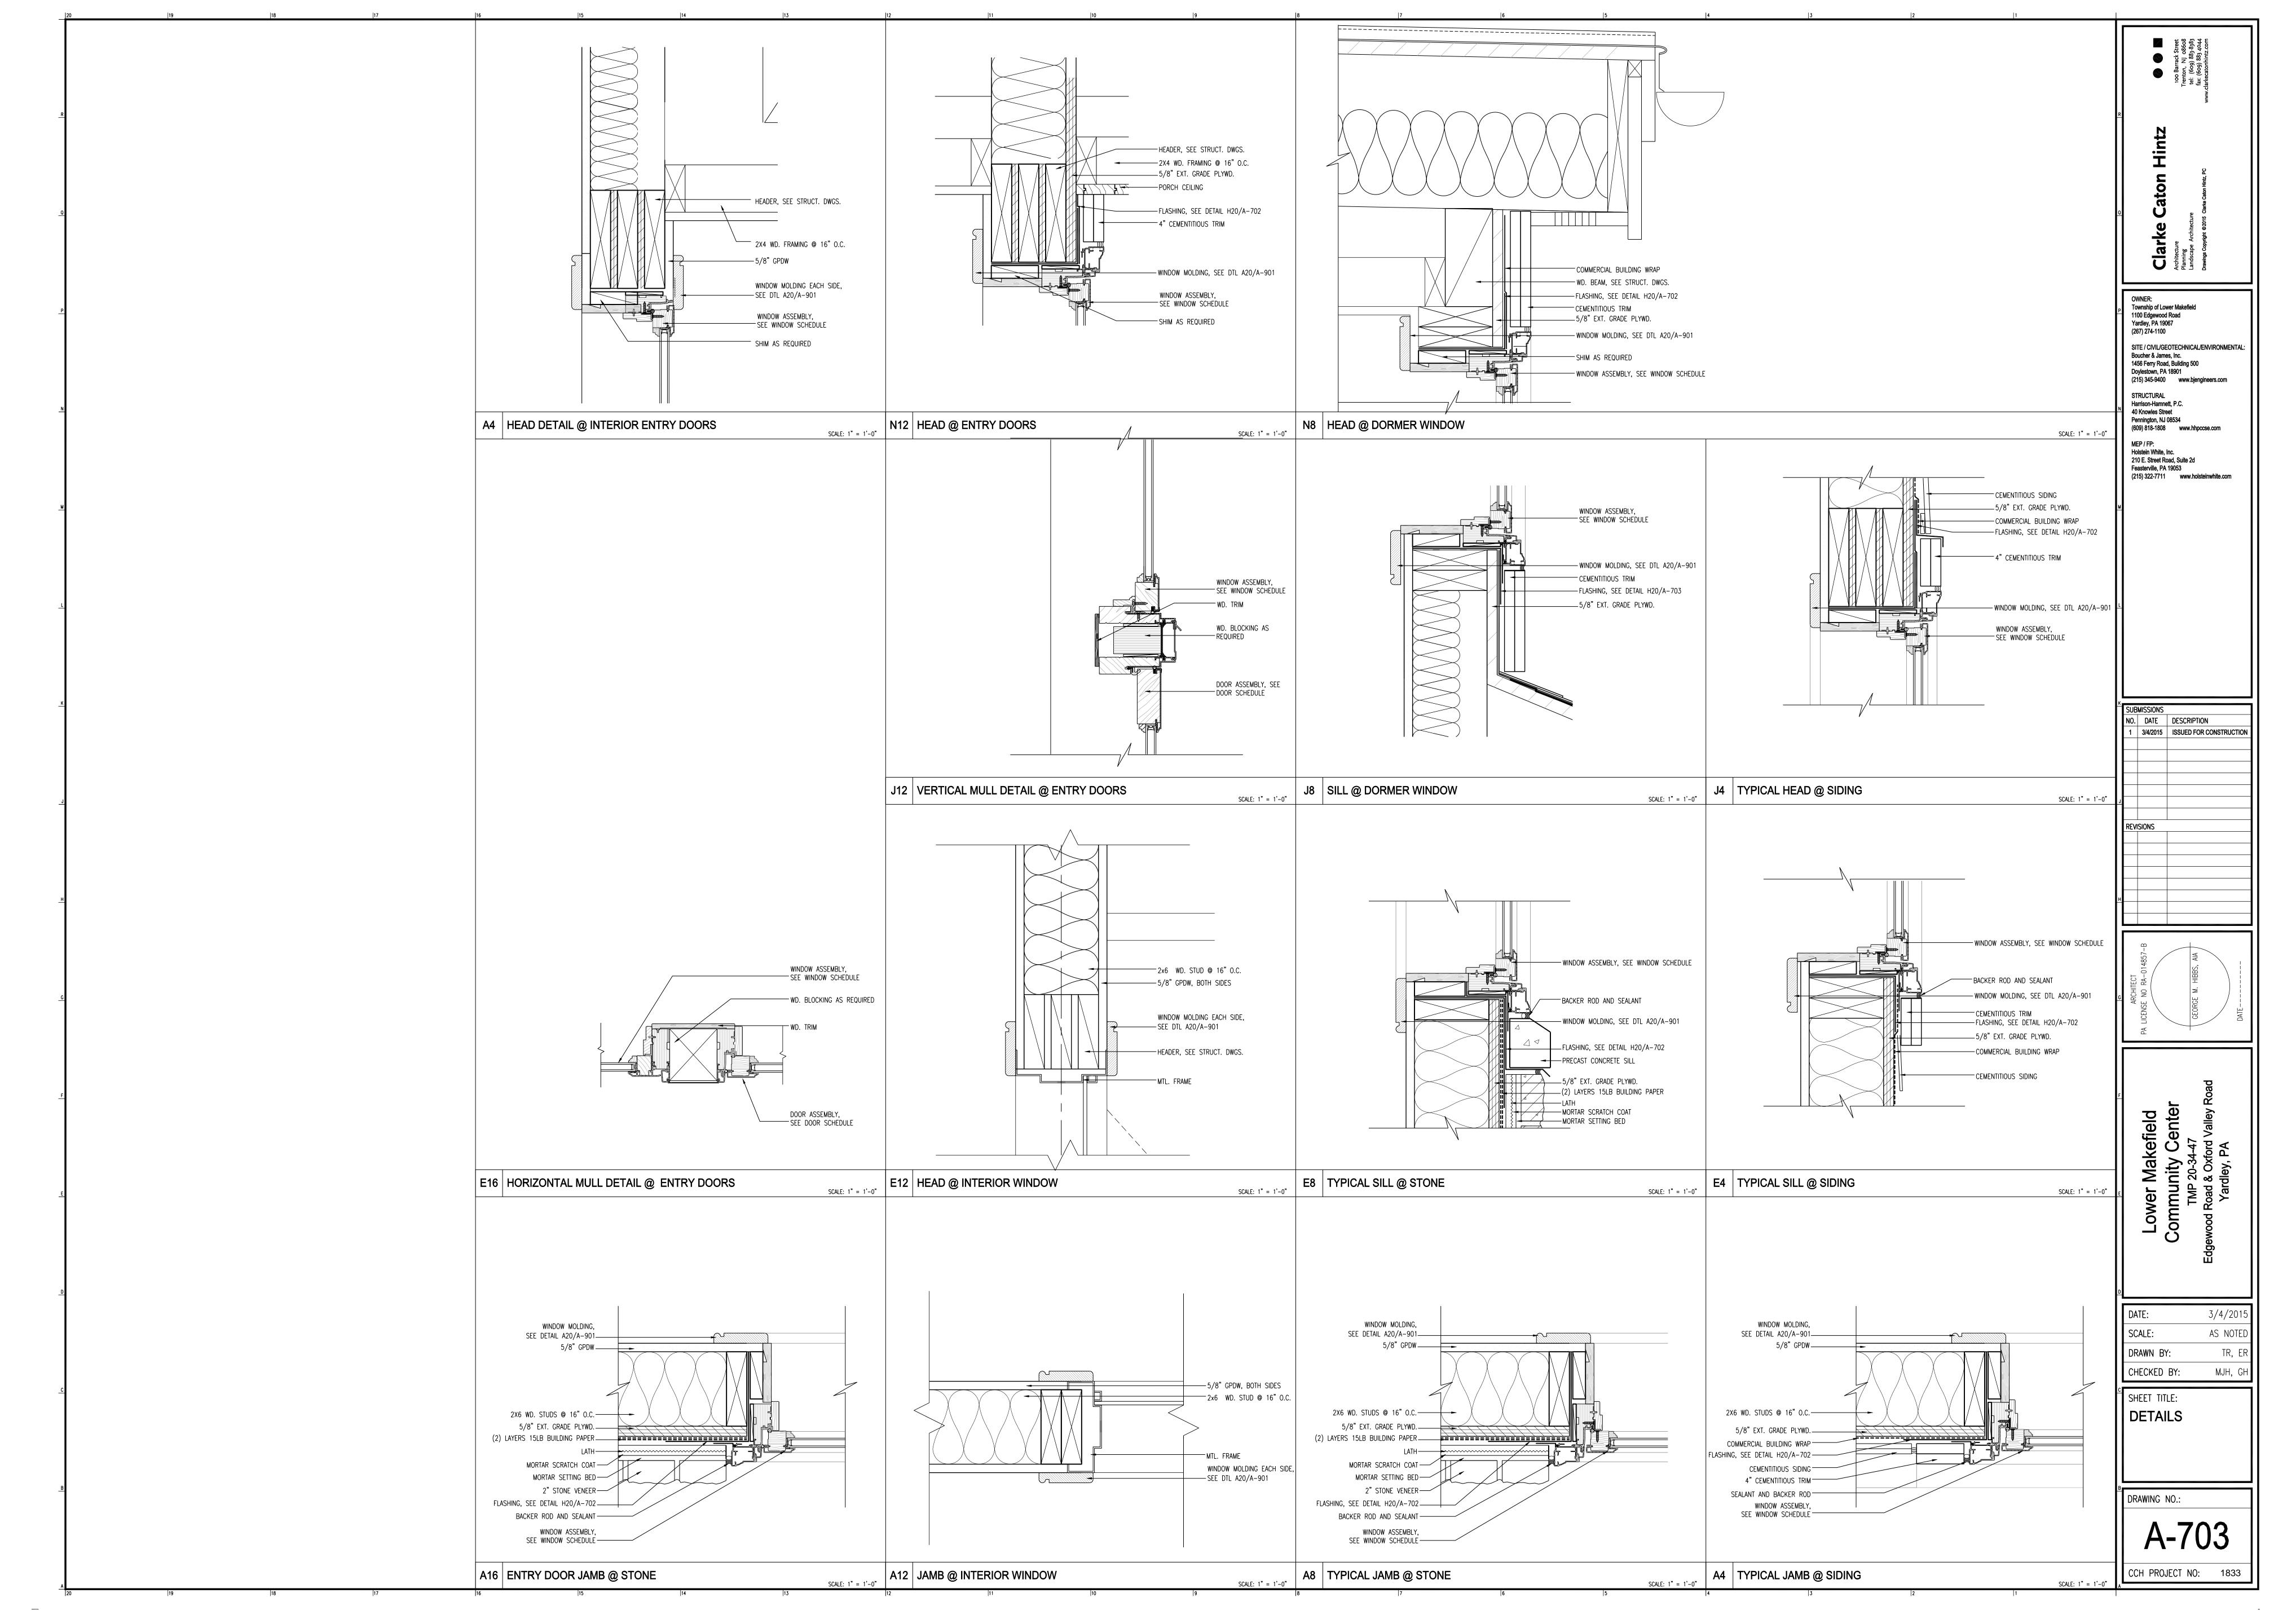

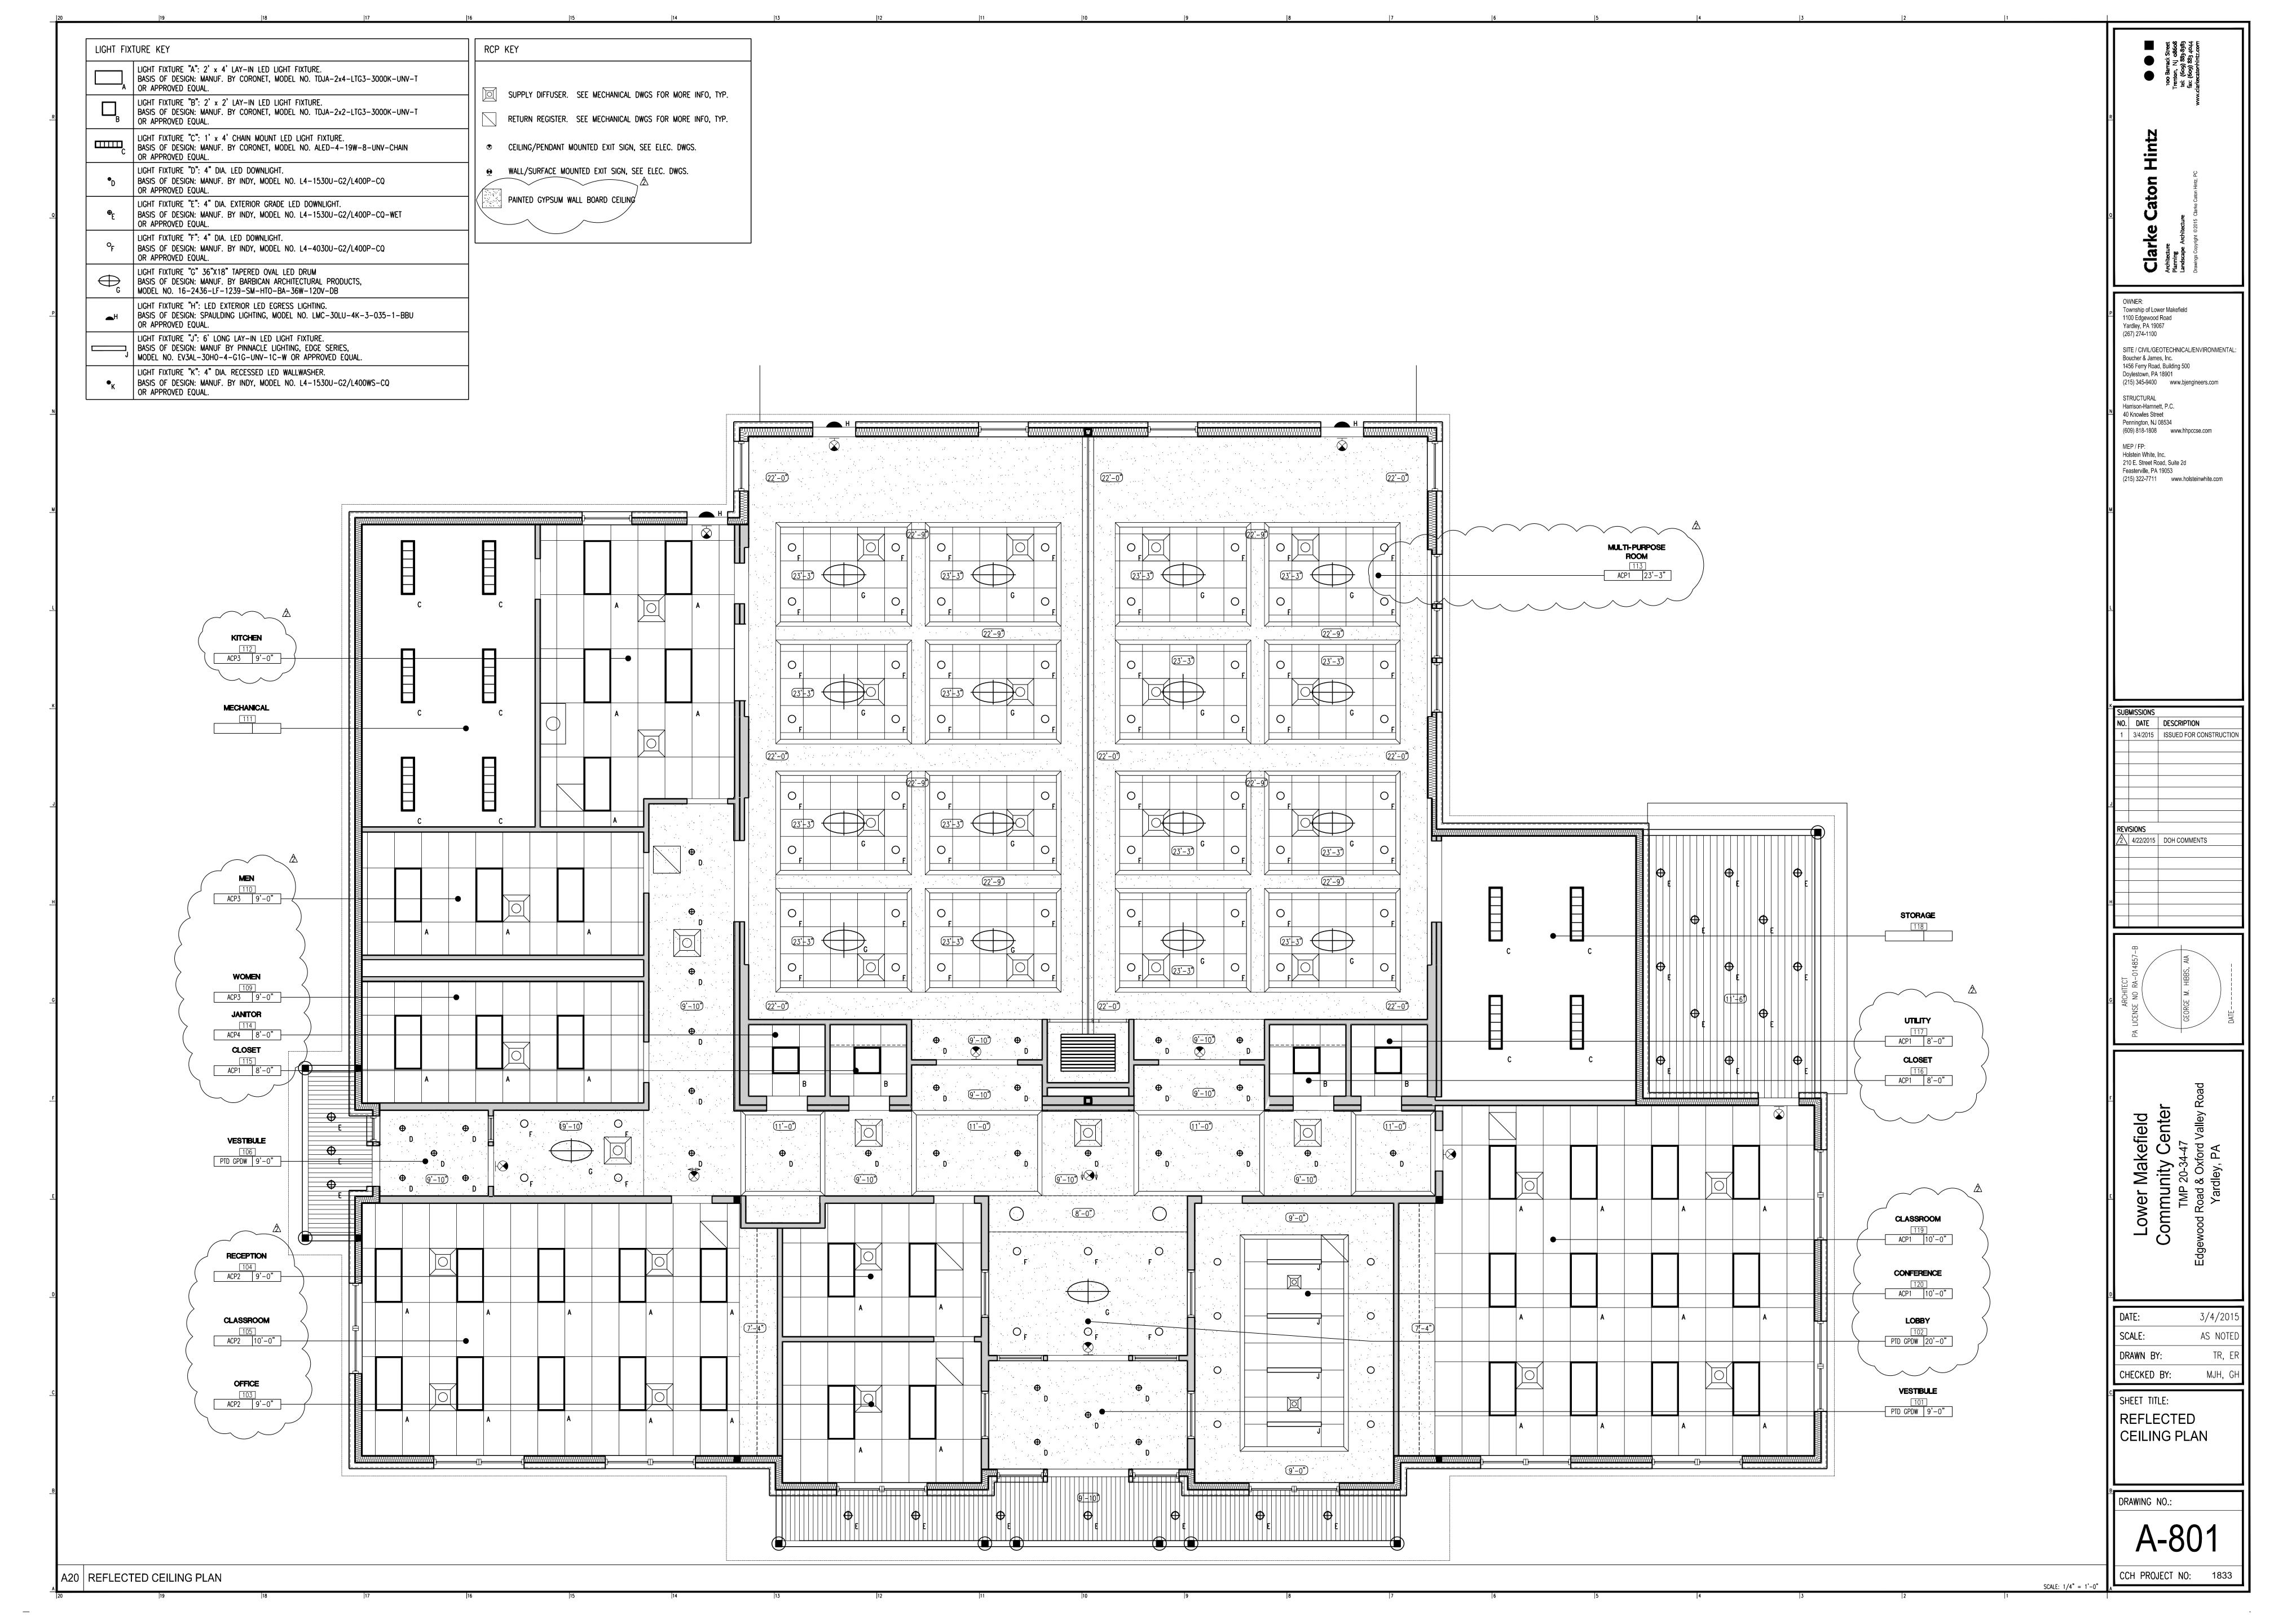

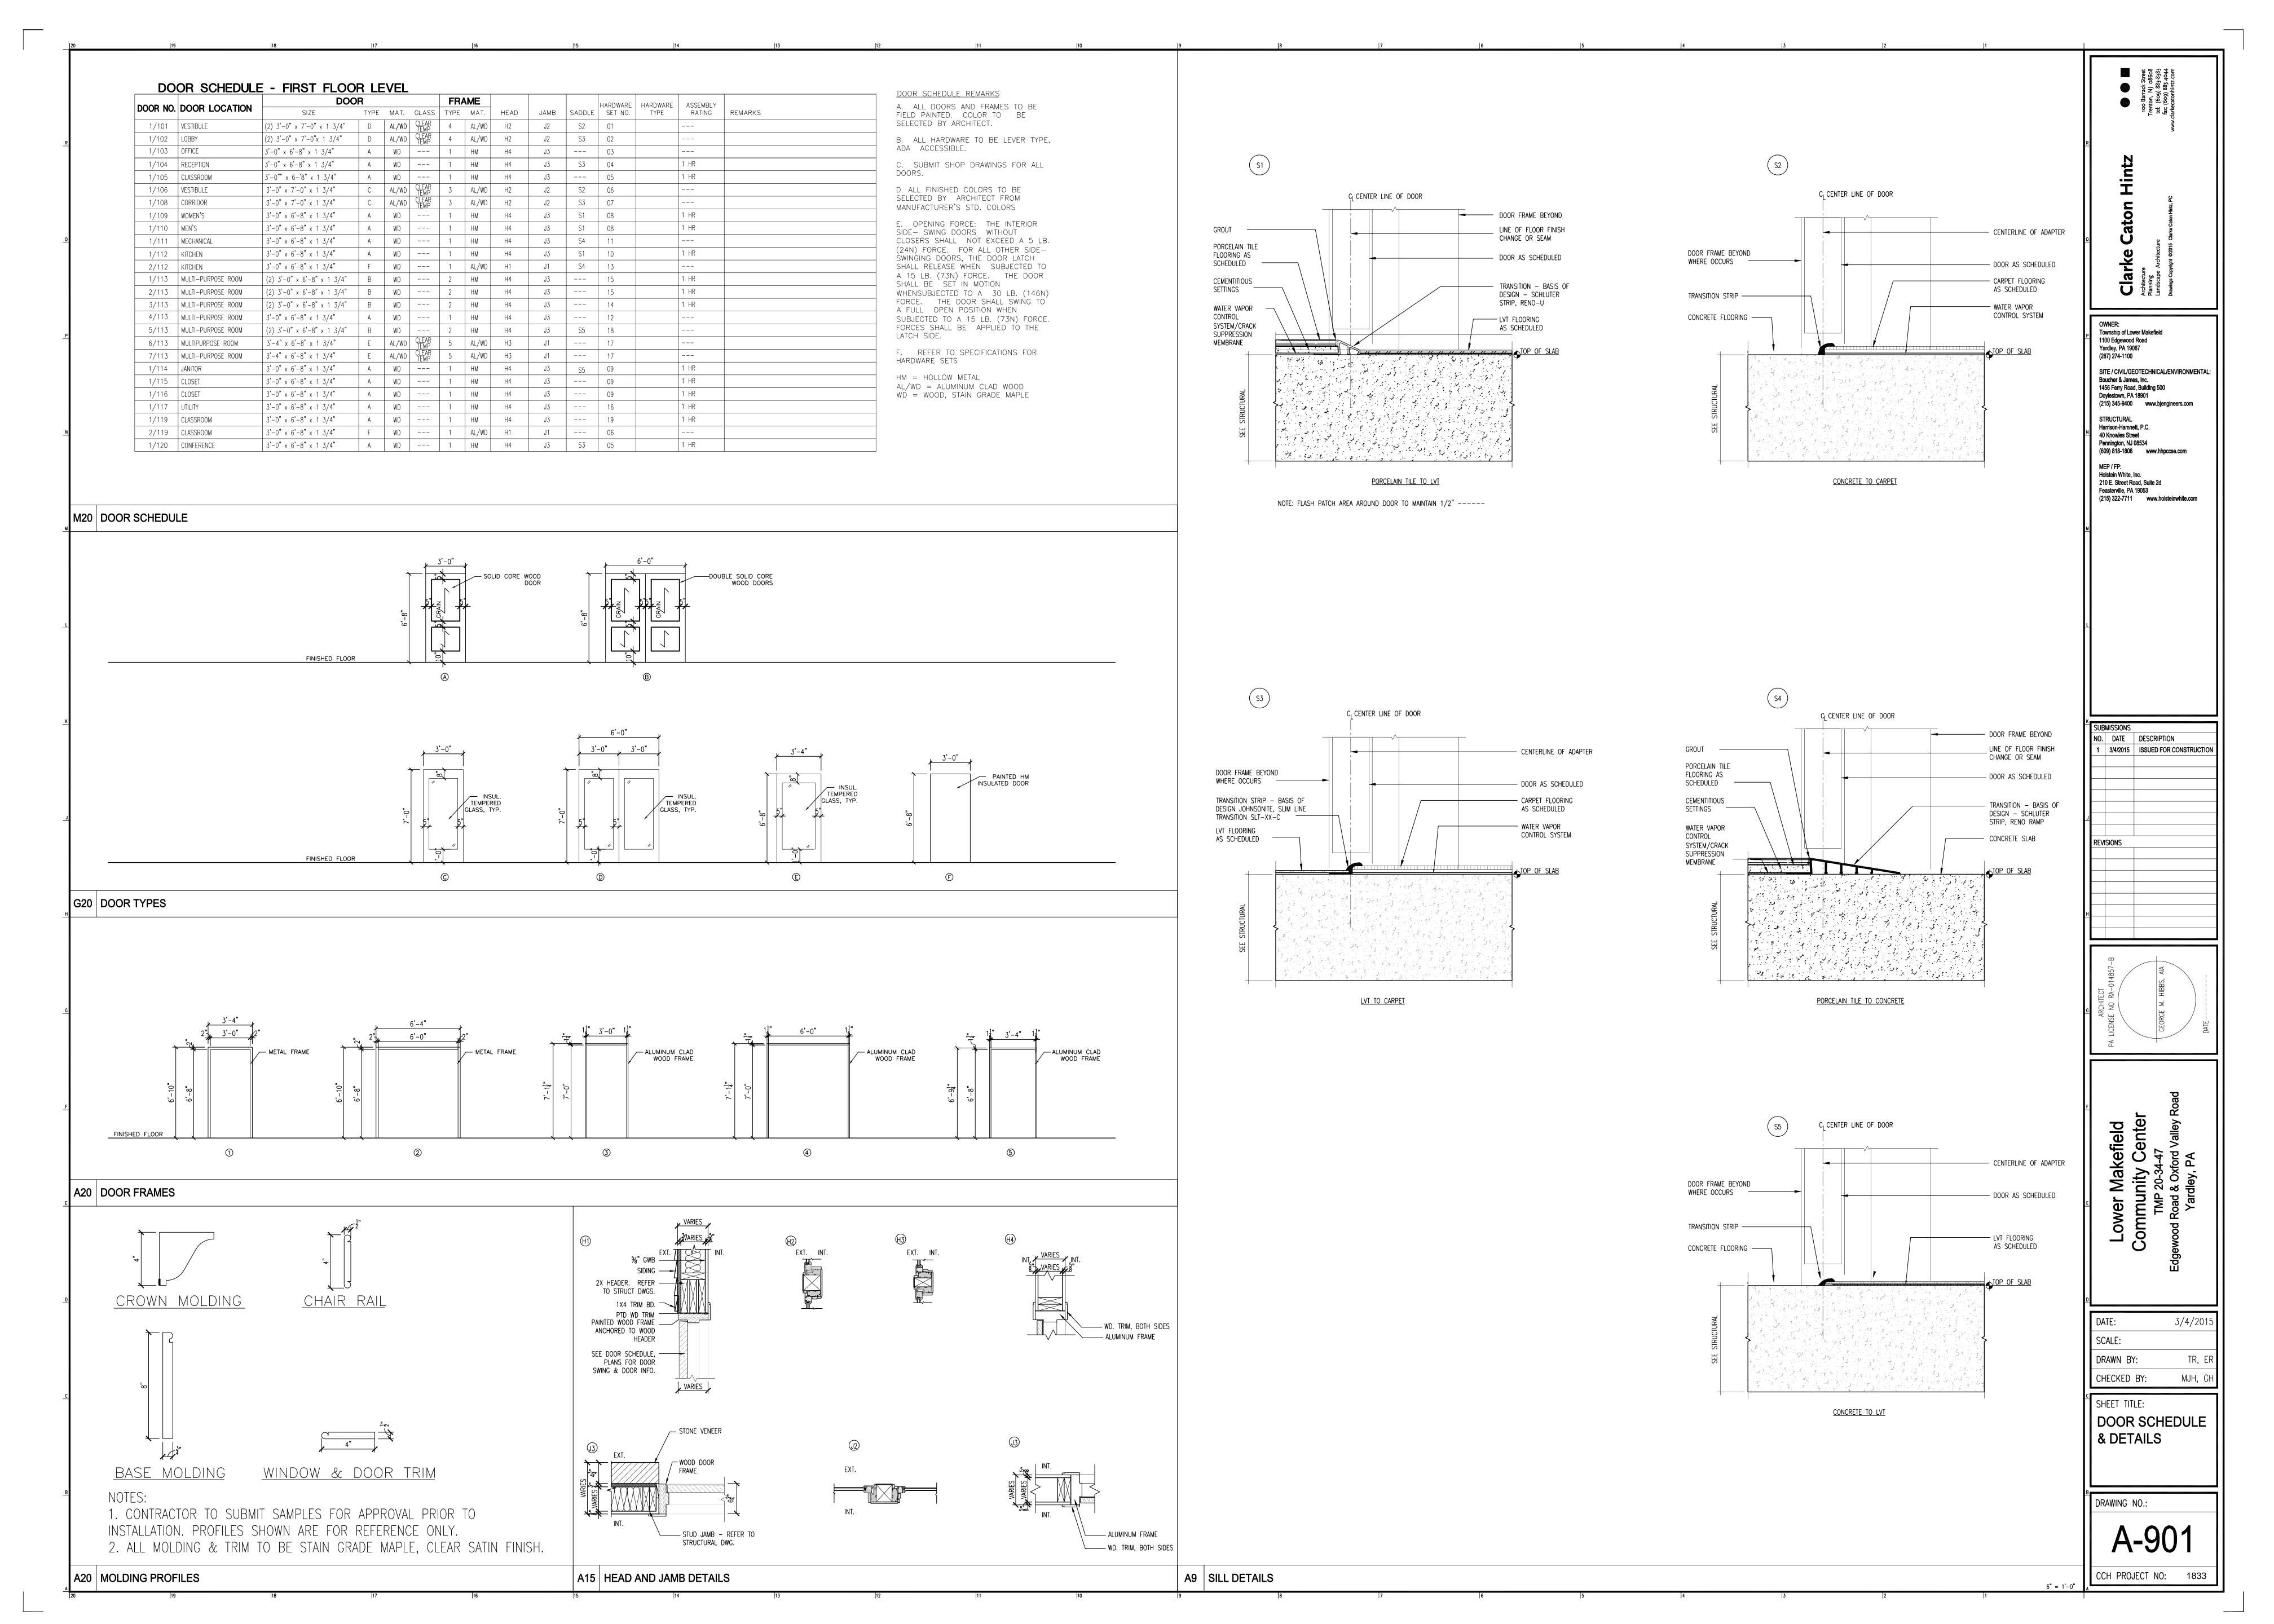

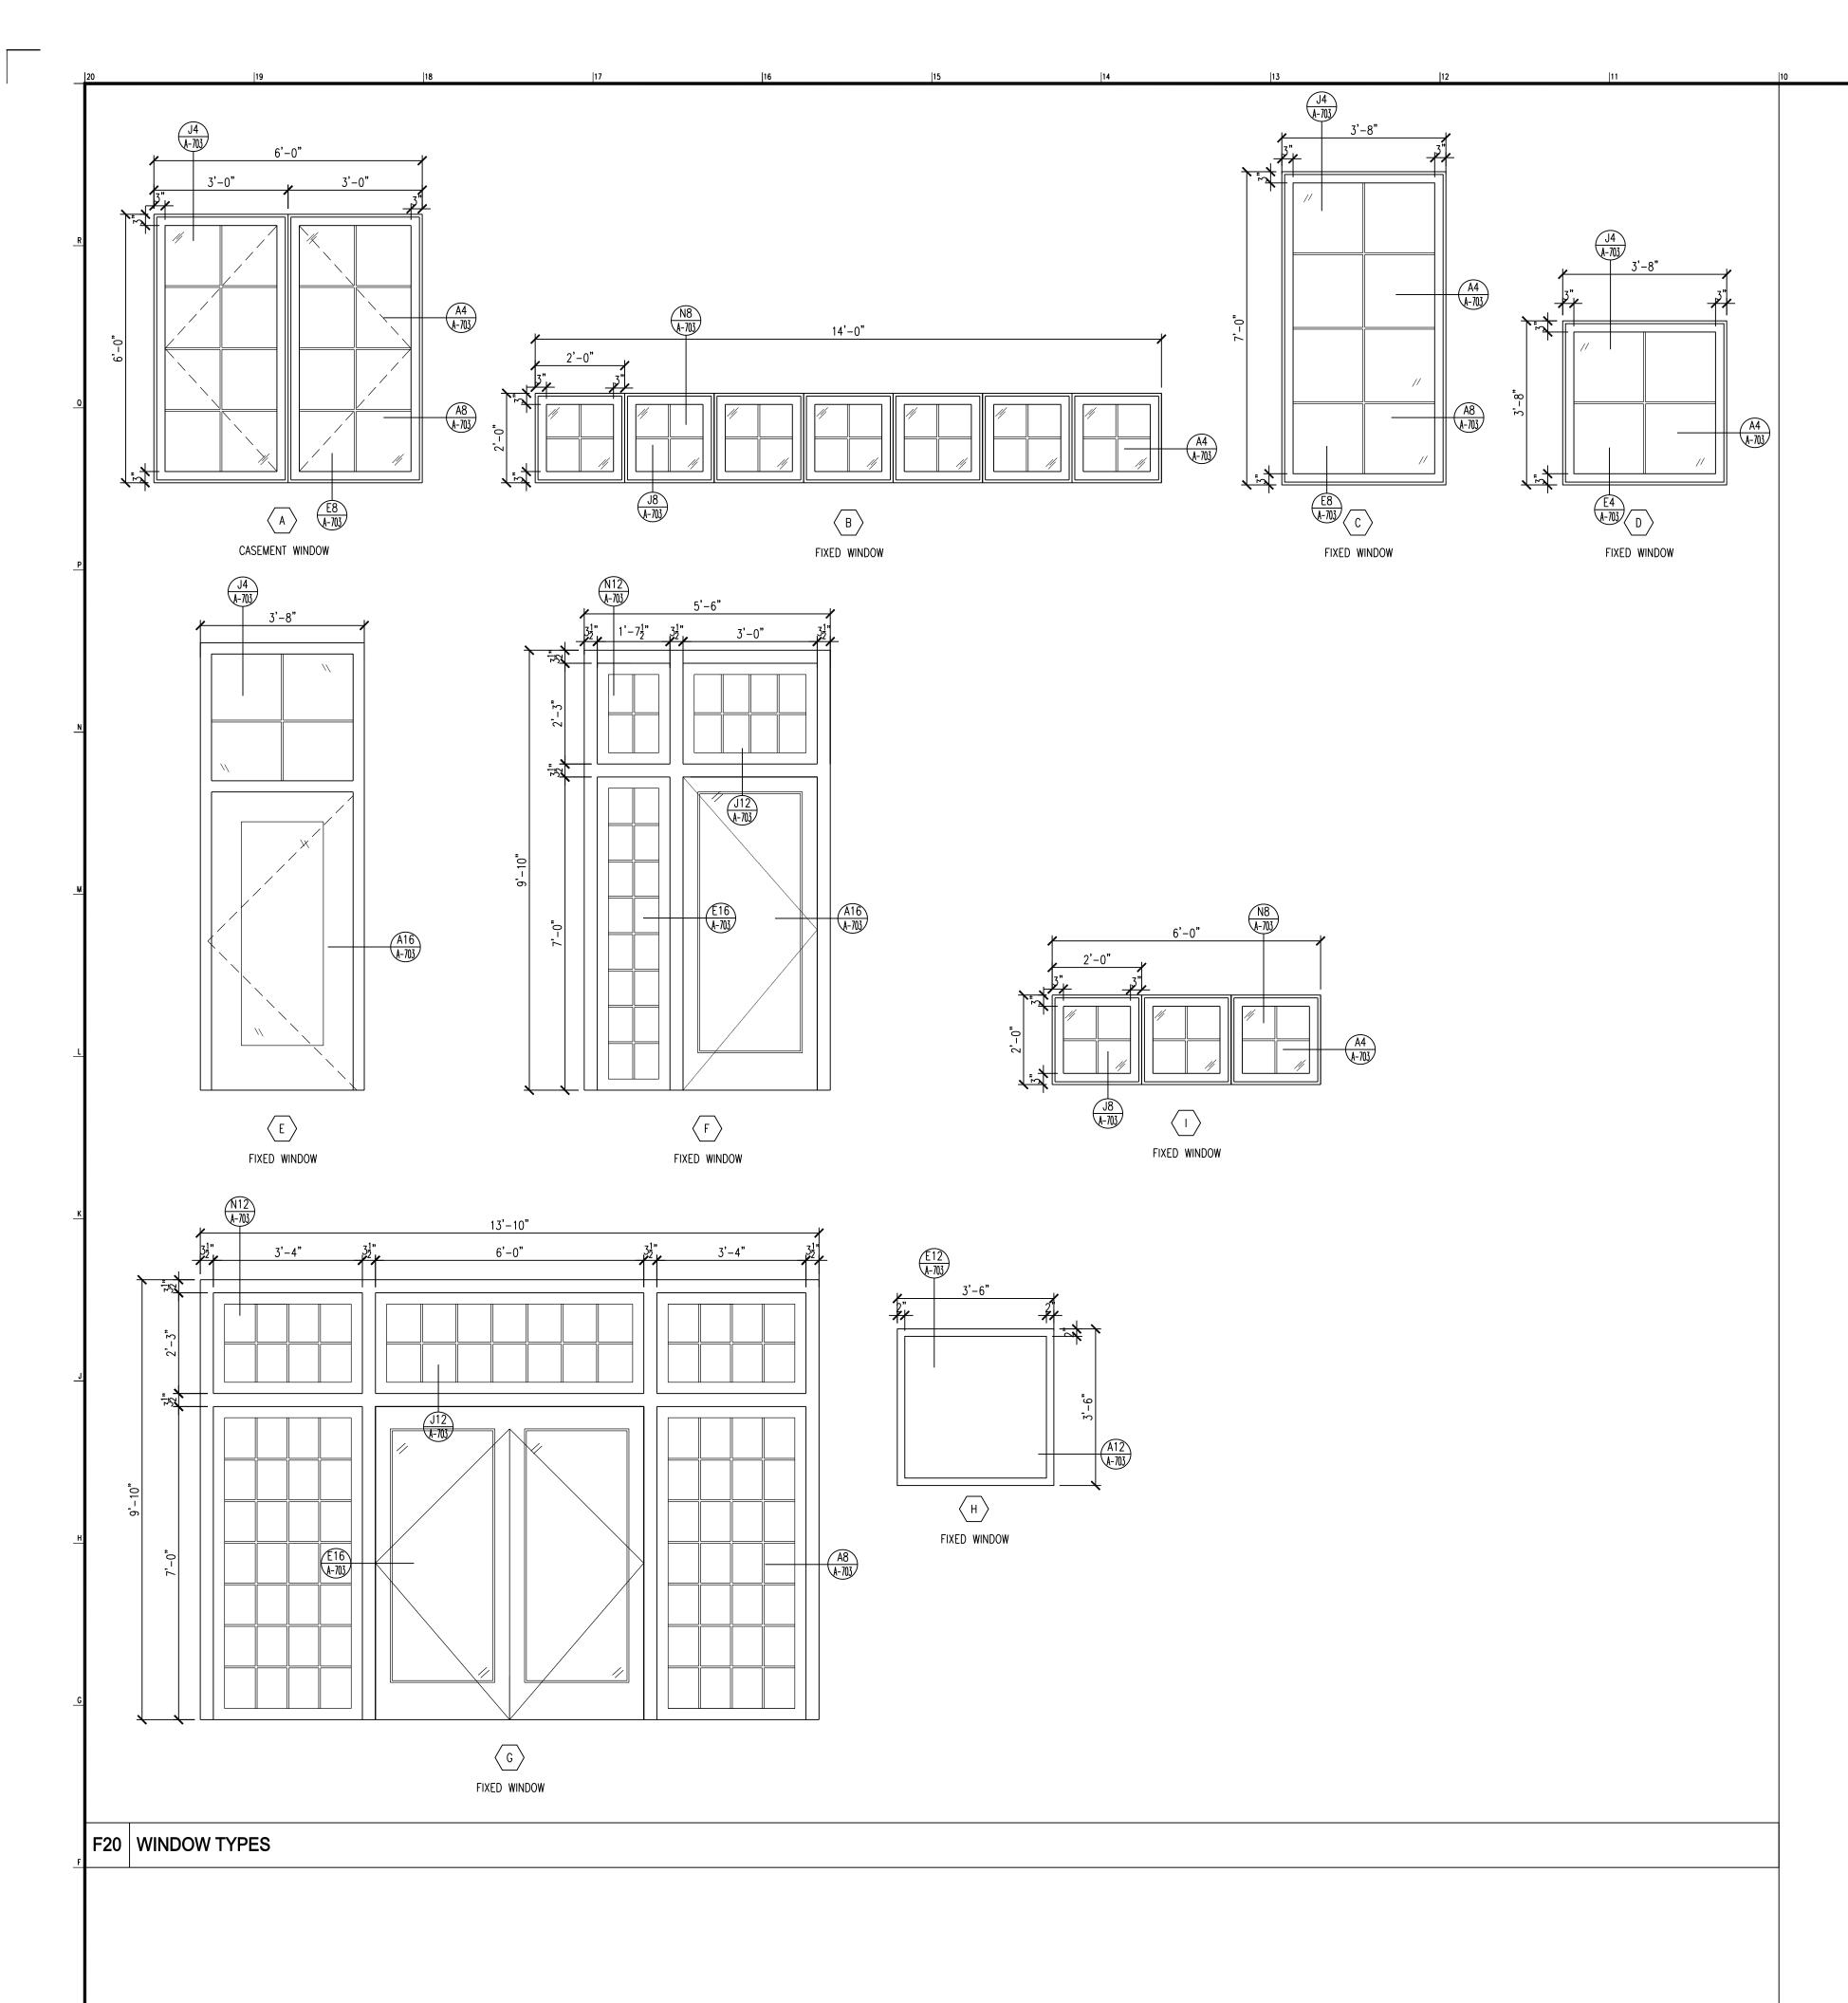

WINDOW	SCHEDULE				
WINDOW TYPE				MATERIAL	
	WINDOW LOCATIONS	UNIT SIZE	FRAME	GLASS	REMARKS
А	CLASSROOM 105 (3), OFFICE 103, CLASSROOM 120 (4), CONFERENCE 120	(2) 3'-0" W x 6'-0" H	WOOD	1" THICK CLEAR INSULATED, LOW "E"	BASIS OF DESIGN: ALUM CLD WD WINDOWS MANUF. BY ANDERSE E-SERIES
В	LOBBY	(7) 2'-0" W x 2'-0" H	WOOD	1" THICK CLEAR TEMP. INSULATED, LOW "E"	BASIS OF DESIGN: ALUM CLD WD WINDOWS MANUF. BY ANDERSEI E-SERIES
С	MULTI-PURPOSE ROOM 113 (7)	3'-8" W x 7'-0" H	WOOD	1" THICK CLEAR INSULATED, LOW "E"	BASIS OF DESIGN: ALUM CLD WD WINDOWS MANUF. BY ANDERSE E-SERIES — AUXILIARY
D	MULTI-PURPOSE ROOM 113 (14), KITCHEN	3'-8" W x 3'-8" H	WOOD	1" THICK CLEAR TEMP. INSULATED, LOW "E"	BASIS OF DESIGN: ALUM CLD WD WINDOWS MANUF. BY ANDERSE E-SERIES
E	MULTI-PURPOSE ROOM 113 (2)	X'-X" W x X'-X" H	WOOD	1" THICK CLEAR TEMP. INSULATED, LOW "E"	BASIS OF DESIGN: ALUM CLD WD WINDOWS MANUF. BY ANDERSE E-SERIES
F	VESTIBULE 106, CORRIDOR 108	X'-X" W x X'-X" H	WOOD	1" THICK CLEAR INSULATED, LOW "E"	BASIS OF DESIGN: ALUM CLD WD WINDOWS MANUF. BY ANDERSE E-SERIES
G	VESTIBULE 101, LOBBY 102	X'-X" W x X'-X" H	WOOD	1" THICK CLEAR INSULATED, LOW "E"	BASIS OF DESIGN: ALUM CLD WD WINDOWS MANUF. BY ANDERSE E-SERIES
Н	VESTIBULE 101 (2), LOBBY 102 (2)	3'-6" W x 3'-6" H	2" HOLLOW METAL	1/2" THCIK CLEAR INSULATED, LOW "E"	3/4 HOUR FIRE PROTECTED SAFETY GLAZING IN ACCORDANCE W/ NFPA 257 OR UL9

NOTE:
ALL GLAZING TO BE ANDERSEN 1" INSULATED LOW E4 GLAZING W/ GRILLES BTWN. GLASS.
NFRC # EWD-N-84-00169-00006

Clarke Caton Hint, PC

Architecture
Planning
Landscape Architecture

Clarke Caton Hint, PC

Architecture

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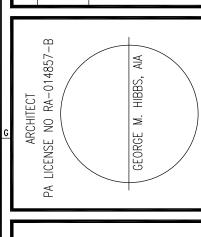
MEP / FP:
Holstein White, Inc.
210 E. Street Road, Suite 2d
Feasterville, PA 19053
(215) 322-7711 www.holsteinwhite.com

SUBMISSIONS
NO. DATE DESCRIPTION

1 3/4/2015 ISSUED FOR CONSTRUCTION

REVISIONS

H



Lower Makefield
Community Center
TMP 20-34-47
Edgewood Road & Oxford Valley Road

DATE: 3/4/201
SCALE:

DRAWN BY: TR, E
CHECKED BY: MJH, G


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WINDOW
SCHEDULE &


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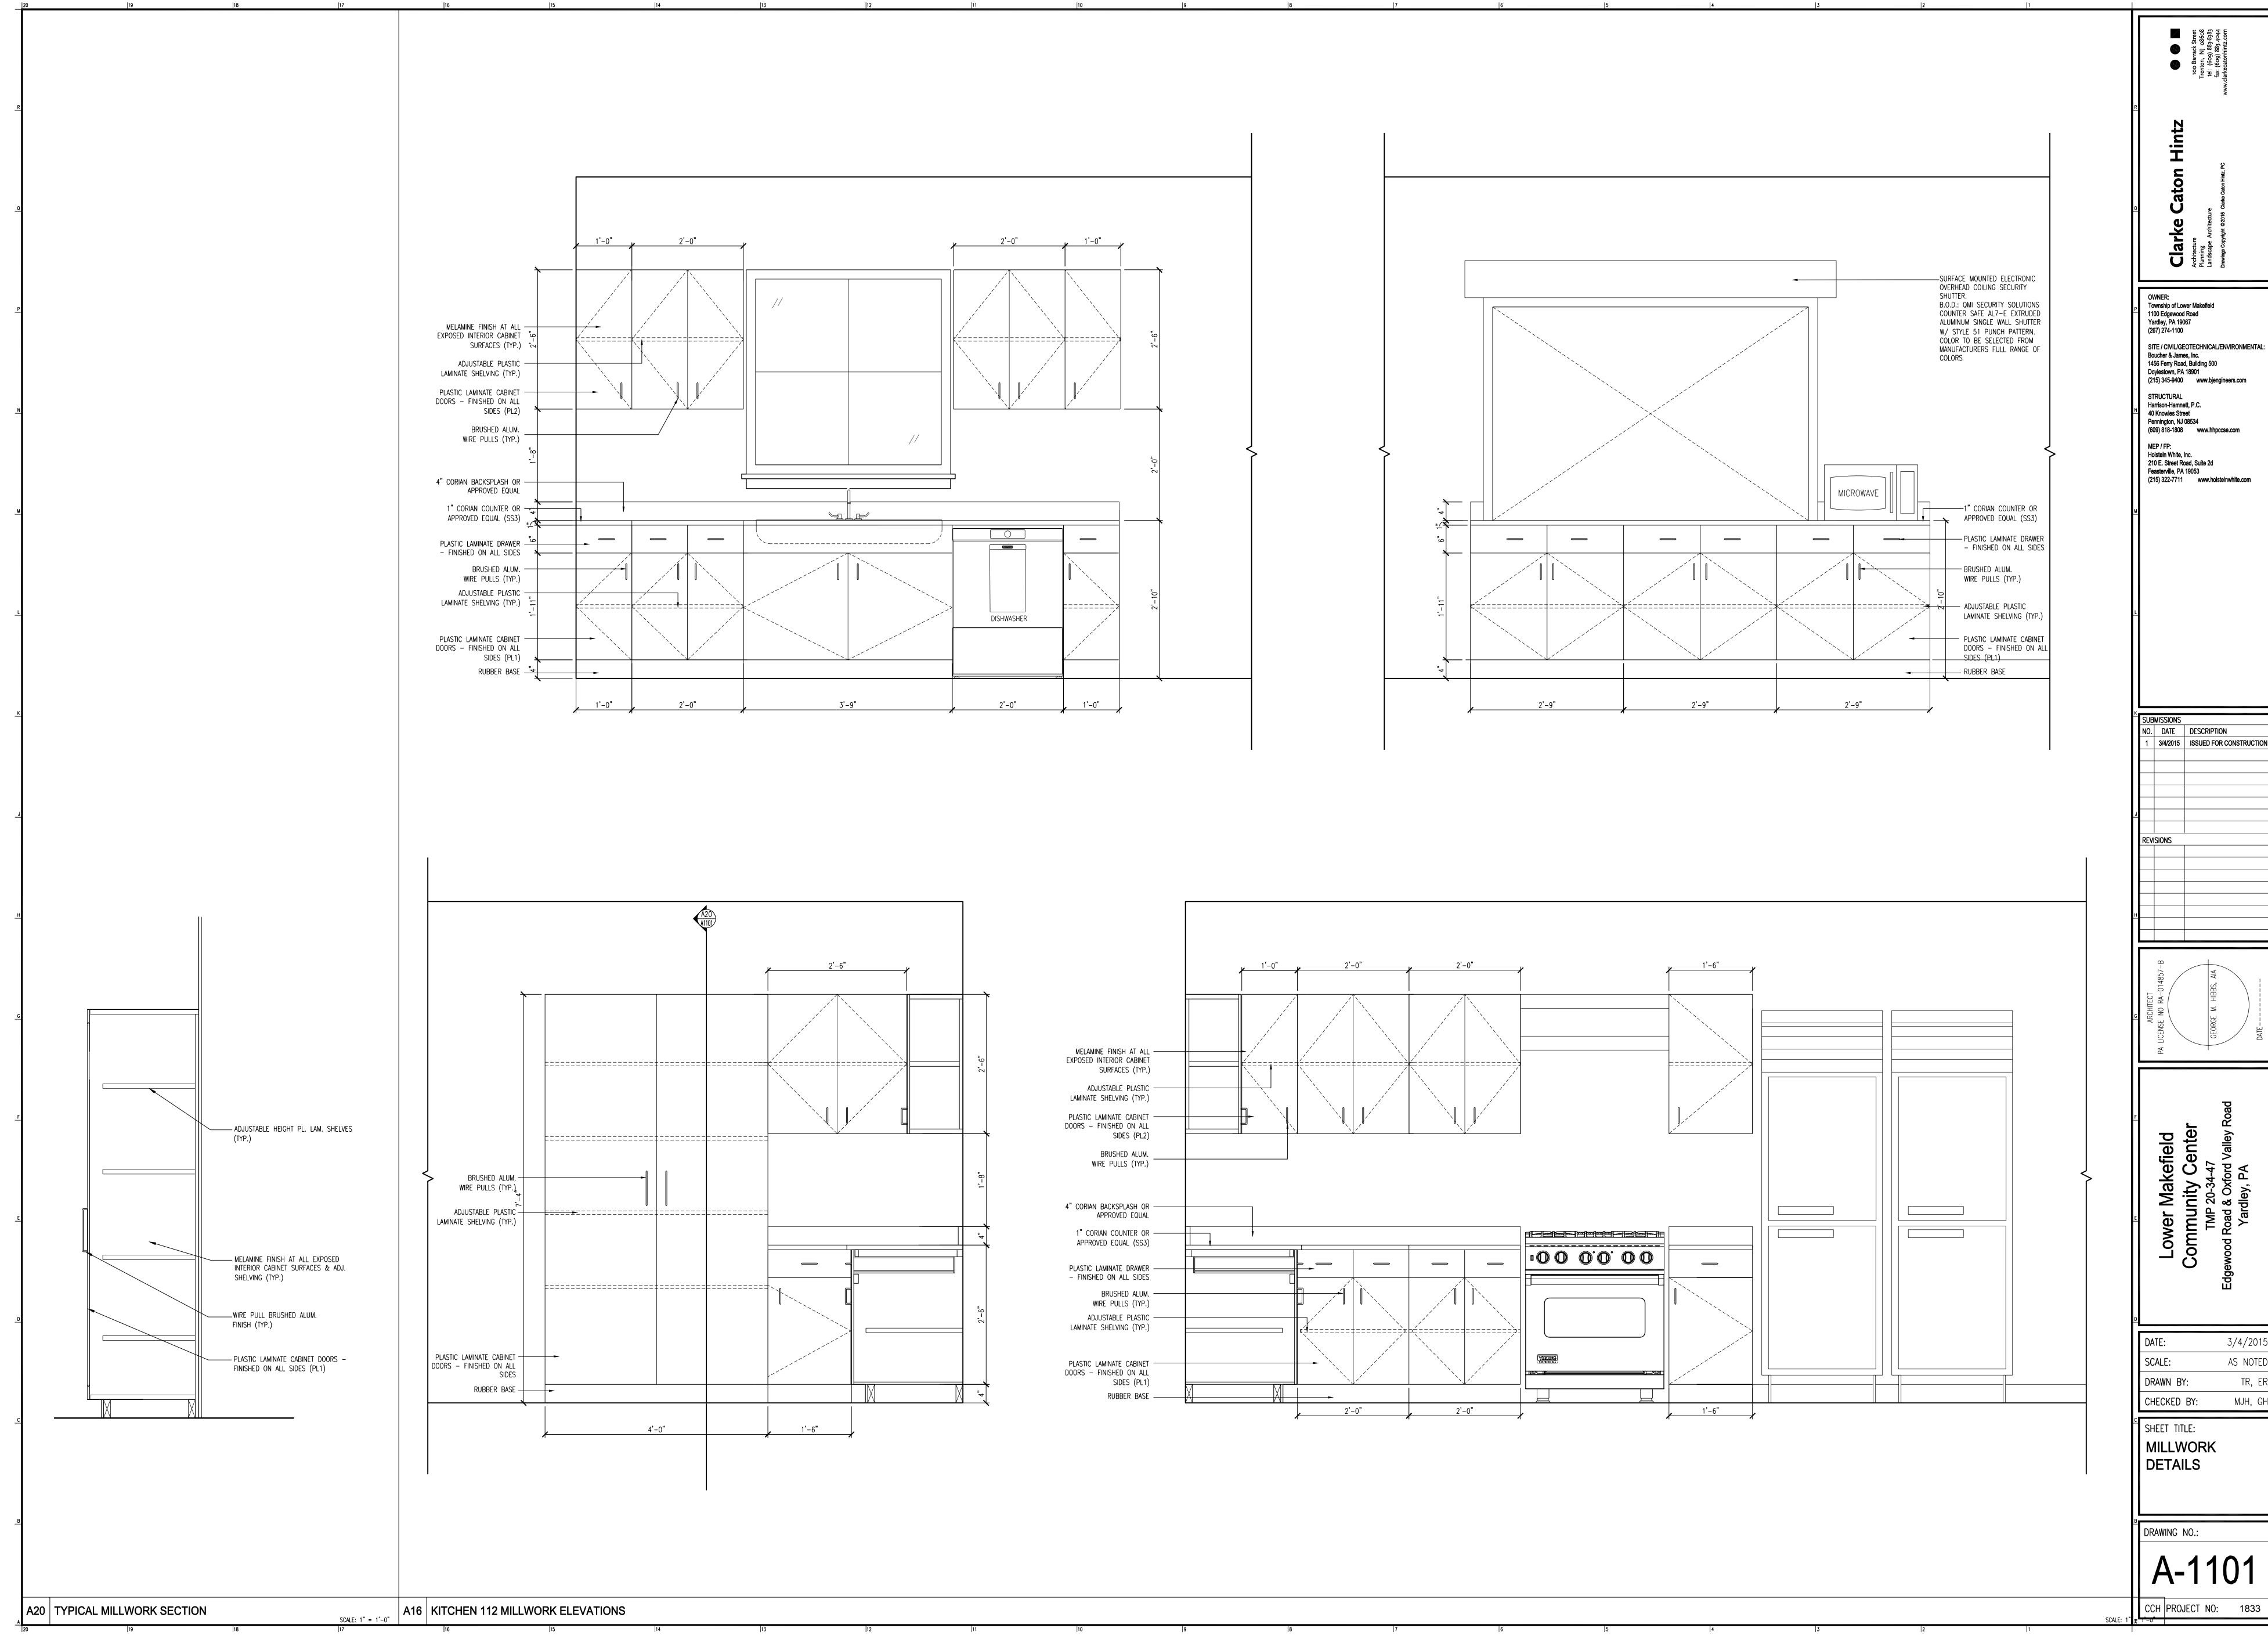
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CCH PROJECT NO: 1833


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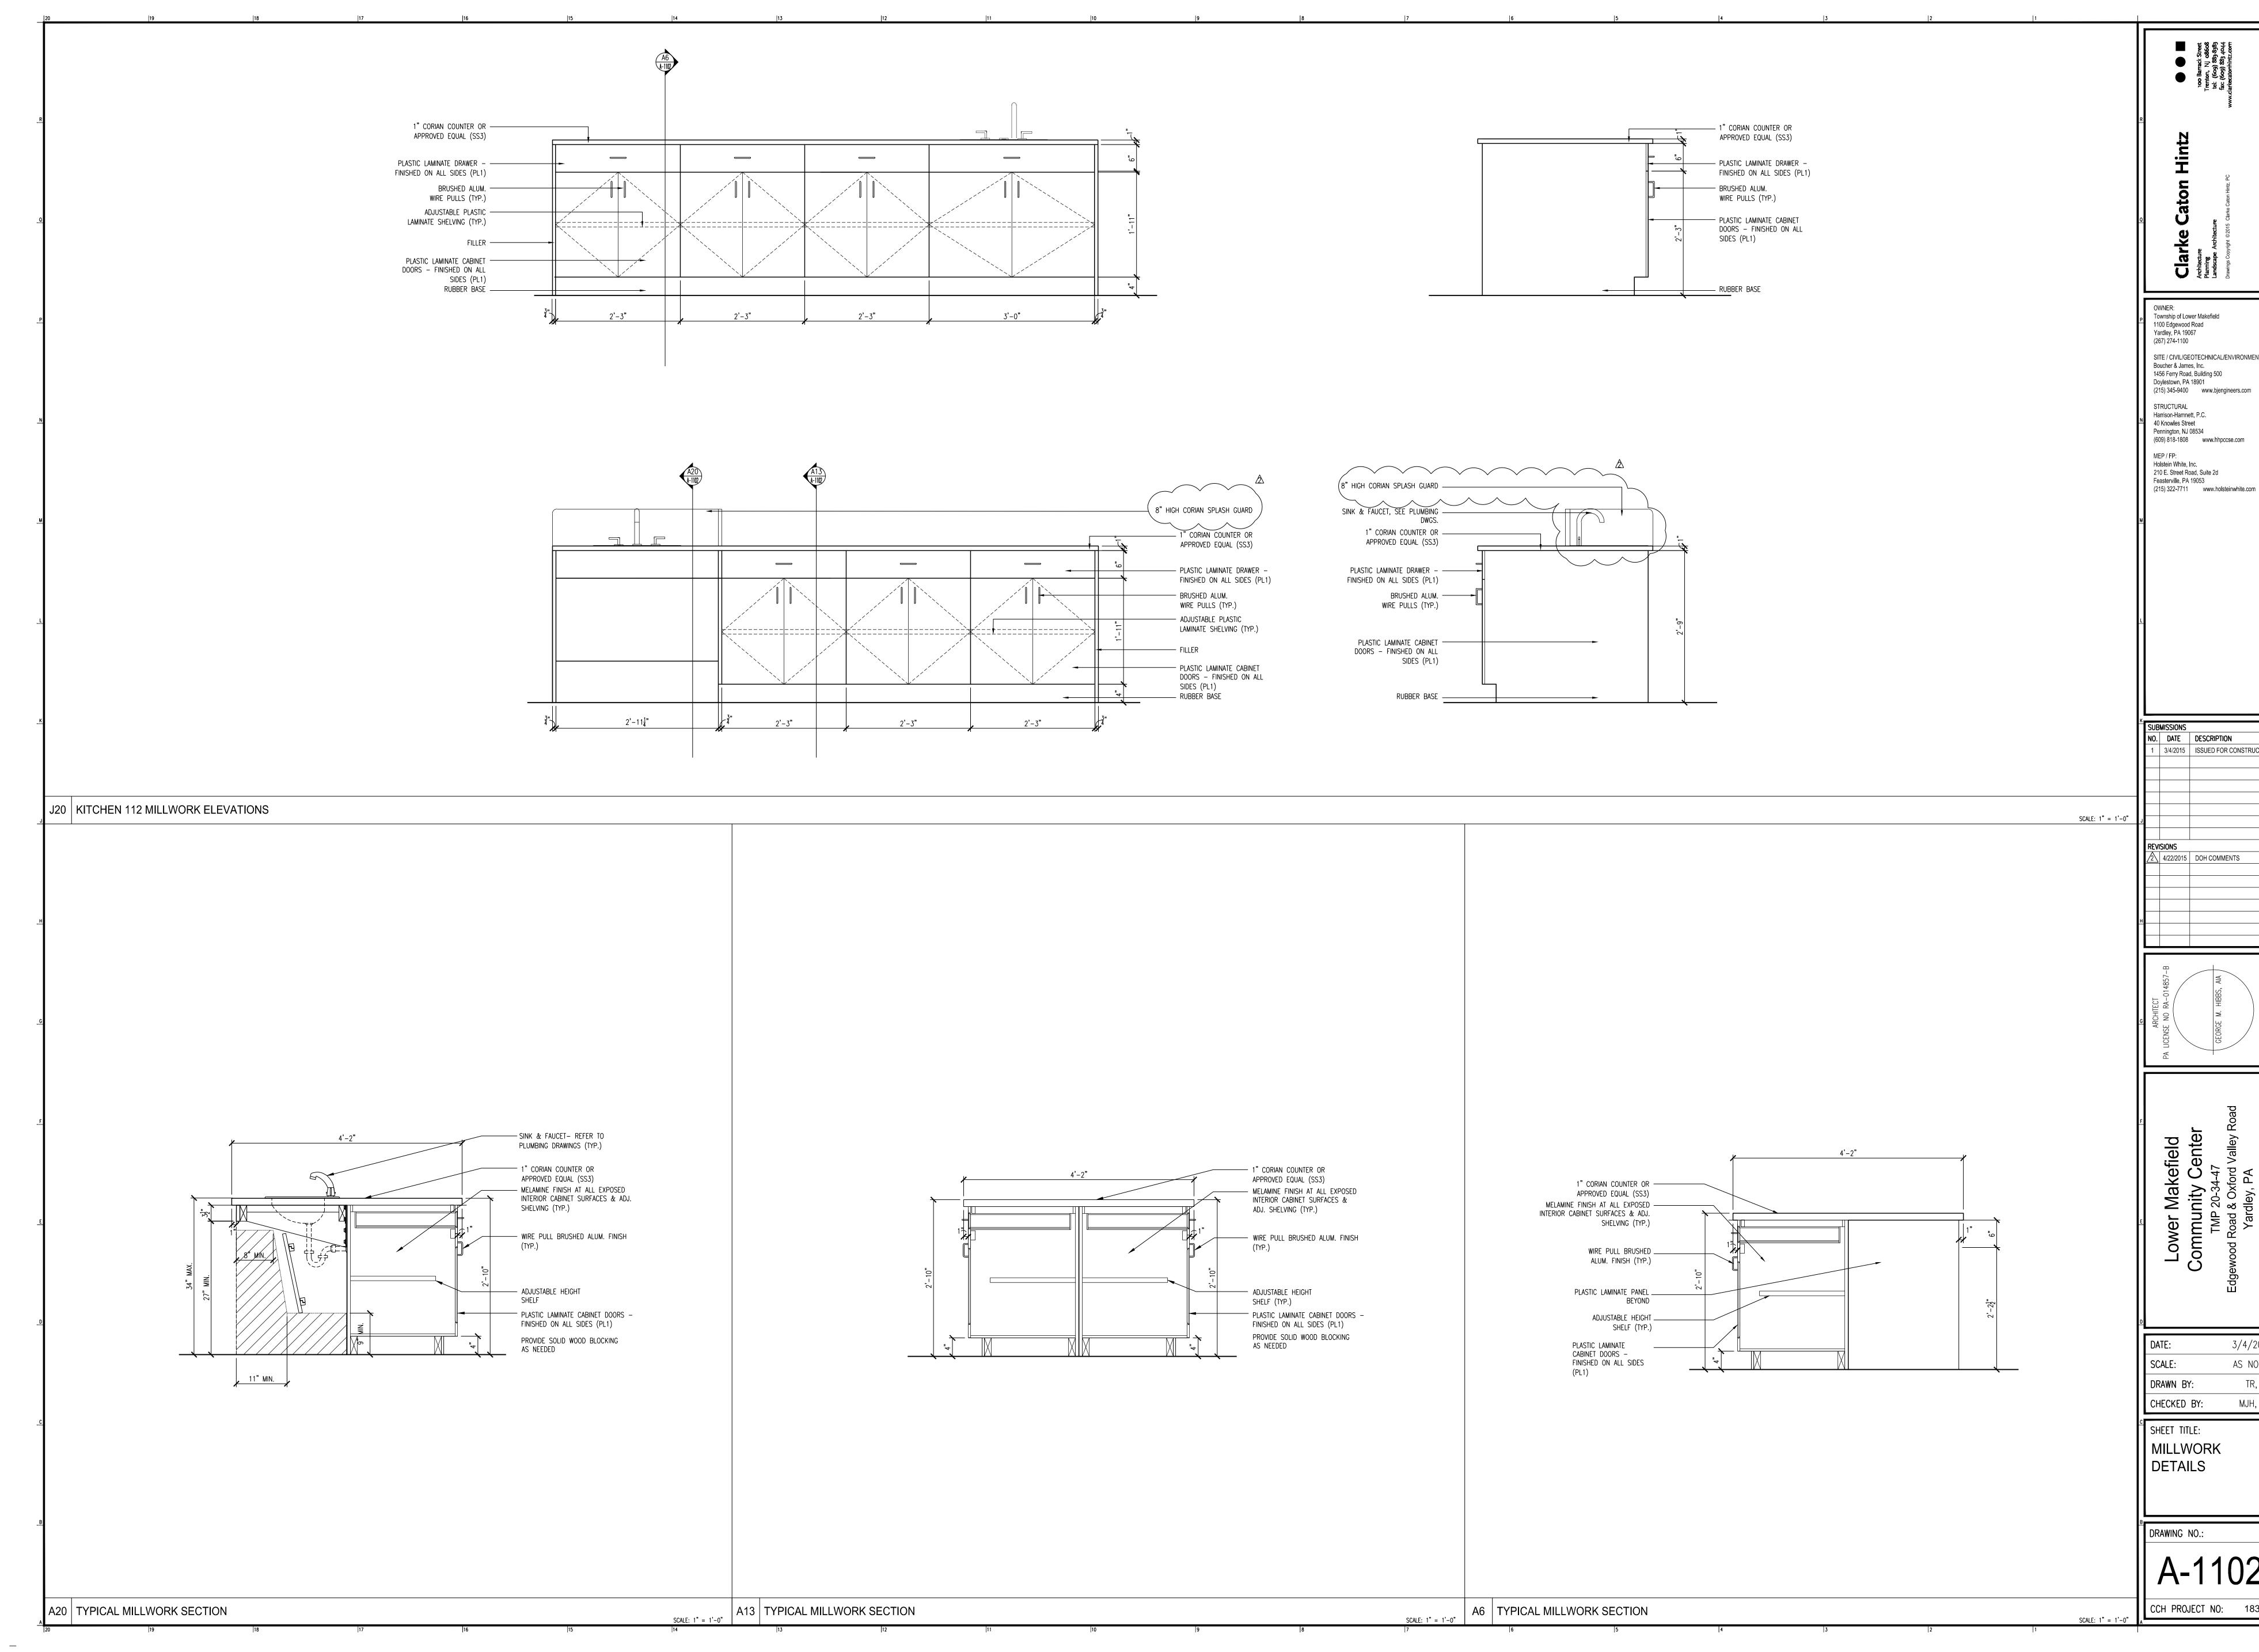




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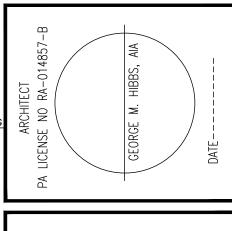
DATE:	3/4/2015
SCALE:	AS NOTED
DRAWN BY:	TR, ER
CHECKED BY:	MJH, GH

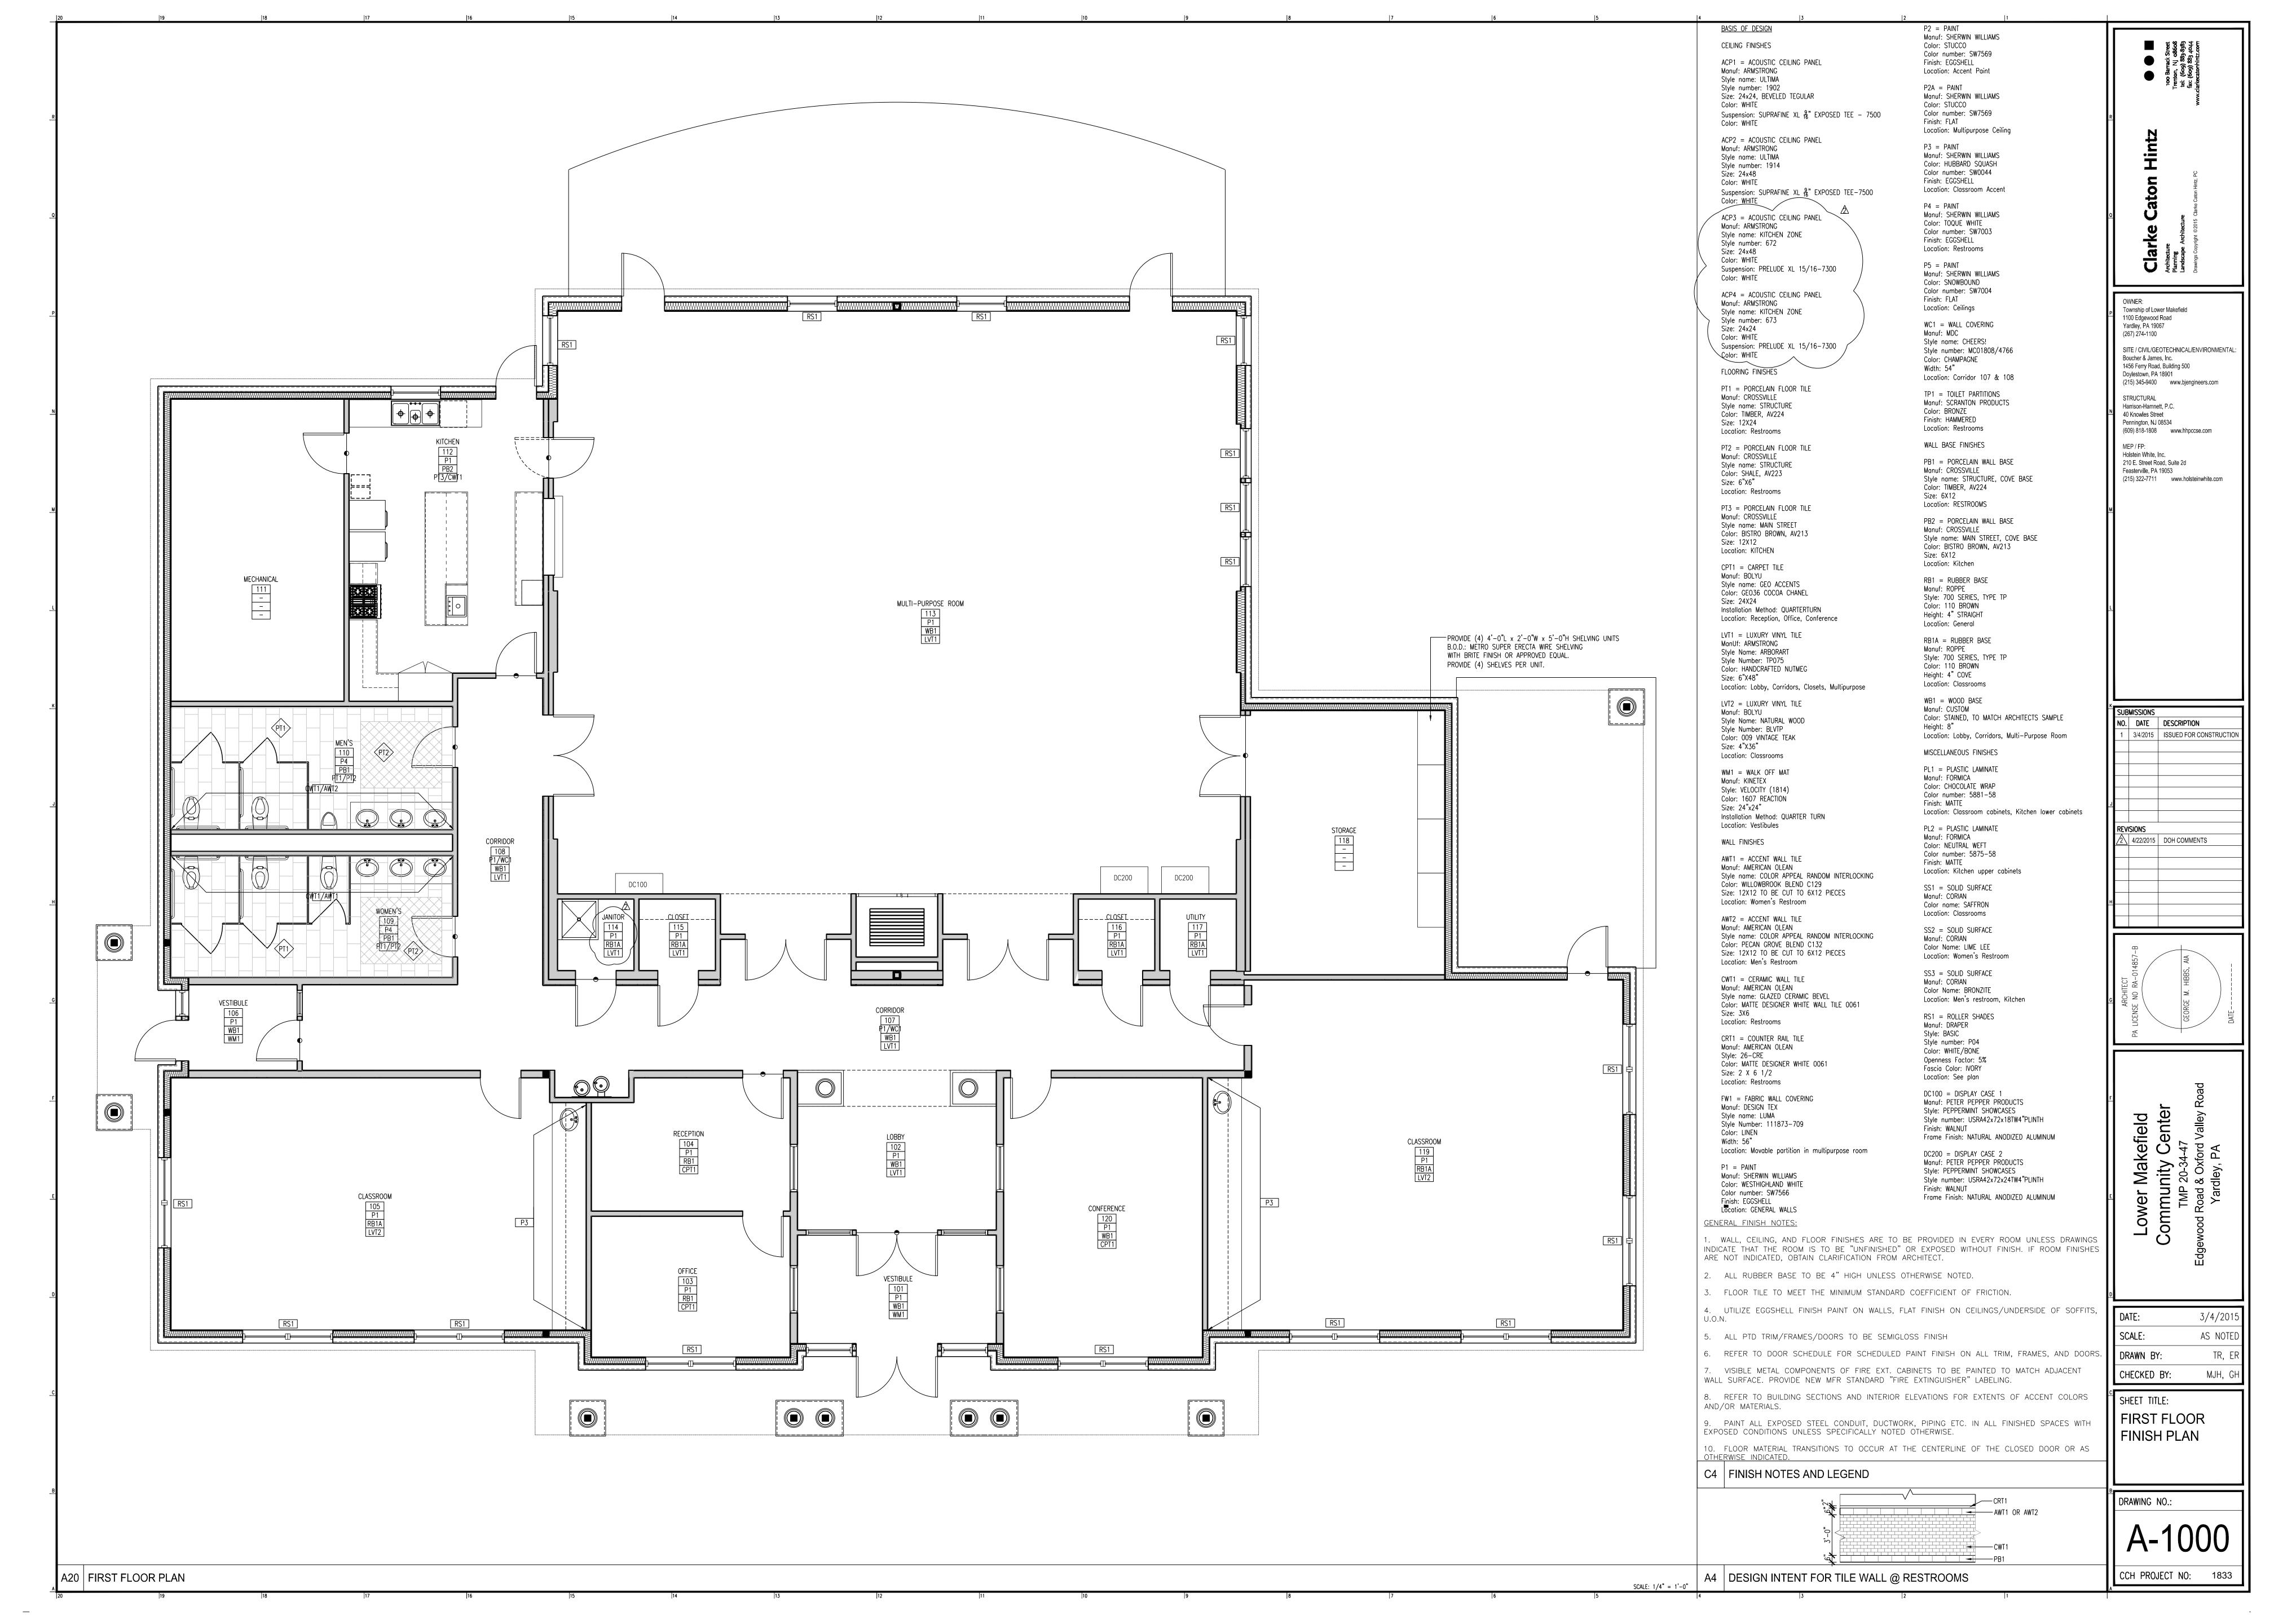

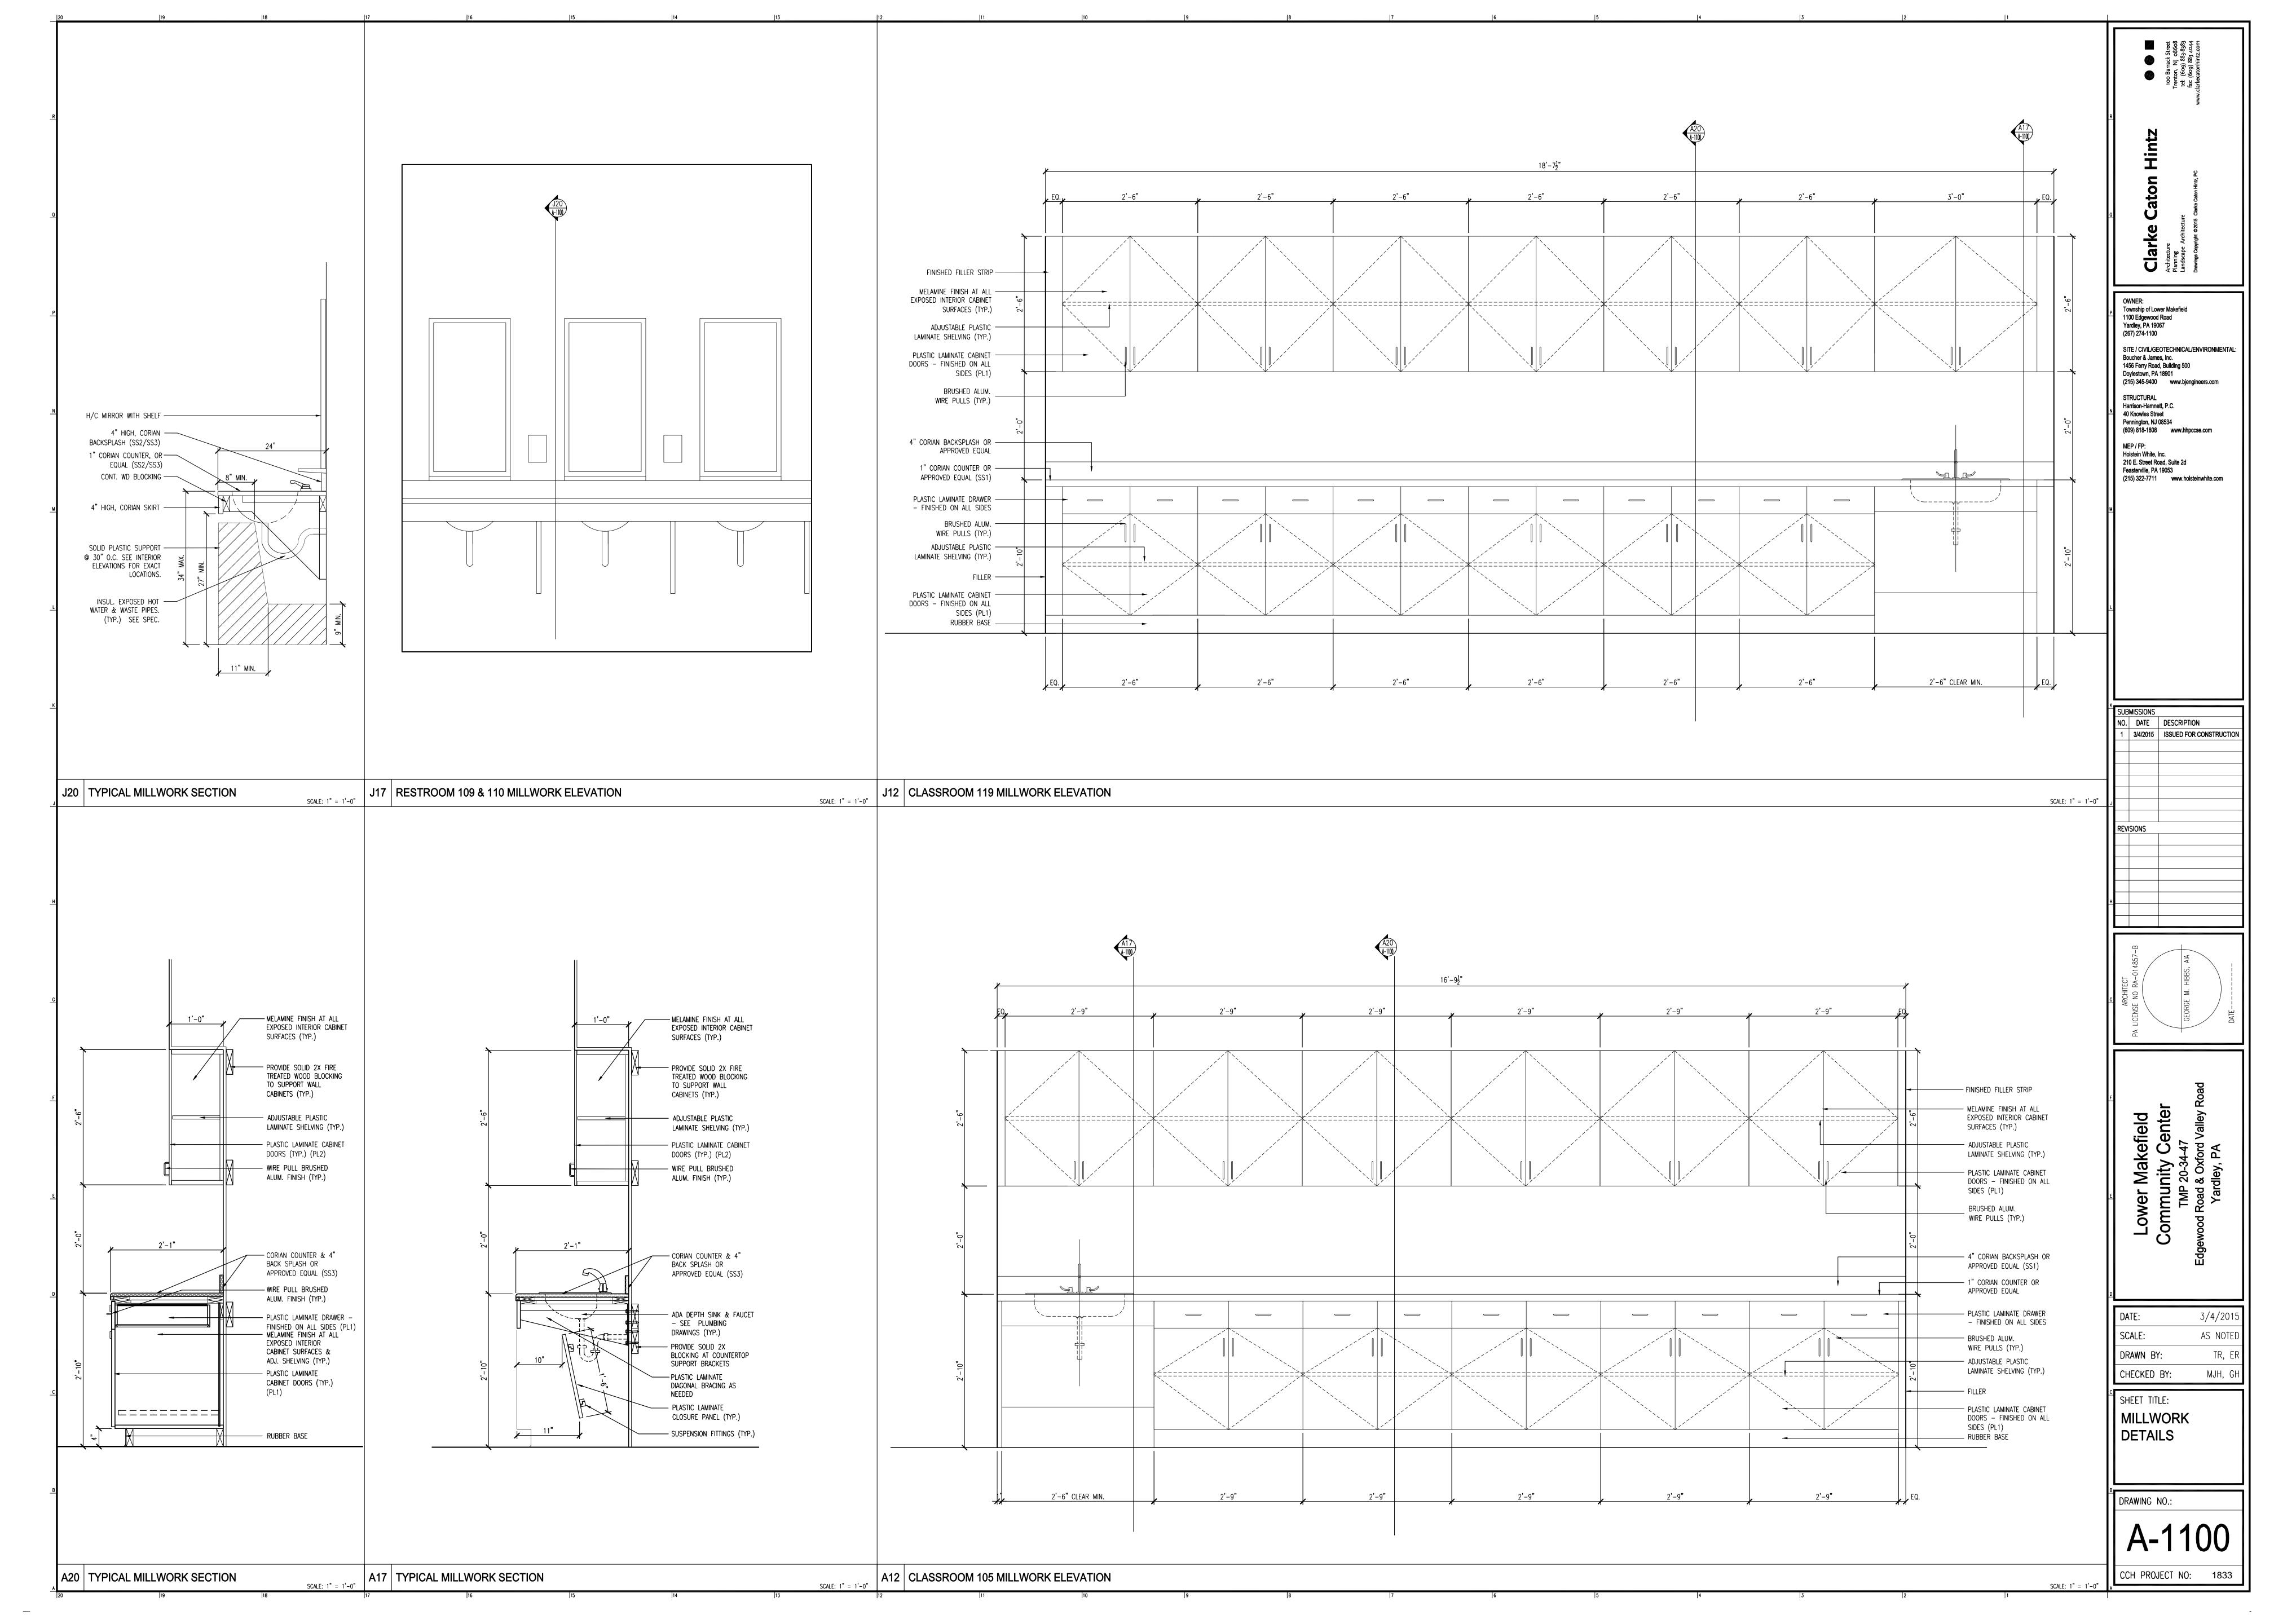
SITE / CIVIL/GEOTECHNICAL/ENVIRONMENTAL: (215) 345-9400 www.bjengineers.com

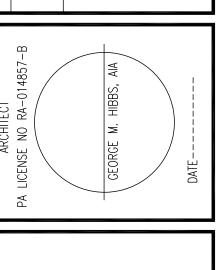
Pennington, NJ 08534 (609) 818-1808 www.hhpccse.com

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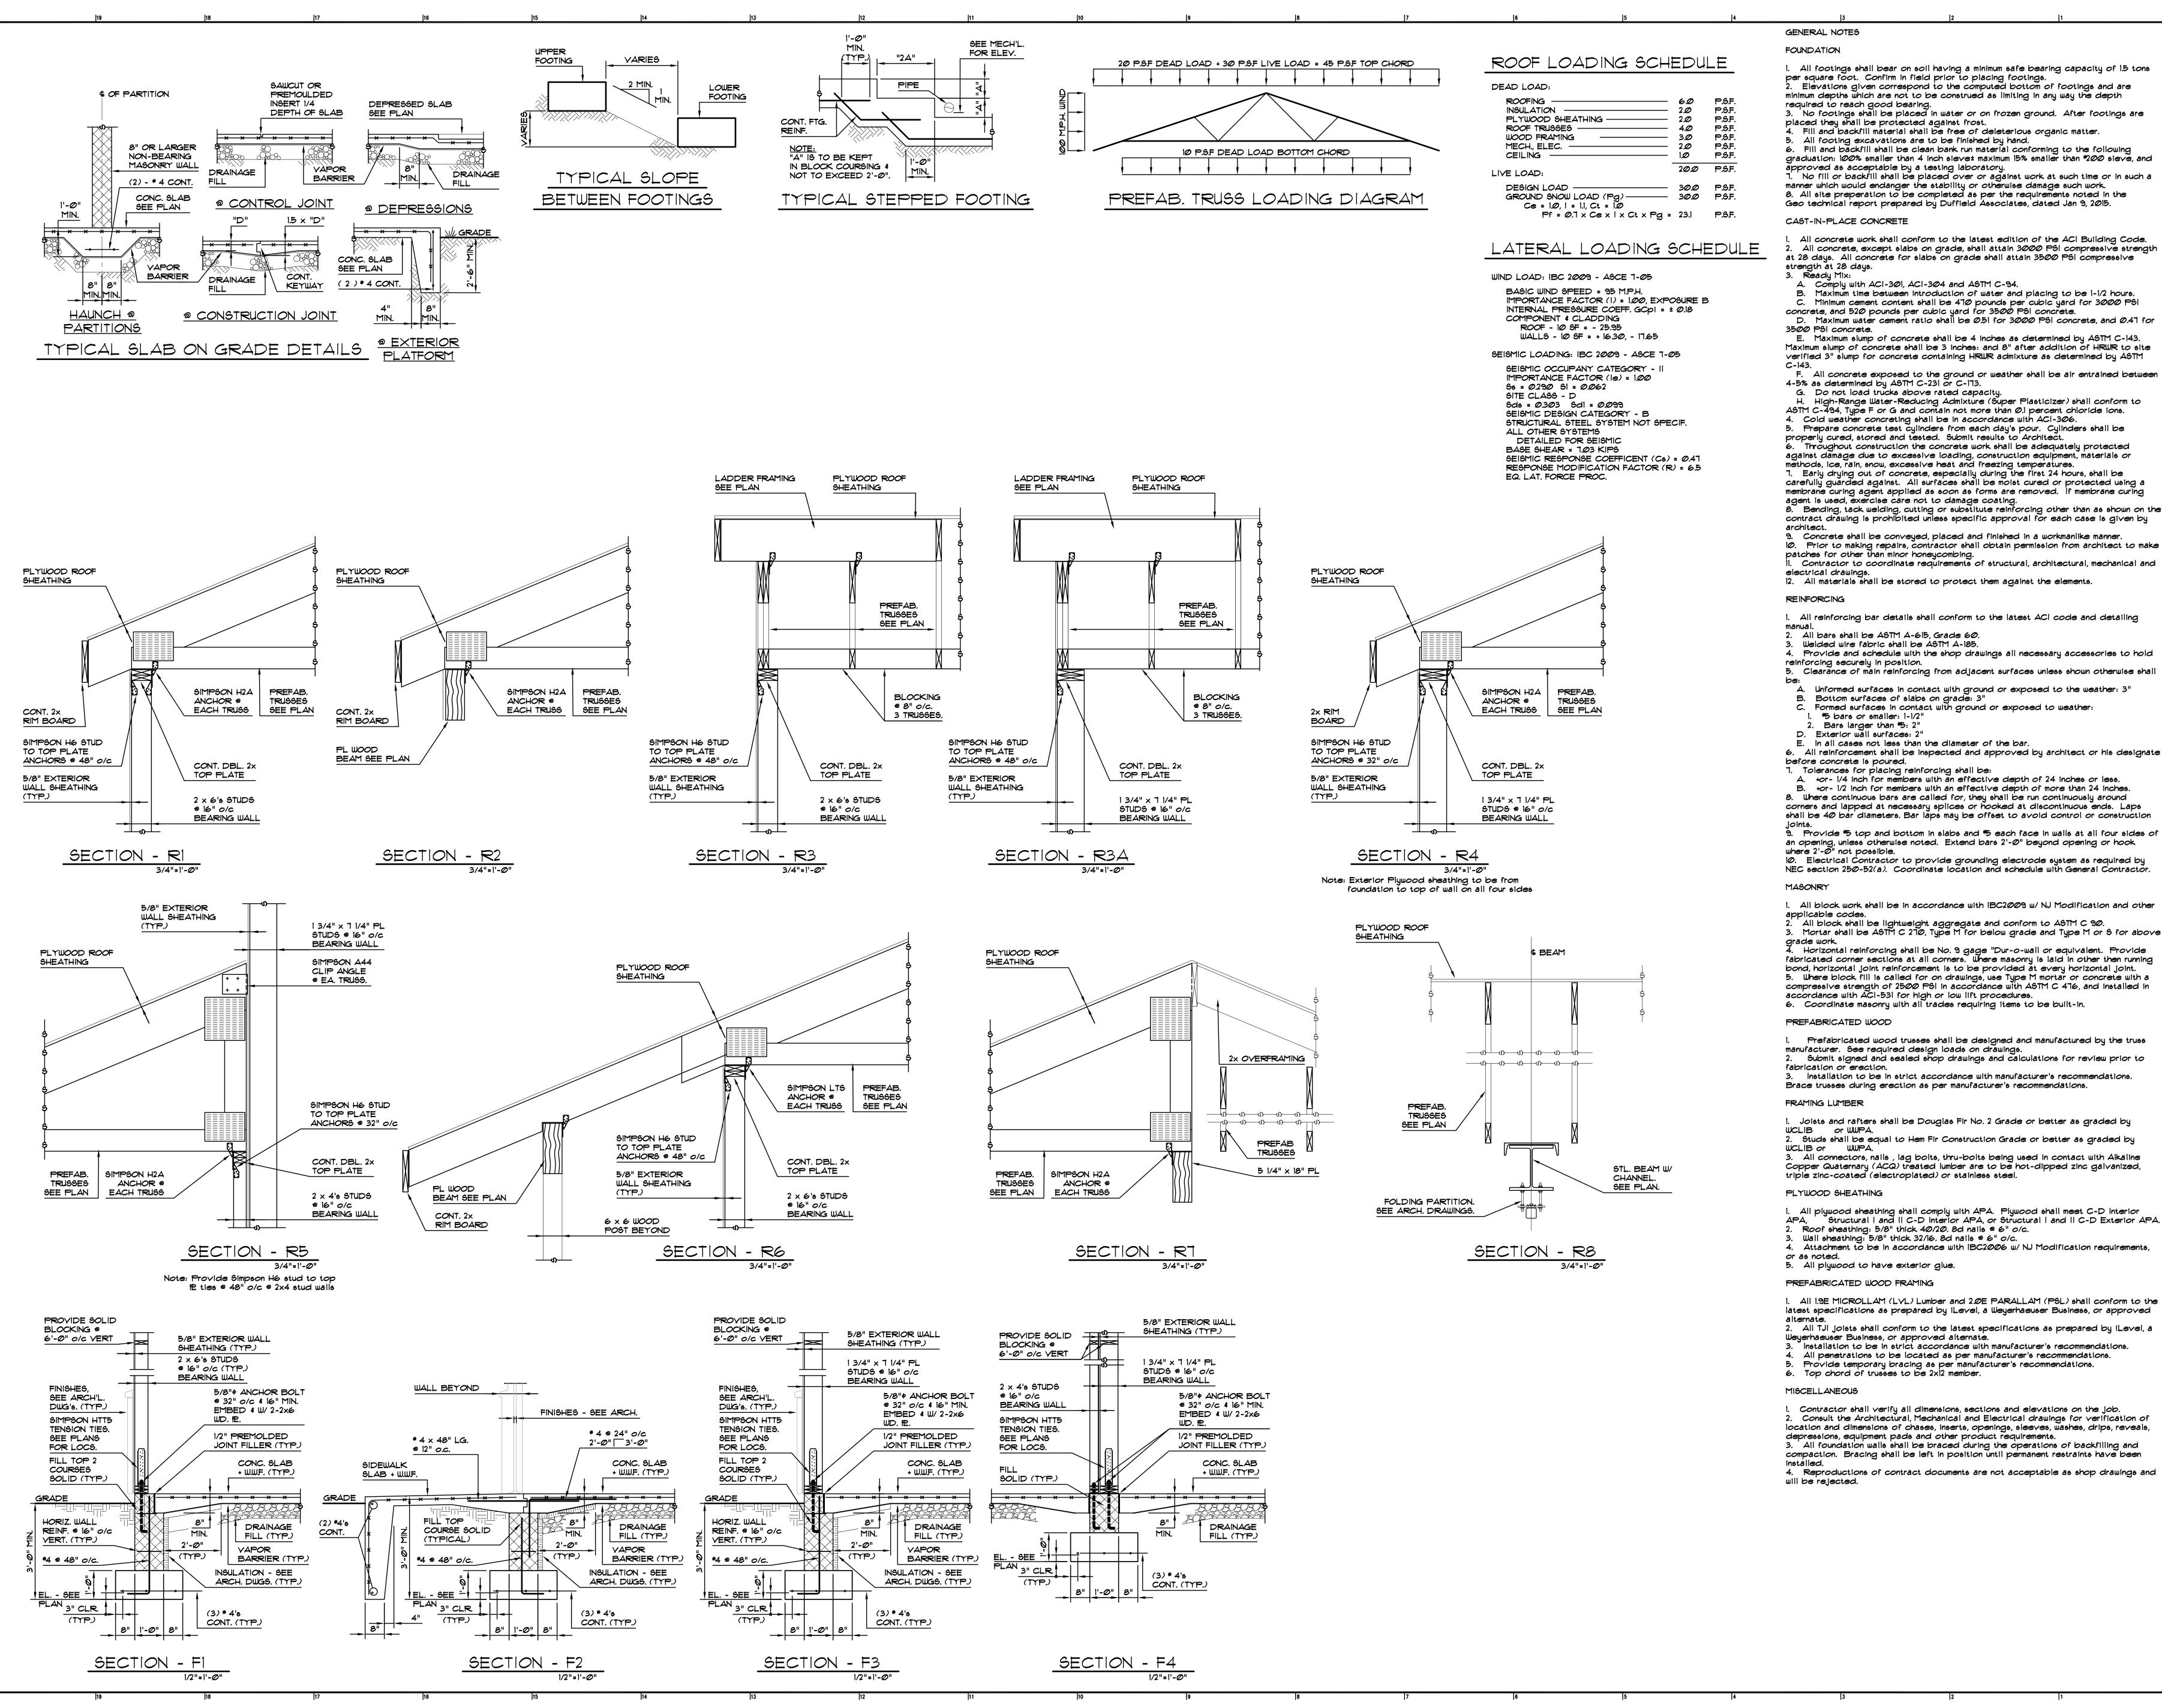


DATE:	3/4/2015
SCALE:	AS NOTED
DRAWN BY:	TR, ER
CHECKED BY:	MJH, GH



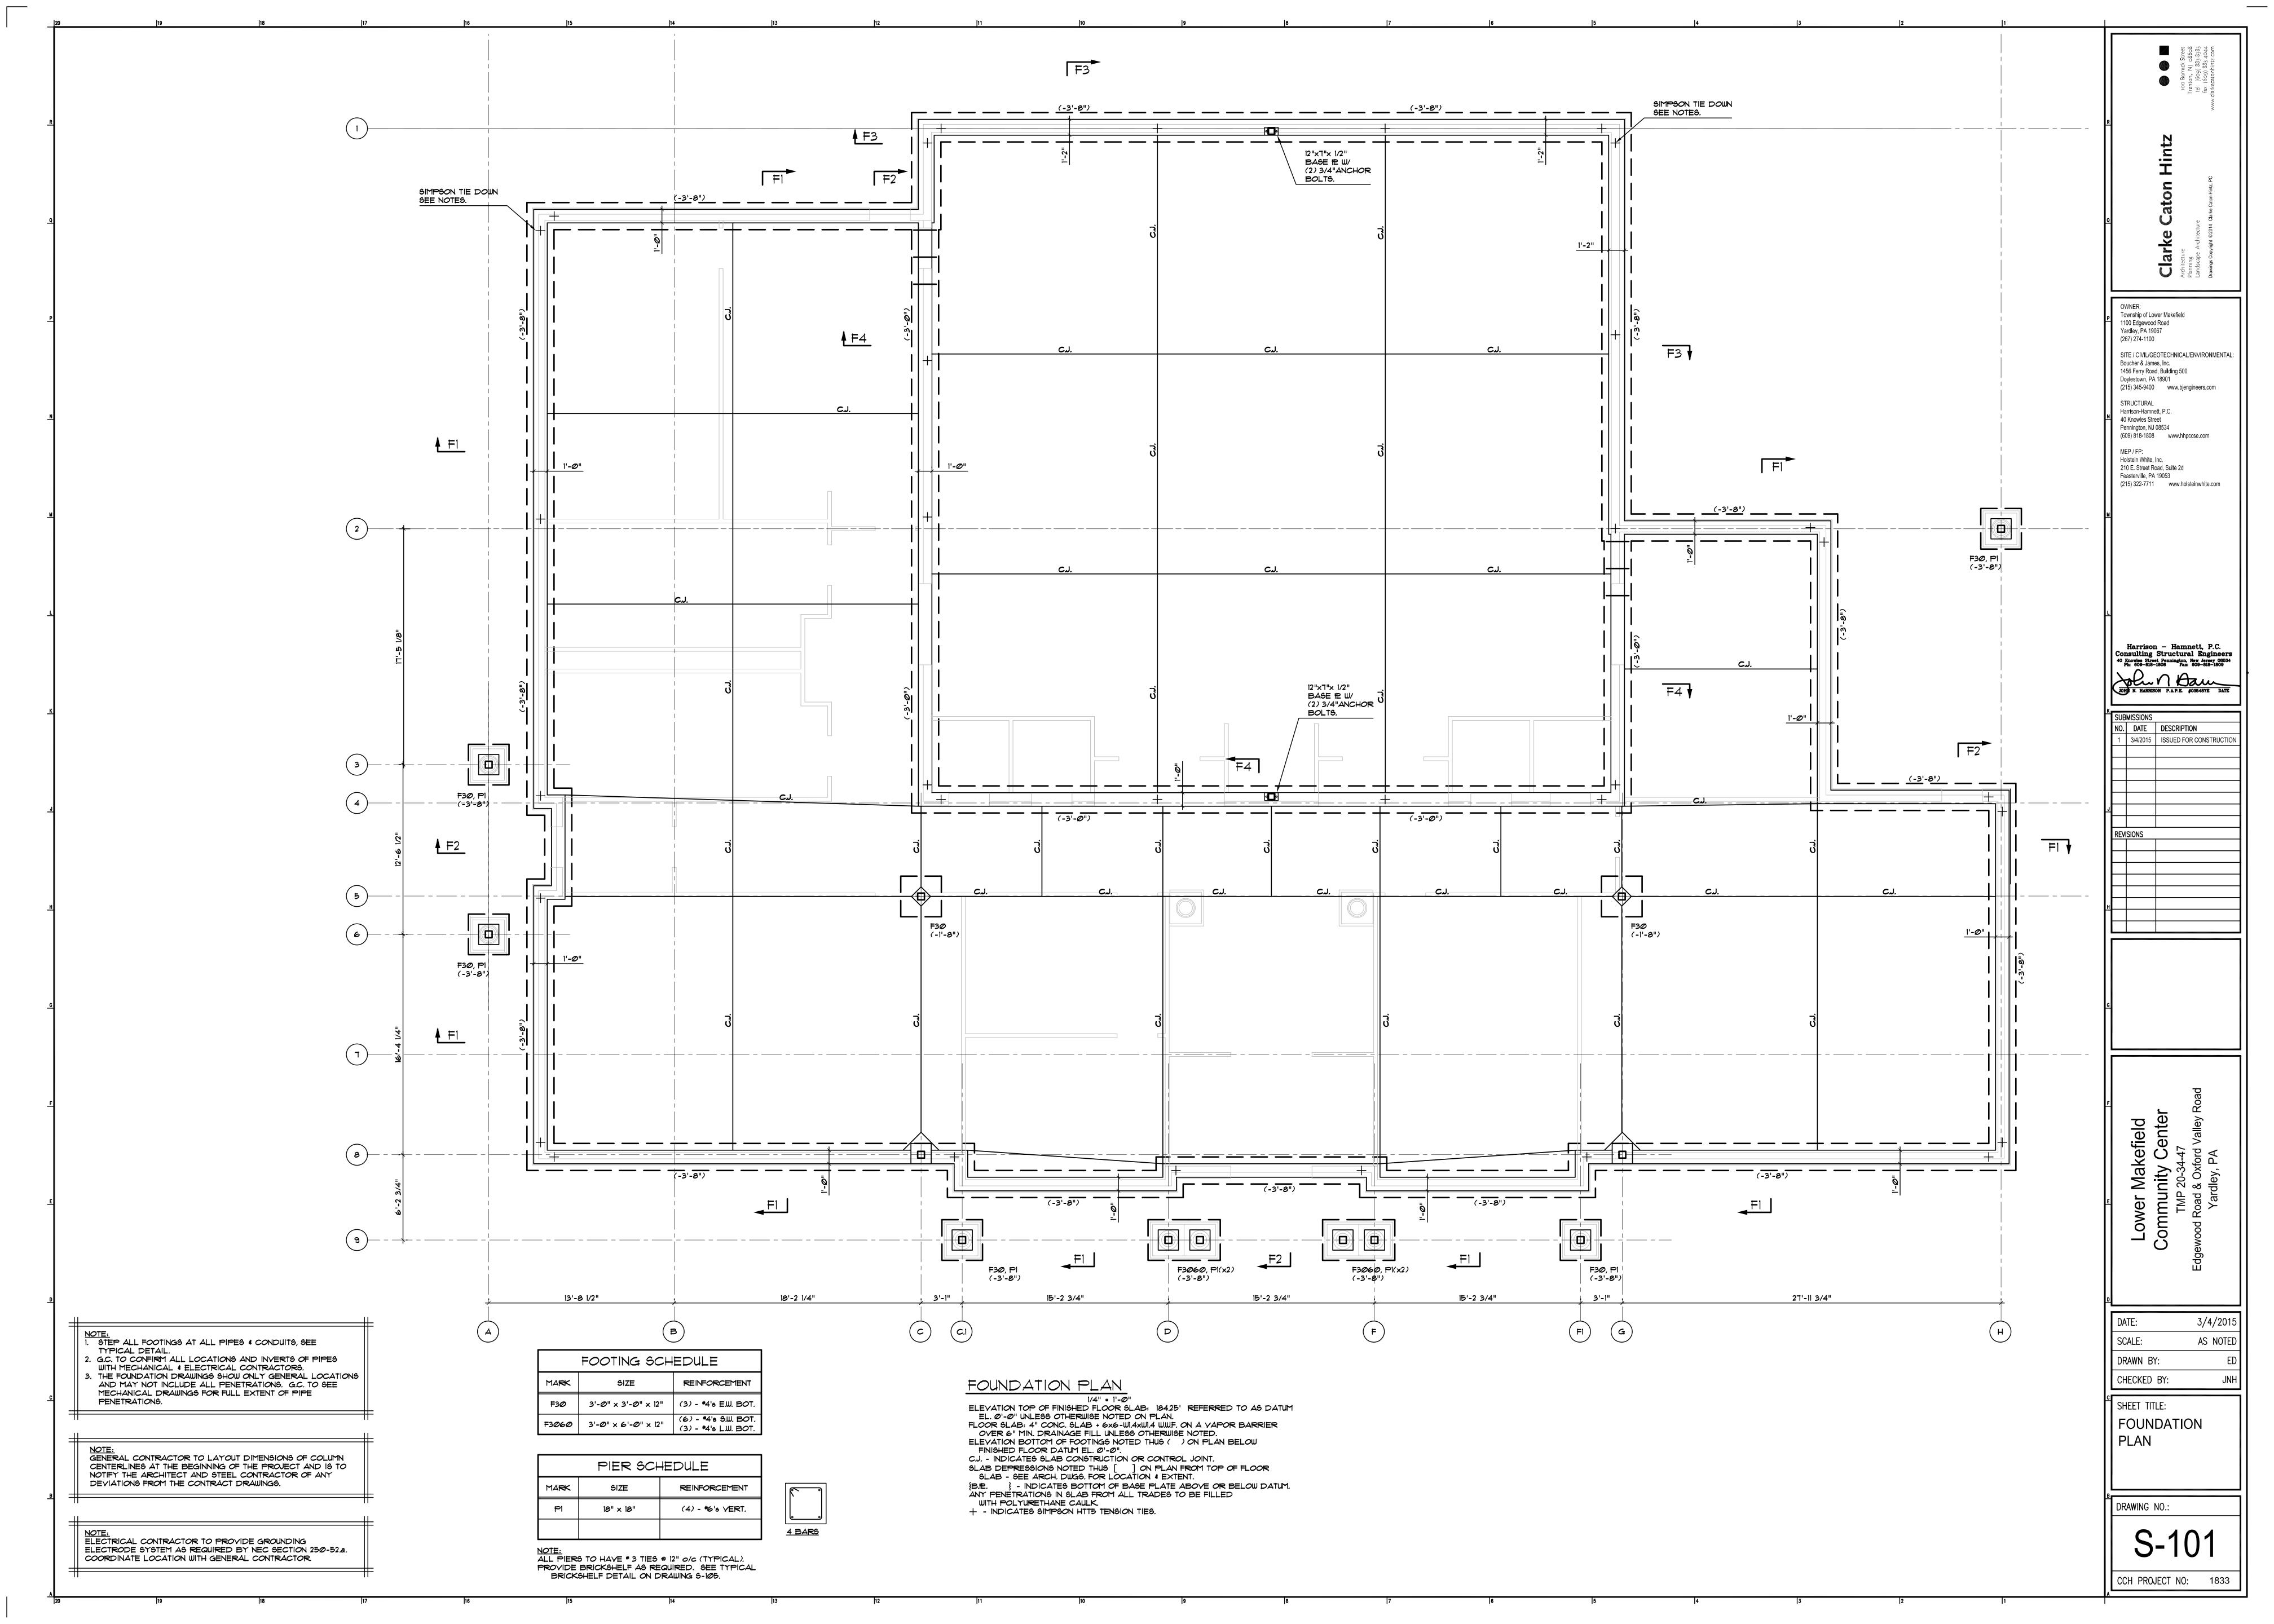

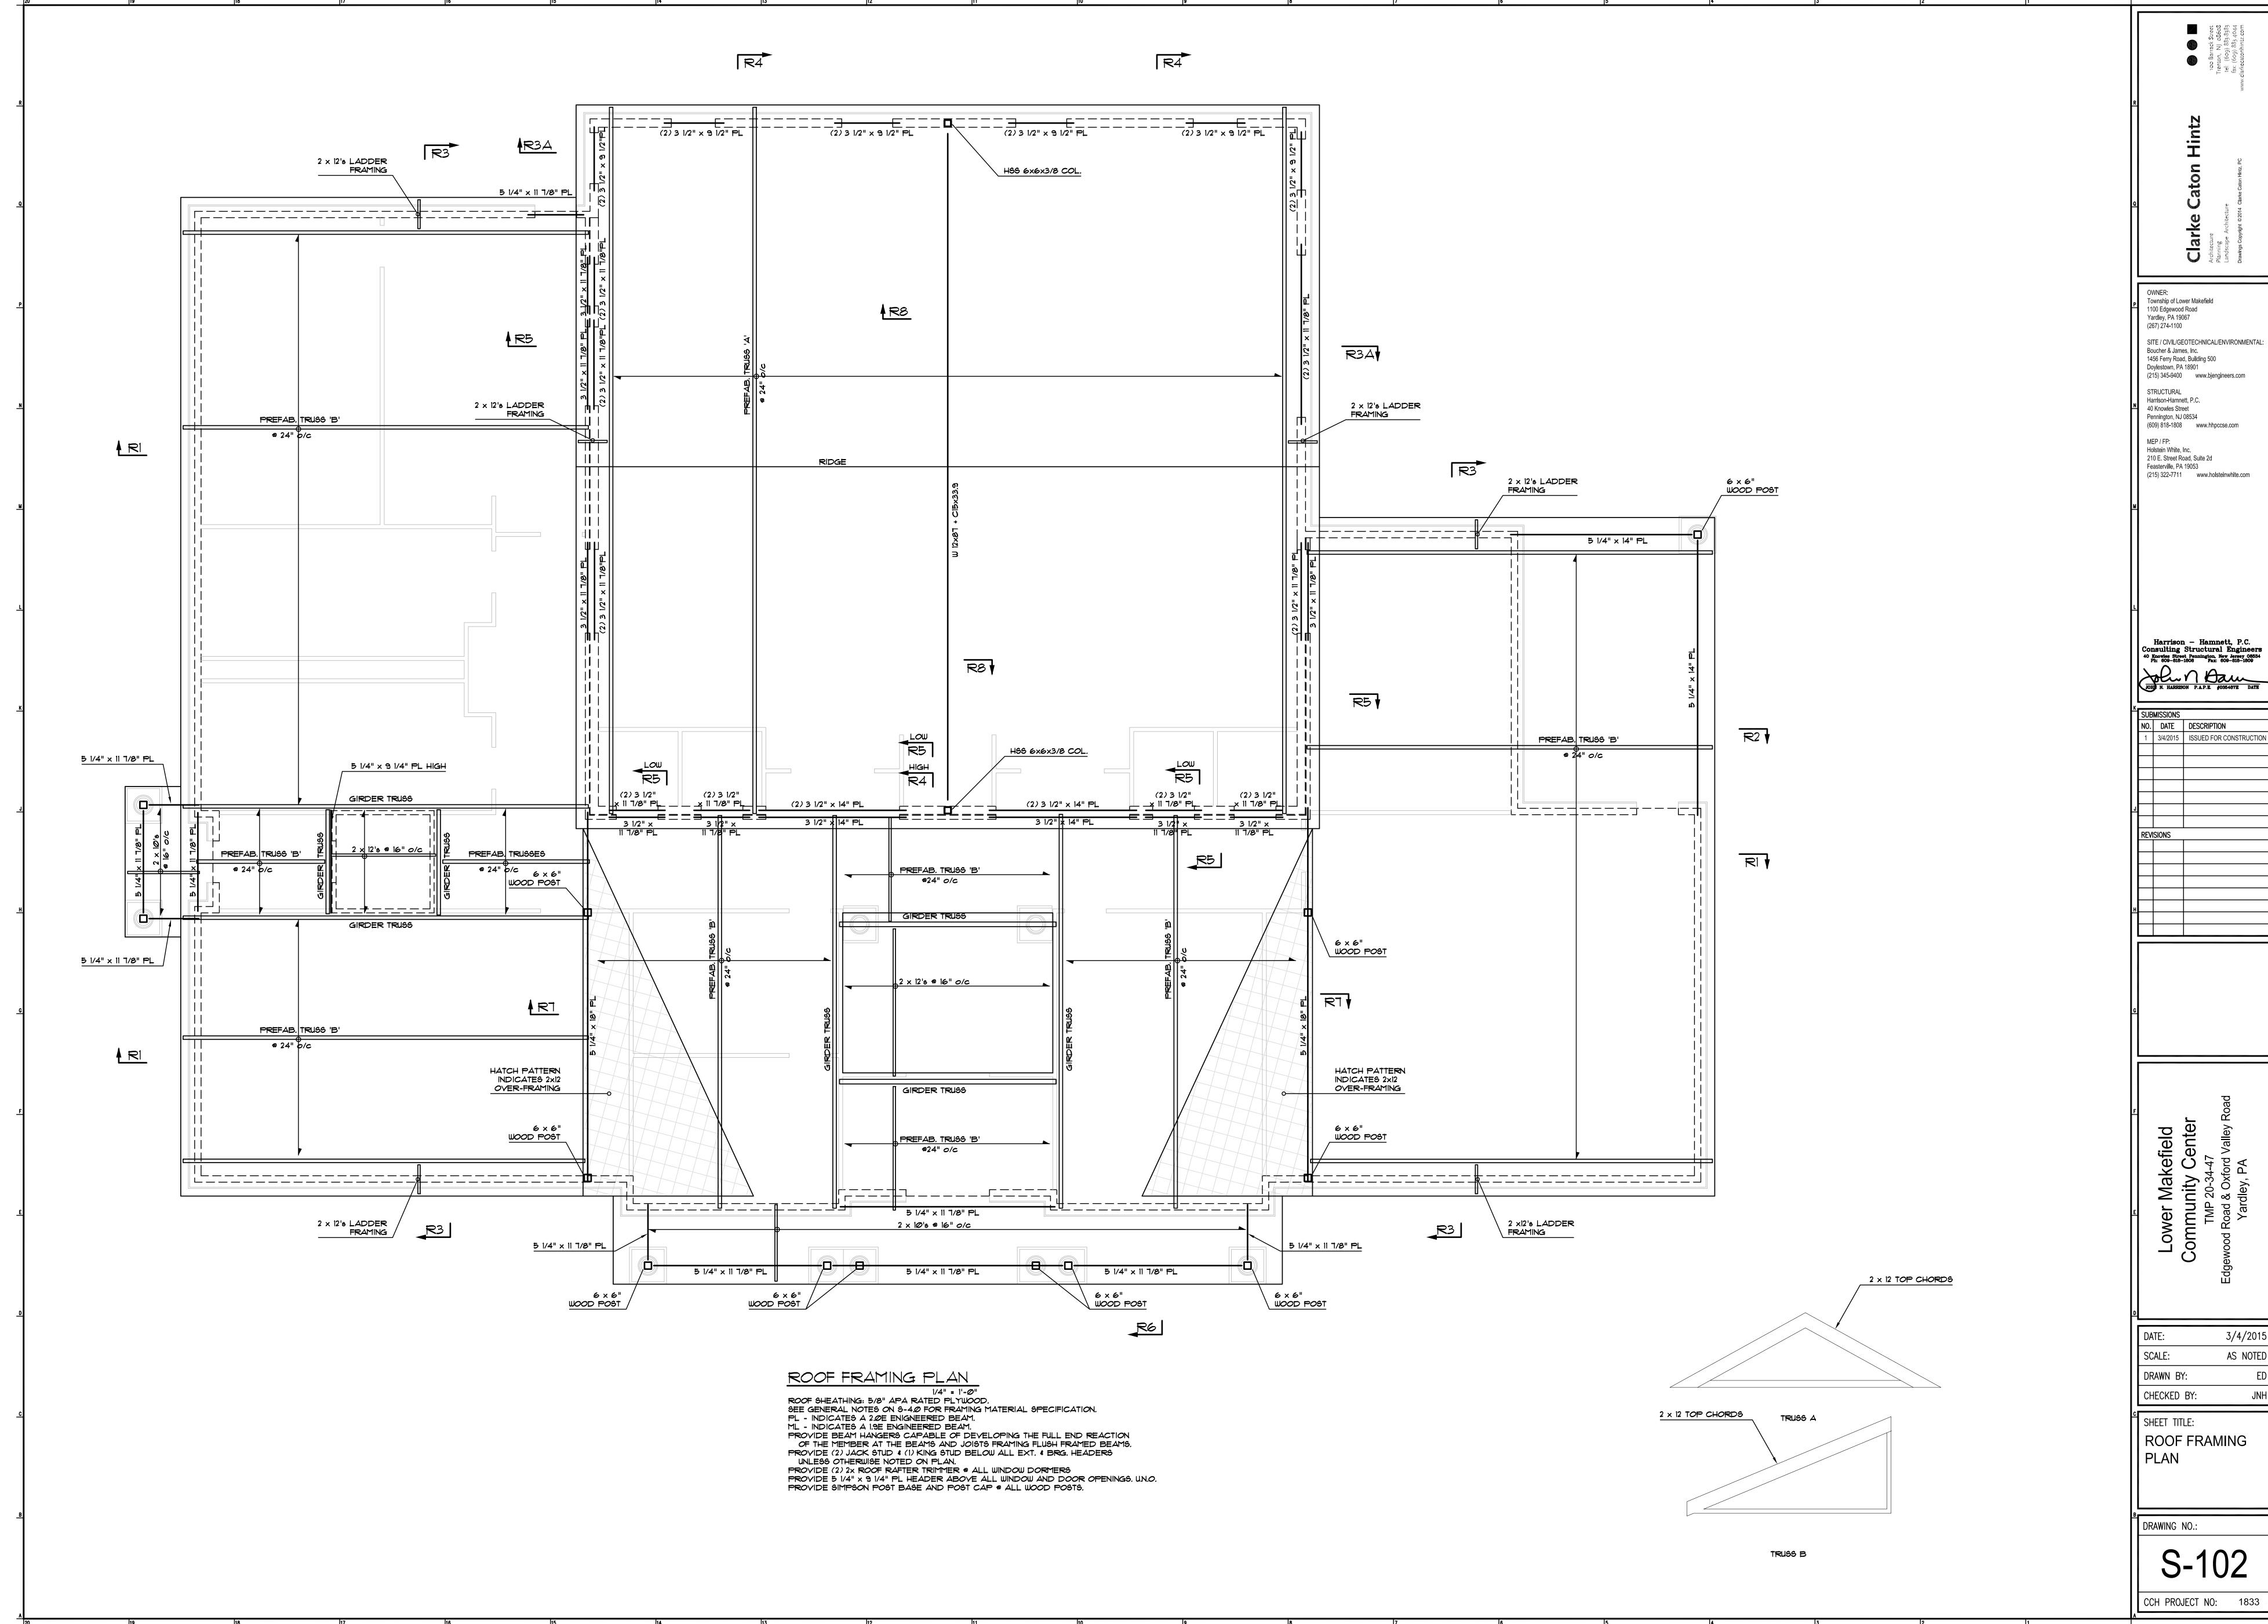3/4/2015 AS NOTED



1. All footings shall bear on soil having a minimum safe bearing capacity of 1.5 tons per square foot. Confirm in field prior to placing footings. 2. Elevations given correspond to the computed bottom of footings and are minimum depths which are not to be construed as limiting in any way the depth

3. No footings shall be placed in water or on frozen ground. After footings are placed they shall be protected against frost. 4. Fill and backfill material shall be free of deleterious organic matter.

6. Fill and backfill shall be clean bank run material conforming to the following graduation: 100% smaller than 4 inch sieve± maximum 15% smaller than #200 sieve, and approved as acceptable by a testing laboratory.

7. No fill or backfill shall be placed over or against work at such time or in such a manner which would endanger the stability or otherwise damage such work 8. All site preparation to be completed as per the requirements noted in the Geo technical report prepared by Duffield Associates, dated Jan 9, 2015.

CAST-IN-PLACE CONCRETE

All concrete work shall conform to the latest edition of the ACI Building Code. All concrete, except slabs on grade, shall attain 3000 PSI compressive strength at 28 days. All concrete for slabs on grade shall attain 3500 PSI compressive

A. Comply with ACI-301, ACI-304 and ASTM C-94.

B. Maximum time between introduction of water and placing to be 1-1/2 hours. C. Minimum cement content shall be 470 pounds per cubic yard for 3000 PSI concrete, and 520 pounds per cubic yard for 3500 PSI concrete. D. Maximum water cement ratio shall be 0.51 for 3000 PSI concrete, and 0.47 for

Township of Lower Makefield

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Consulting Structural Engineers
40 Knowles Street Pennington, New Jersey 08534
Ph: 609-818-1808 Fax: 609-818-1809

JOHN N. HARRISON P.A.P.E. #036487E DATE

3/4/2015 | ISSUED FOR CONSTRUCTI

O. DATE DESCRIPTION

REVISIONS

lakefield ty Cente

wer

DRAWN BY:

CHECKED BY:

1100 Edgewood Road

Yardley, PA 19067

Boucher & James, Inc.

Doylestown, PA 18901

STRUCTURAL

MEP / FP:

Harrison-Hamnett, P.C

Pennington, NJ 08534

40 Knowles Street

Holstein White, Inc.

210 E. Street Road, Suite 2d

Feasterville, PA 19053

1456 Ferry Road, Building 500

(267) 274-1100

E. Maximum slump of concrete shall be 4 inches as determined by ASTM C-143. Maximum slump of concrete shall be 3 inches: and 8" after addition of HRWR to site verified 3" slump for concrete containing HRWR admixture as determined by ASTM

F. All concrete exposed to the ground or weather shall be air entrained between 4-5% as determined by ASTM C-231 or C-173. G. Do not load trucks above rated capacity.

H. High-Range Water-Reducing Admixture (Super Plasticizer) shall conform to ASTM C-494, Type F or G and contain not more than O.I percent chloride ions. 4. Cold weather concreting shall be in accordance with ACI-306.

6. Throughout construction the concrete work shall be adequately protected against damage due to excessive loading, construction equipment, materials or methods, ice, rain, snow, excessive heat and freezing temperatures. 7. Early drying out of concrete, especially during the first 24 hours, shall be carefully guarded against. All surfaces shall be moist cured or protected using a membrane curing agent applied as soon as forms are removed. If membrane curing

9. Concrete shall be conveyed, placed and finished in a workmanlike manner. 10. Prior to making repairs, contractor shall obtain permission from architect to make batches for other than minor honeycombing. il. Contractor to coordinate requirements of structural, architectural, mechanical and

12. All materials shall be stored to protect them against the elements.

1. All reinforcing bar details shall conform to the latest ACI code and detailing

2. All bars shall be ASTM A-615, Grade 60. Welded wire fabric shall be ASTM A-185.

4. Provide and schedule with the shop drawings all necessary accessories to hold reinforcing securely in position. 5. Clearance of main reinforcing from adjacent surfaces unless shown otherwise shall

B. Bottom surfaces of slabs on grade: 3" C. Formed surfaces in contact with ground or exposed to weather: *5 bars or smaller: 1-1/2

Bars larger than #5: 2"

E. In all cases not less than the diameter of the bar. 6. All reinforcement shall be inspected and approved by architect or his designate

before concrete is poured.

A. +or- 1/4 inch for members with an effective depth of 24 inches or less. B. +or- 1/2 inch for members with an effective depth of more than 24 inches. 8. Where continuous bars are called for, they shall be run continuously around corners and lapped at necessary splices or hooked at discontinuous ends. Laps

shall be 40 bar diameters. Bar laps may be offset to avoid control or construction 9. Provide #5 top and bottom in slabs and #5 each face in walls at all four sides of an opening, unless otherwise noted. Extend bars 2'-0" beyond opening or hook

10. Electrical Contractor to provide grounding electrode system as required by NEC section 250-52(a). Coordinate location and schedule with General Contractor

1. All block work shall be in accordance with IBC2009 w/NJ Modification and other

2. All block shall be lightweight aggregate and conform to ASTM C 90.

3. Mortar shall be ASTM C 270, Type M for below grade and Type M or S for above

4. Horizontal reinforcing shall be No. 9 gage "Dur-o-wall or equivalent. Provide fabricated corner sections at all corners. Where masonry is laid in other then running bond, horizontal joint reinforcement is to be provided at every horizontal joint. 5. Where block fill is called for on drawings, use Type M mortar or concrete with a compressive strength of 2500 PSI in accordance with ASTM C 476, and installed in accordance with ACI-531 for high or low lift procedures.

Prefabricated wood trusses shall be designed and manufactured by the truss manufacturer. See required design loads on drawings. 2. Submit signed and sealed shop drawings and calculations for review prior to 3. Installation to be in strict accordance with manufacturer's recommendations. Brace trusses during erection as per manufacturer's recommendations.

l. Joists and rafters shall be Douglas Fir No. 2 Grade or better as graded by 2. Studs shall be equal to Hem Fir Construction Grade or better as graded by 3. All connectors, nails, lag bolts, thru-bolts being used in contact with Alkaline Copper Quaternary (ACQ) treated lumber are to be hot-dipped zinc galvanized,

1. All plywood sheathing shall comply with APA. Plywood shall meet C-D Interior APA, Structural I and II C-D Interior APA, or Structural I and II C-D Exterior APA.

2. Roof sheathing: 5/8" thick 40/20. 8d nails @ 6" o/c.

5. All plywood to have exterior glue.

PREFABRICATED WOOD FRAMING

1. All 1.9E MICROLLAM (LVL) Lumber and 2.0E PARALLAM (PSL) shall conform to the latest specifications as prepared by iLevel, a Weyerhaeuser Business, or approved 2. All TJI joists shall conform to the latest specifications as prepared by iLevel, a Wegerhaeuser Business, or approved alternate.

4. All penetrations to be located as per manufacturer's recommendations.

5. Provide temporary bracing as per manufacturer's recommendations. 6. Top chord of trusses to be 2x12 member.


Contractor shall verify all dimensions, sections and elevations on the job. 2. Consult the Architectural, Mechanical and Electrical drawings for verification of location and dimensions of chases, inserts, openings, sleeves, washes, drips, reveals, depressions, equipment pads and other product requirement 3. All foundation walls shall be braced during the operations of backfilling and compaction. Bracing shall be left in position until permanent restraints have been


> SHEET TITLE: TYPICAL DETAILS & GENERAL **NOTES**


3/4/2015

AS NOTED

DRAWING NO.:

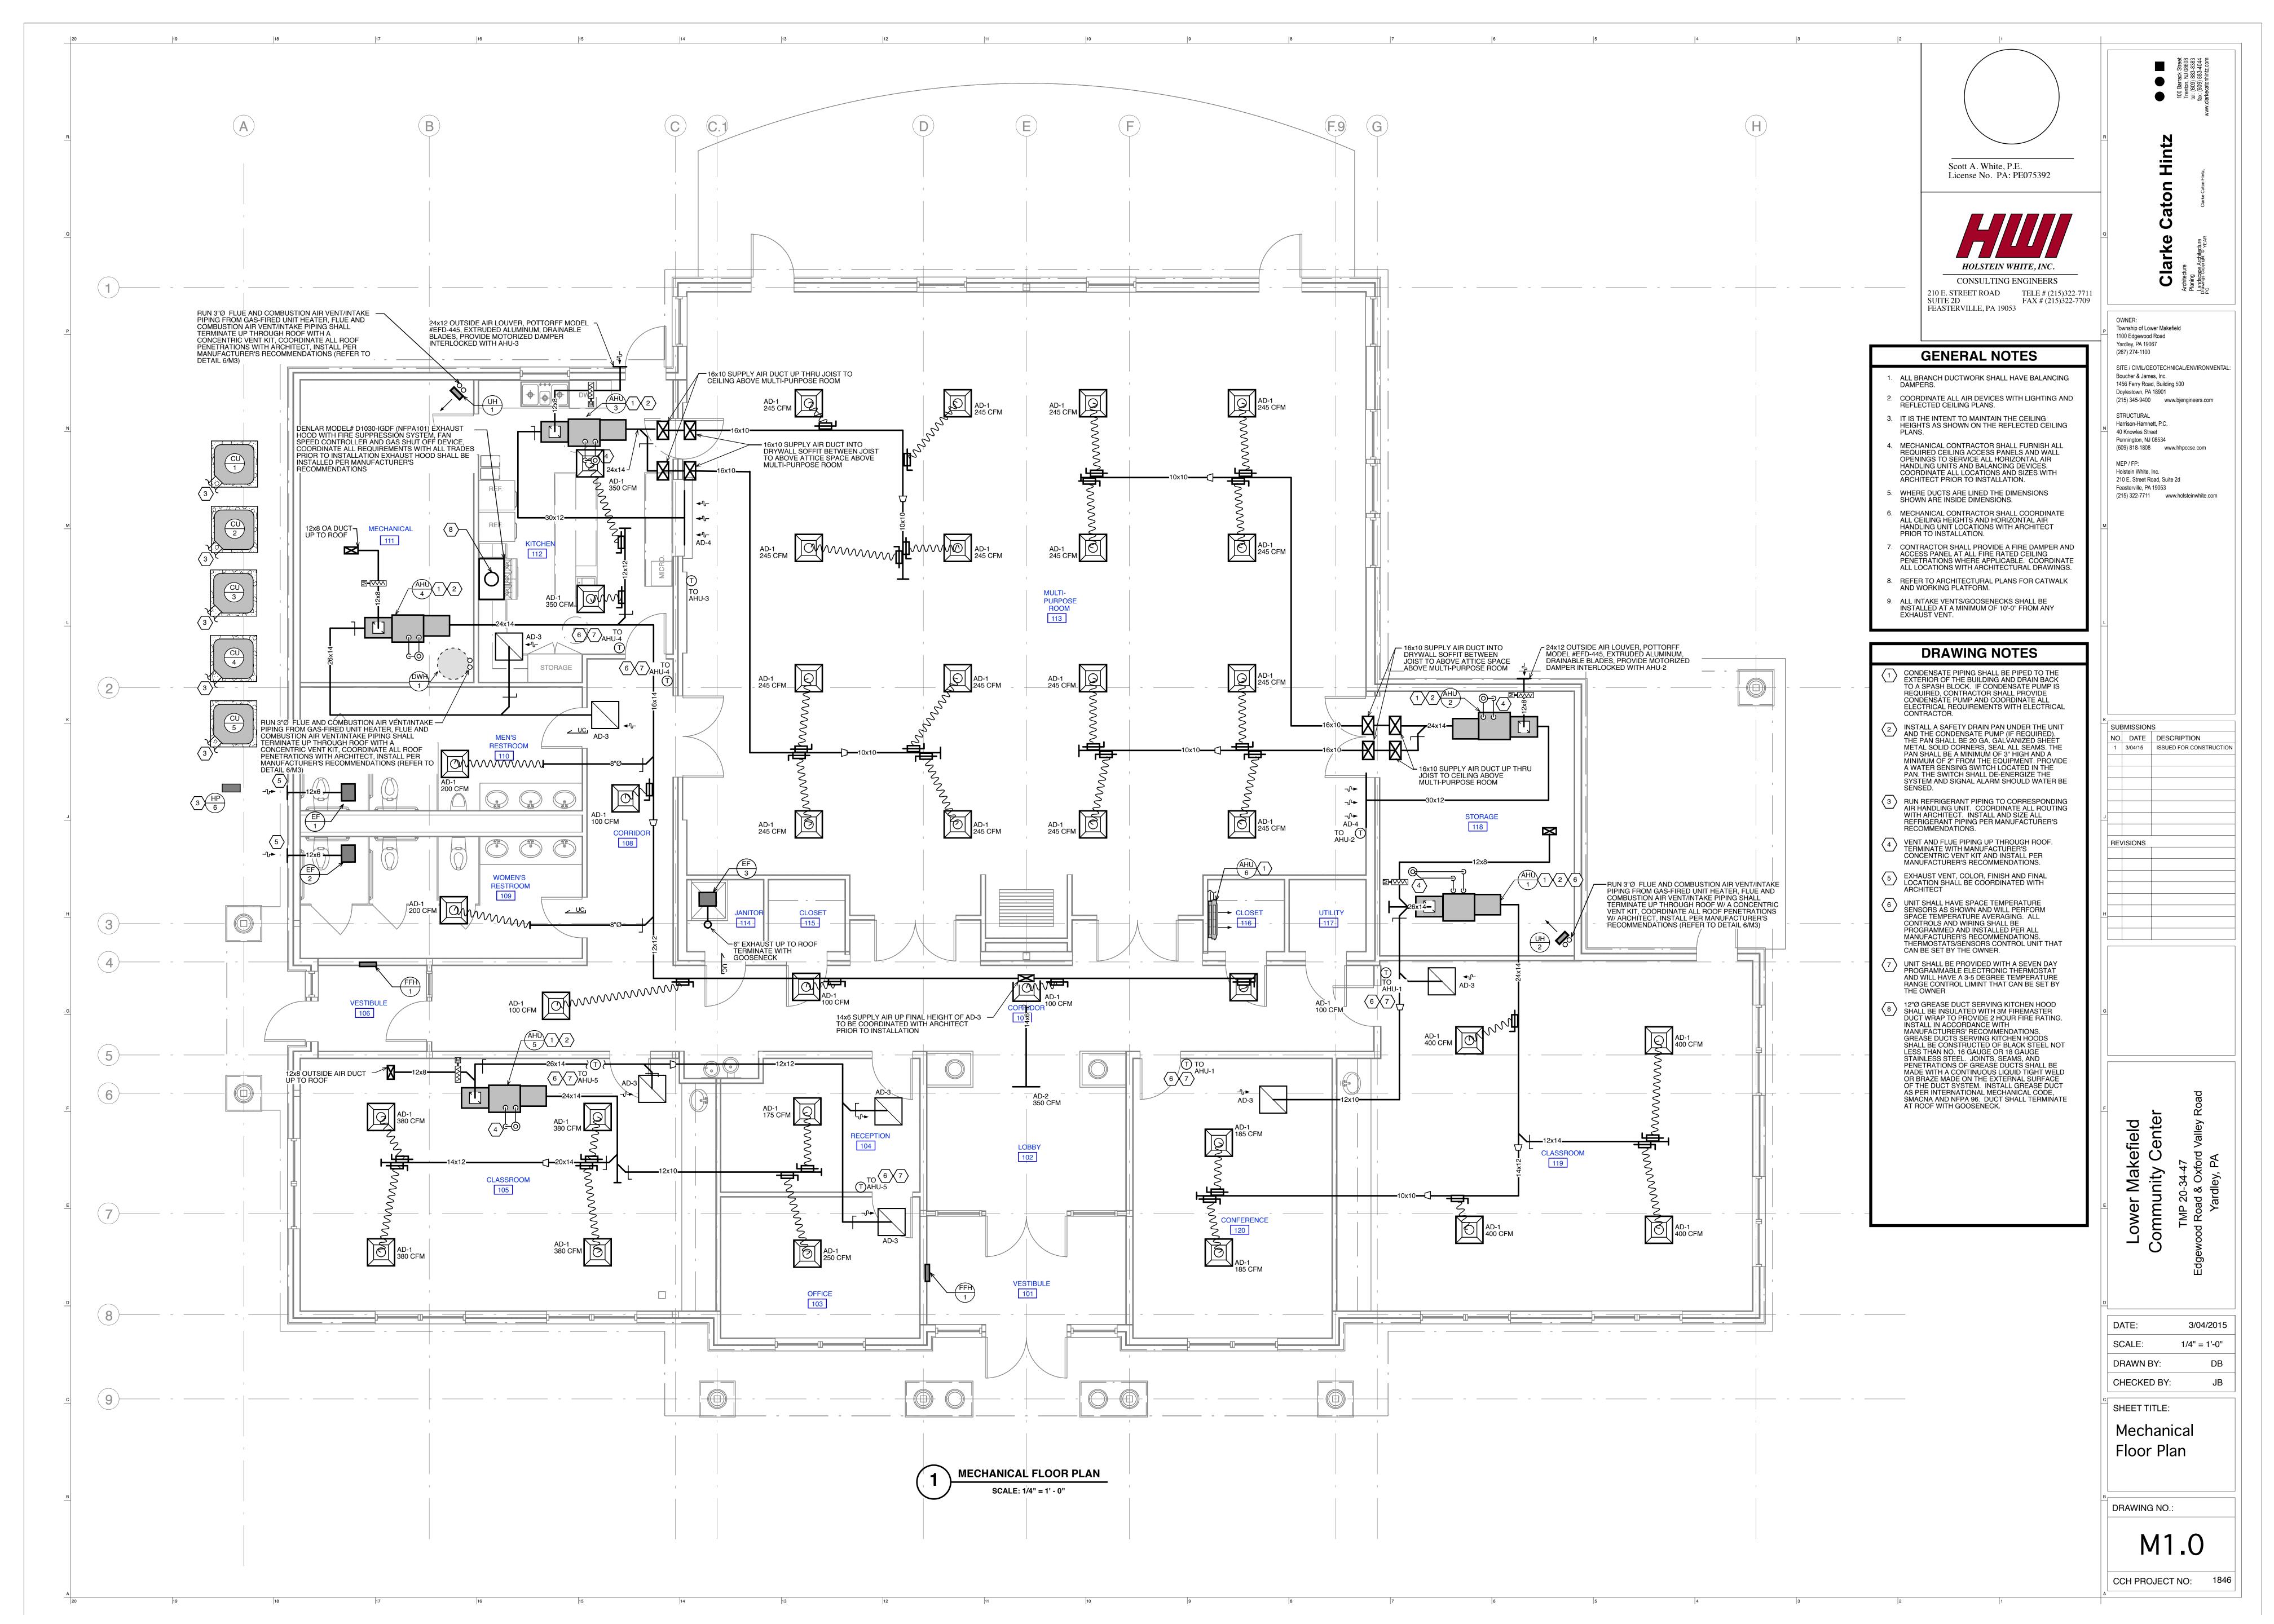

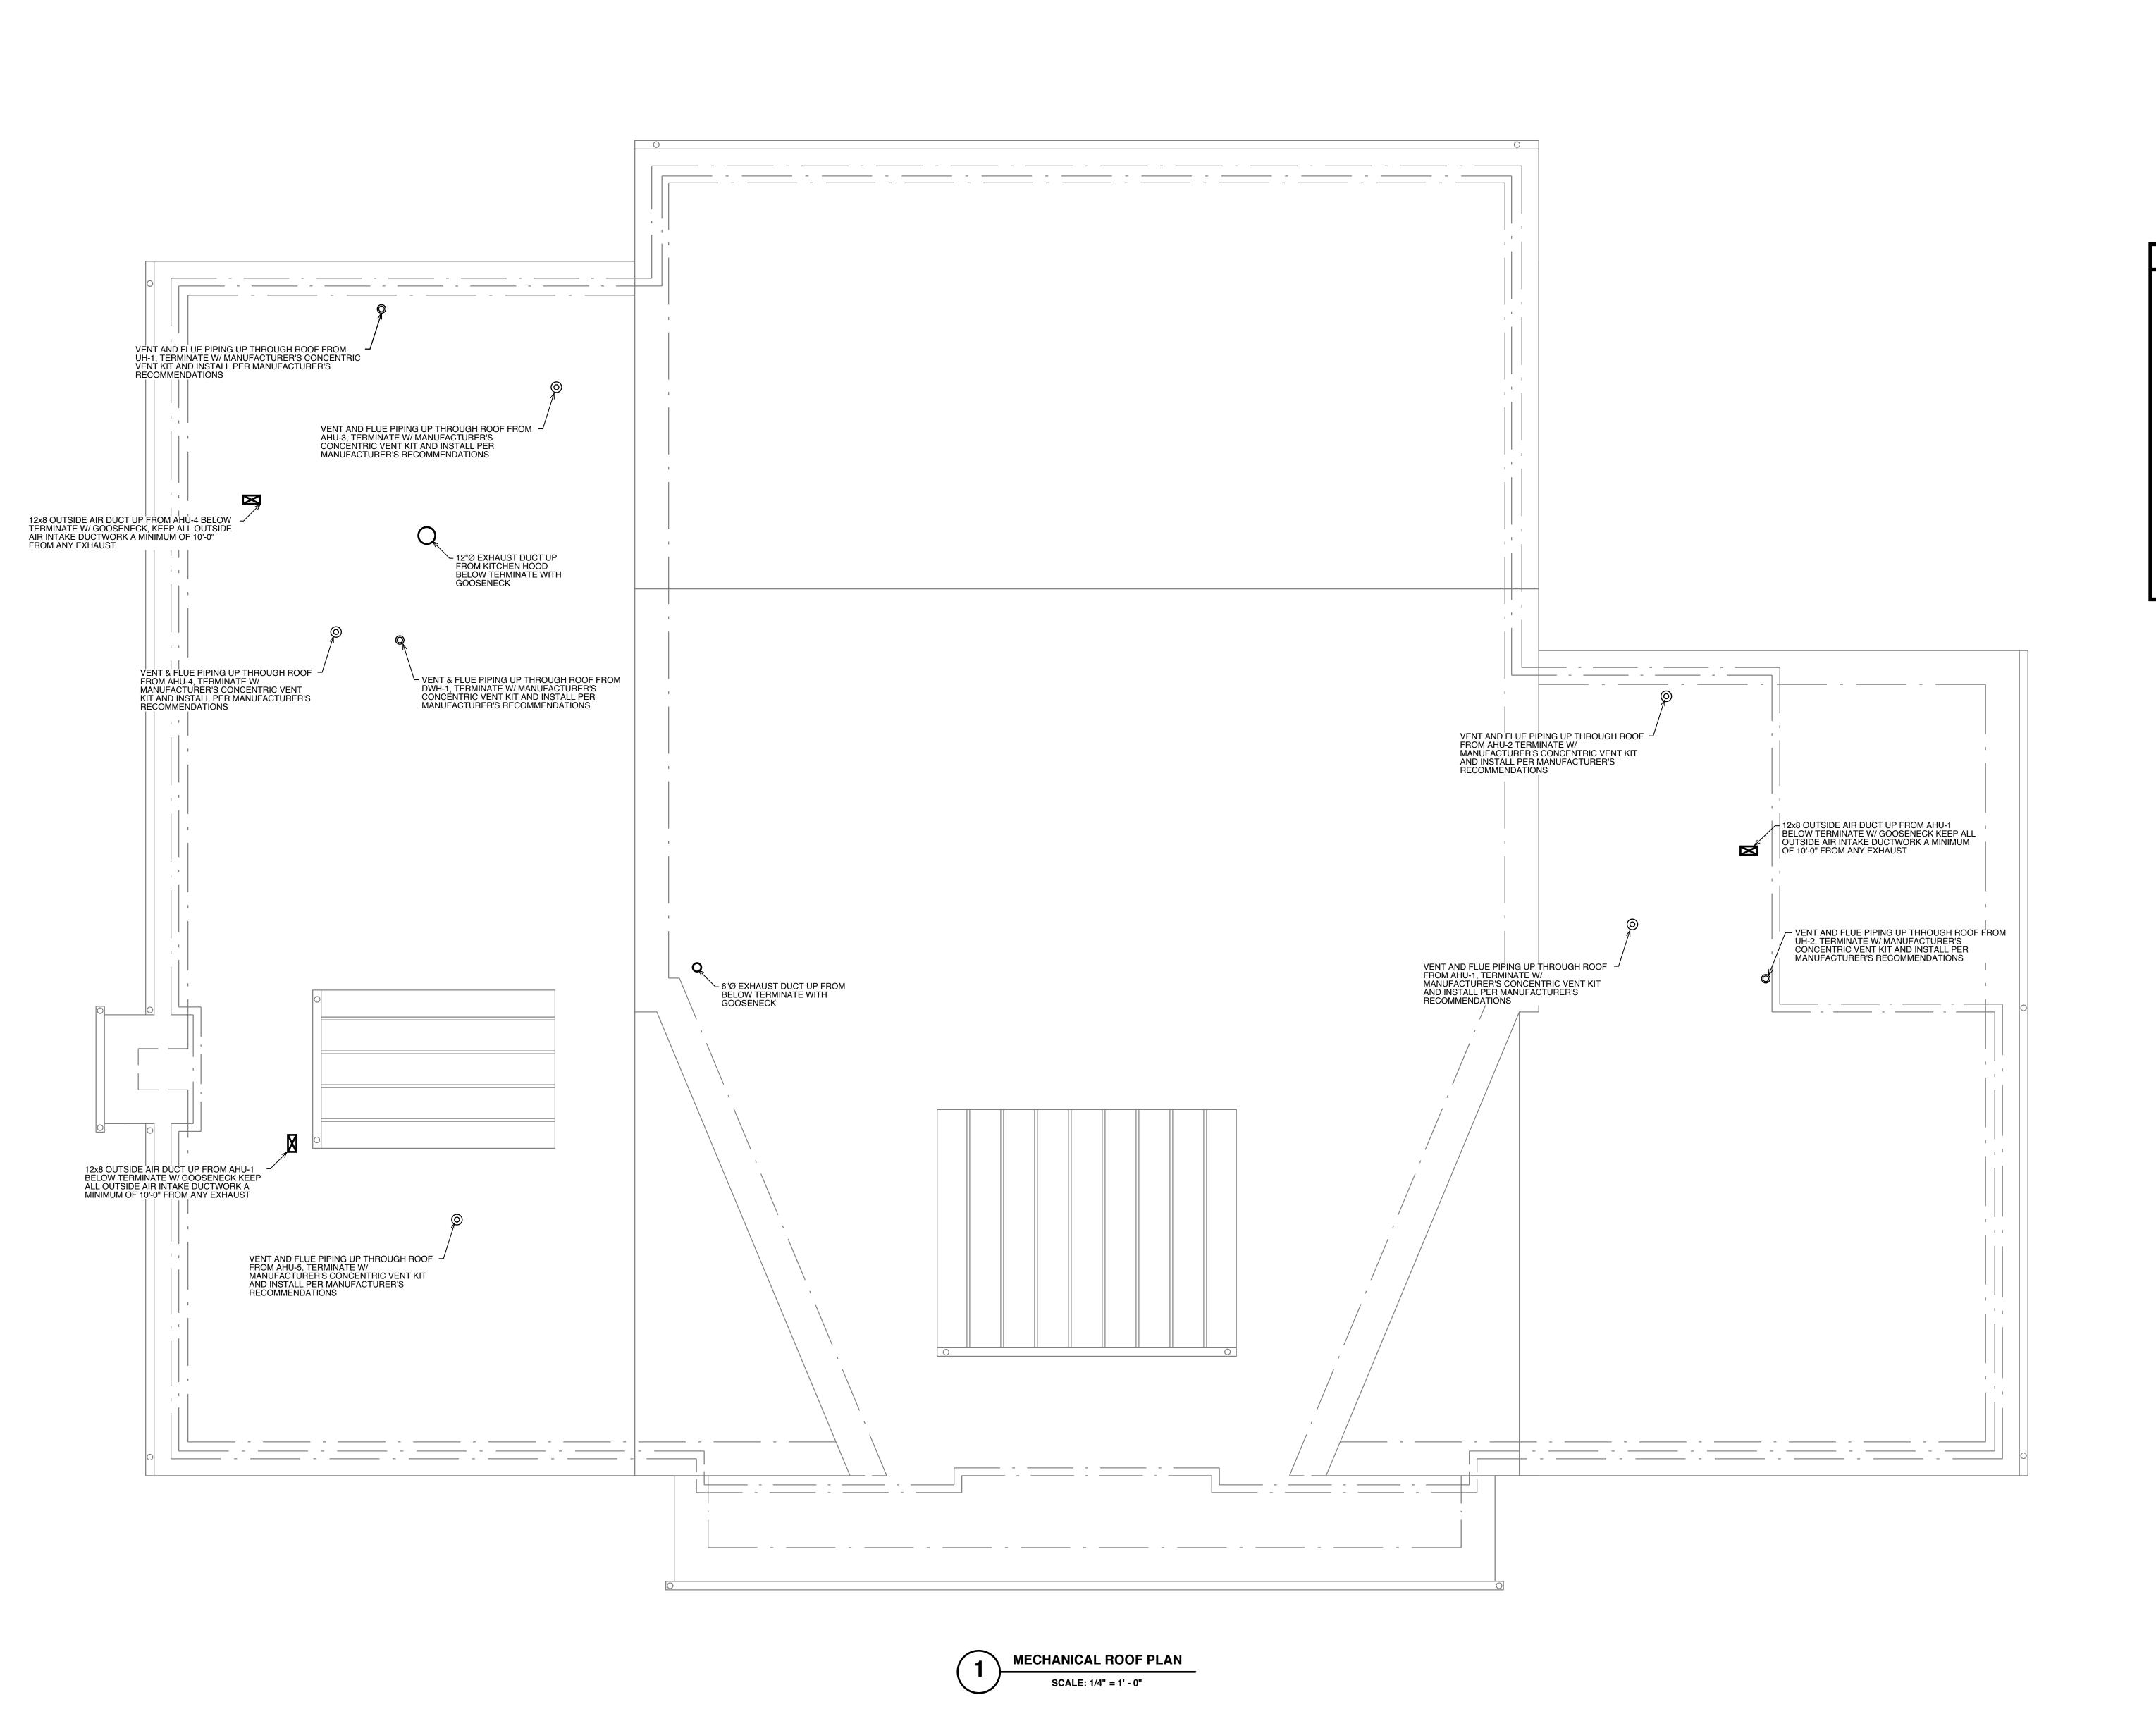

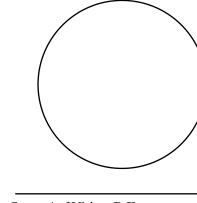

Scott A. White, P.E. License No. PA: PE075392



210 E. STREET ROAD TELE # (215)322-7711 SUITE 2D FAX # (215)322-7709 FEASTERVILLE, PA 19053

GENERAL NOTES

- ALL BRANCH DUCTWORK SHALL HAVE BALANCING DAMPERS.
- COORDINATE ALL AIR DEVICES WITH LIGHTING AND REFLECTED CEILING PLANS.
- 3. IT IS THE INTENT TO MAINTAIN THE CEILING HEIGHTS AS SHOWN ON THE REFLECTED CEILING
- 4. MECHANICAL CONTRACTOR SHALL FURNISH ALL REQUIRED CEILING ACCESS PANELS AND WALL OPENINGS TO SERVICE ALL HORIZONTAL AIR HANDLING UNITS AND BALANCING DEVICES. COORDINATE ALL LOCATIONS AND SIZES WITH ARCHITECT PRIOR TO INSTALLATION.
- 5. WHERE DUCTS ARE LINED THE DIMENSIONS SHOWN ARE INSIDE DIMENSIONS.
- 6. MECHANICAL CONTRACTOR SHALL COORDINATE ALL CEILING HEIGHTS AND HORIZONTAL AIR HANDLING UNIT LOCATIONS WITH ARCHITECT PRIOR TO INSTALLATION. 7. CONTRACTOR SHALL PROVIDE A FIRE DAMPER AND ACCESS PANEL AT ALL FIRE RATED CEILING PENETRATIONS WHERE APPLICABLE. COORDINATE
- ALL LOCATIONS WITH ARCHITECTURAL DRAWINGS.

EXHAUST VENT.

8. REFER TO ARCHITECTURAL PLANS FOR CATWALK AND WORKING PLATFORM. 9. ALL INTAKE VENTS/GOOSENECKS SHALL BE INSTALLED AT A MINIMUM OF 10'-0" FROM ANY

(267) 274-1100 SITE / CIVIL/GEOTECHNICAL/ENVIRONMENTAL: Boucher & James, Inc.

1456 Ferry Road, Building 500 Doylestown, PA 18901 (215) 345-9400 www.bjengineers.com STRUCTURAL

Township of Lower Makefield 1100 Edgewood Road Yardley, PA 19067

Harrison-Hamnett, P.C. 40 Knowles Street Pennington, NJ 08534 (609) 818-1808 www.hhpccse.com

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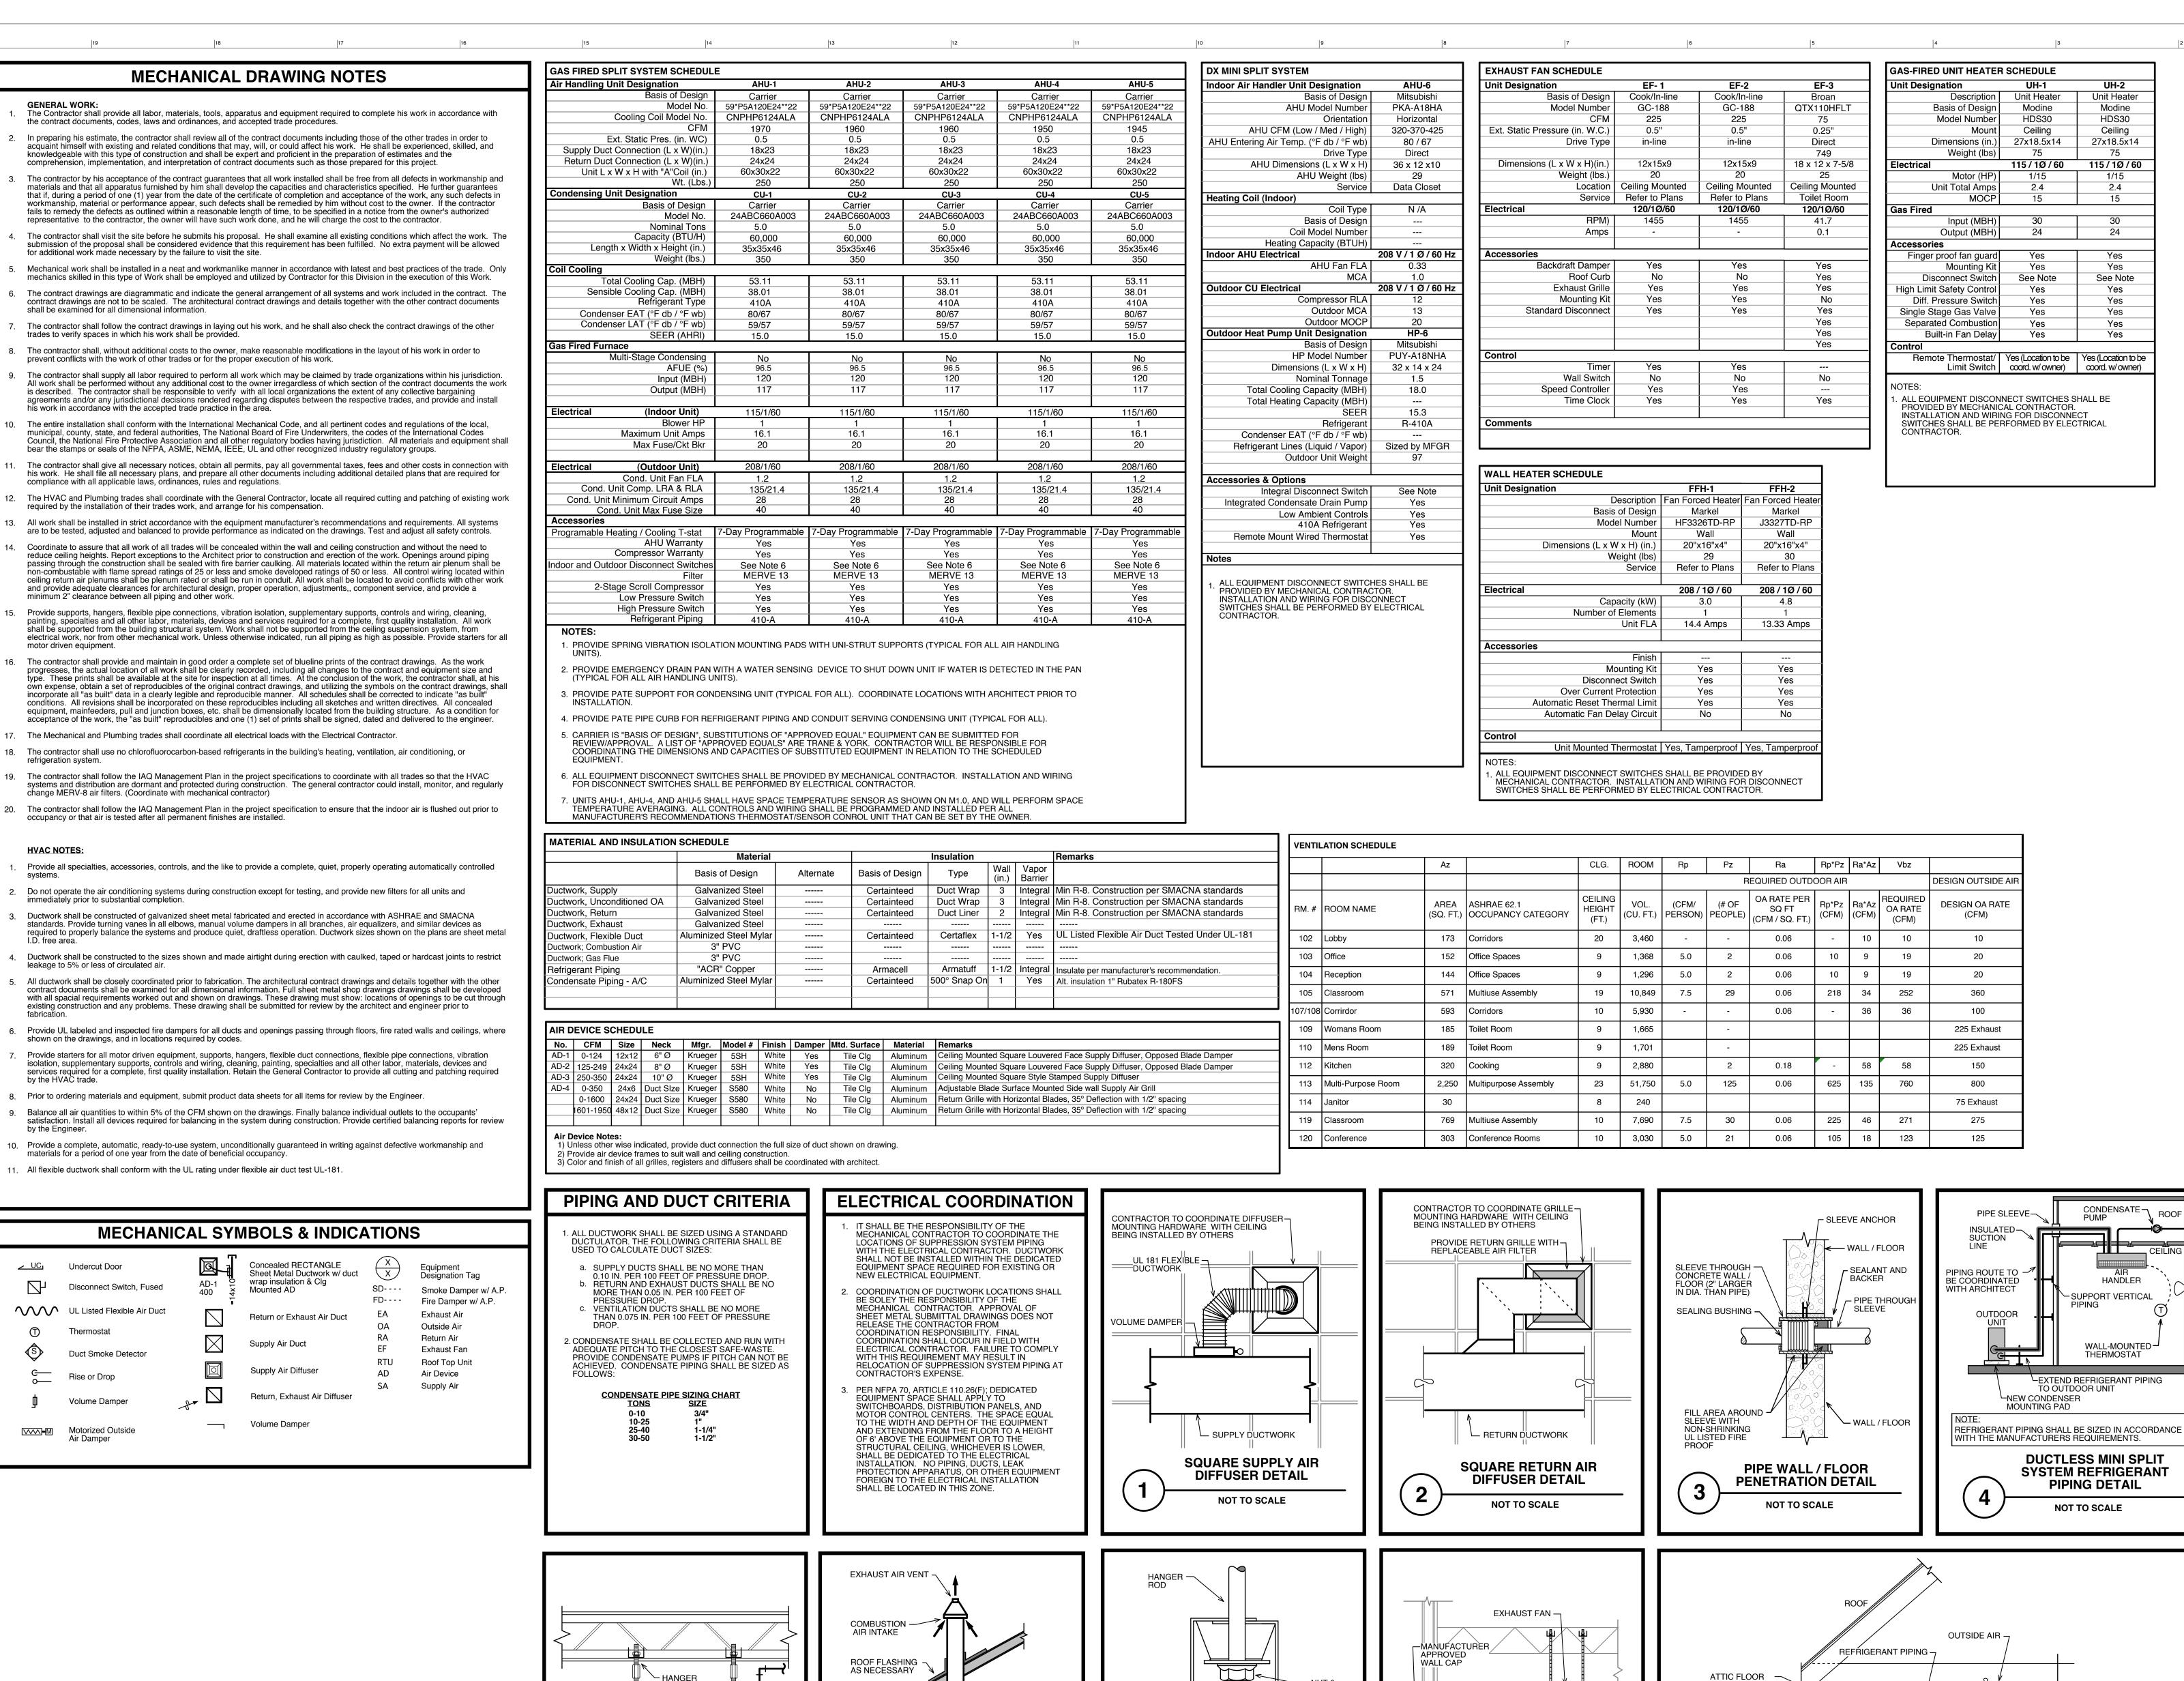
Lower Makefield Community Center

3/04/2015 SCALE: 1/4" = 1'-0" DRAWN BY: CHECKED BY:

SHEET TITLE:

Mechanical Roof Plan

DRAWING NO.:



- THREADED

TYPICAL GAS-FIRED

UNIT HEATER DETAIL

EXHAUST AIR —

CONCENTRIC VENT ROOF

PENETRATION DETAIL

NOT TO SCALE

─ COMBUSTION

—

WASHER

SPRING ISOLATOR DETAIL

NOT TO SCALE

CFILING

TO ELECTRICAL -


EXHAUST FAN SHALL BE ON TIME -> (S

TYPICAL TOILET ROOM

EXHAUST FAN

DELAY AND INTERLOCKED WITH

LIGHT SWITCH. COORDINATE TIME DELAY LENGTH WITH THE

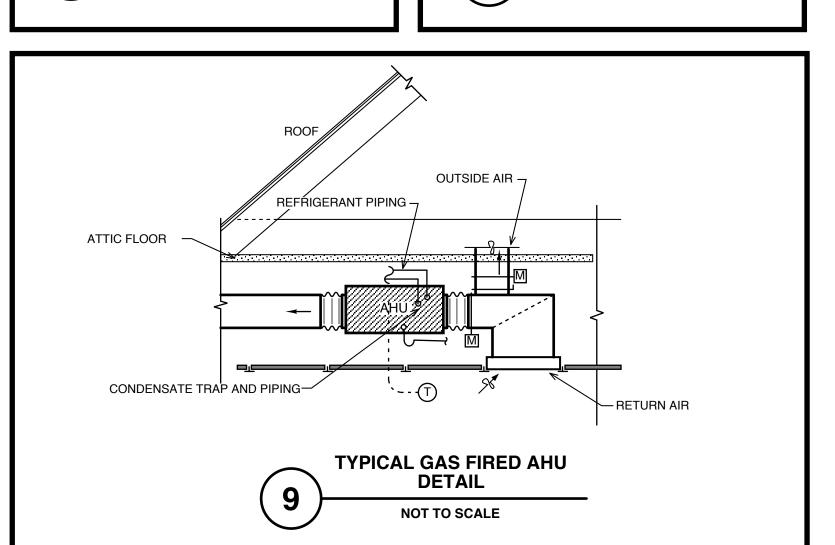

UH-1

HDS30

27x18.5x14

See Note

HDS30

27x18.5x14

115/1Ø/60

See Note

CONDENSATE -

HANDLER

WALL-MOUNTED -

THERMOSTAT

EXTEND REFRIGERANT PIPING

DUCTLESS MINI SPLIT

SYSTEM REFRIGERANT

PIPING DETAIL

NOT TO SCALE

TO OUTDOOR UNIT

-NEW CONDENSER

MOUNTING PAD

SUPPORT VERTICAL

Scott A. White, P.E. License No. PA: PE075392



Township of Lower Makefield 1100 Edgewood Road Yardley PA 19067 (267) 274-1100

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MFP / FP·

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Makefield

3/04/2015 **SCALE** 1/4" = 1'-0" DRAWN BY:


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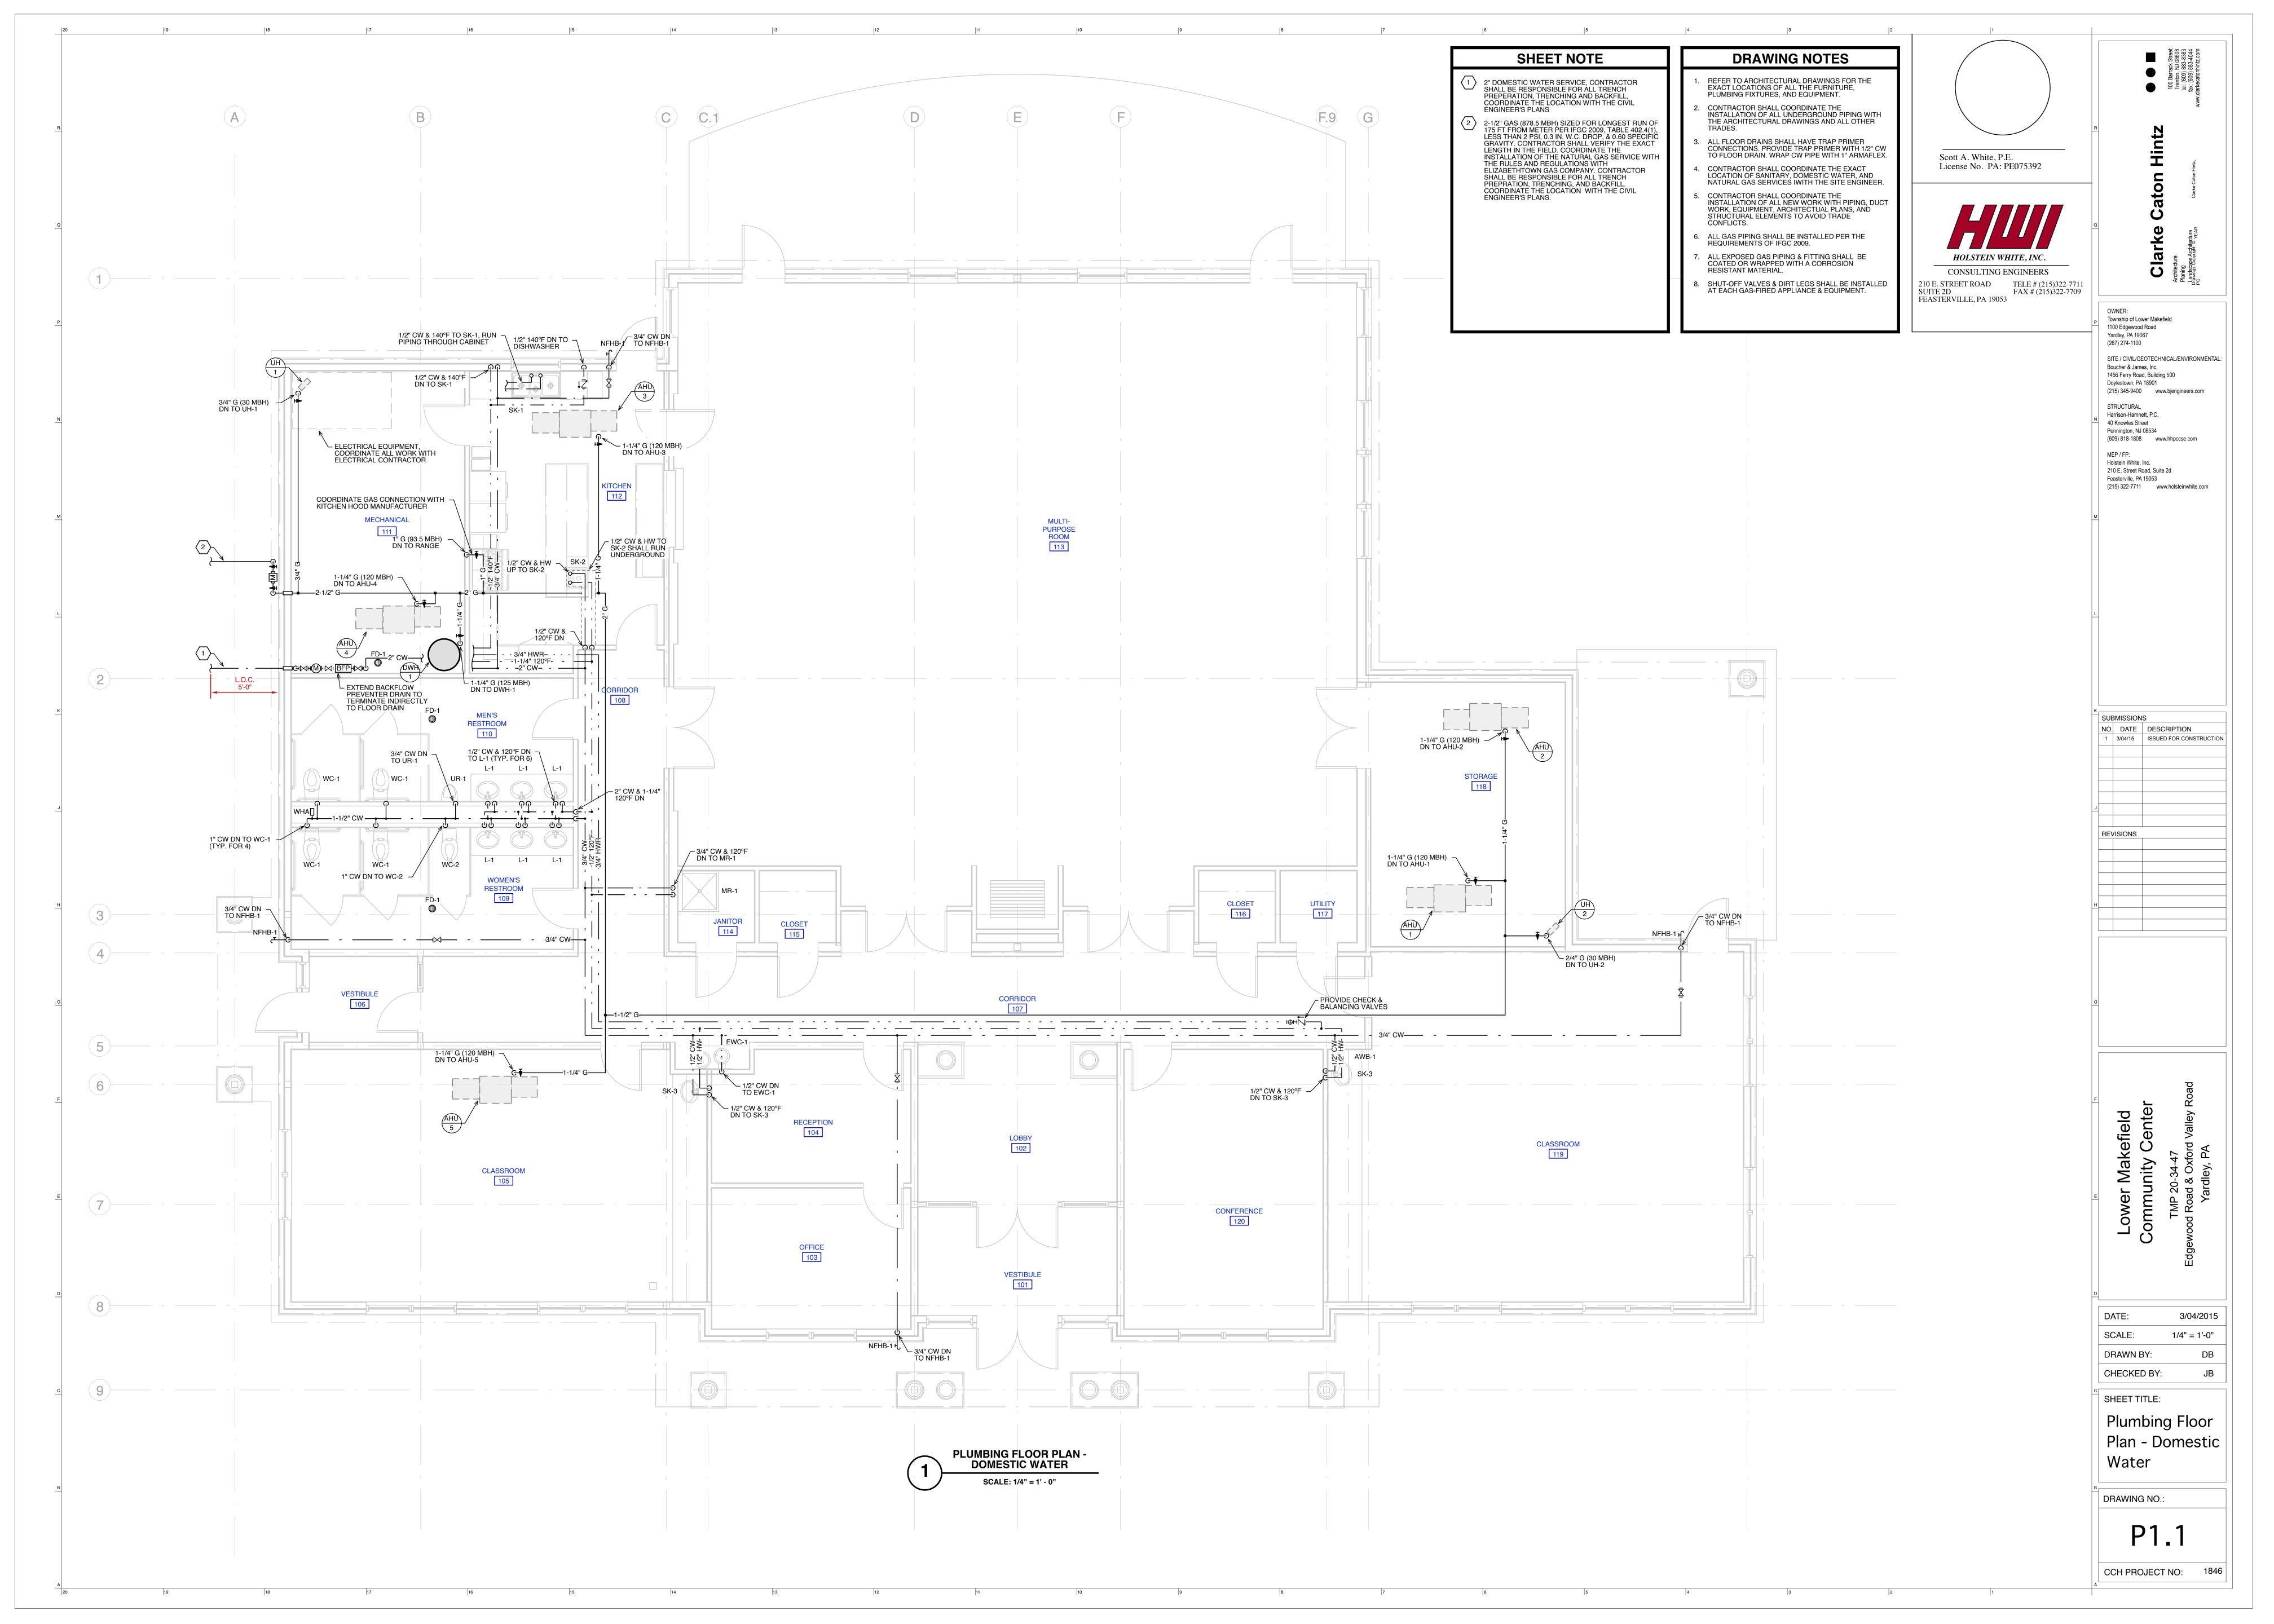
Mechanical Schedules and


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Details

M3.0





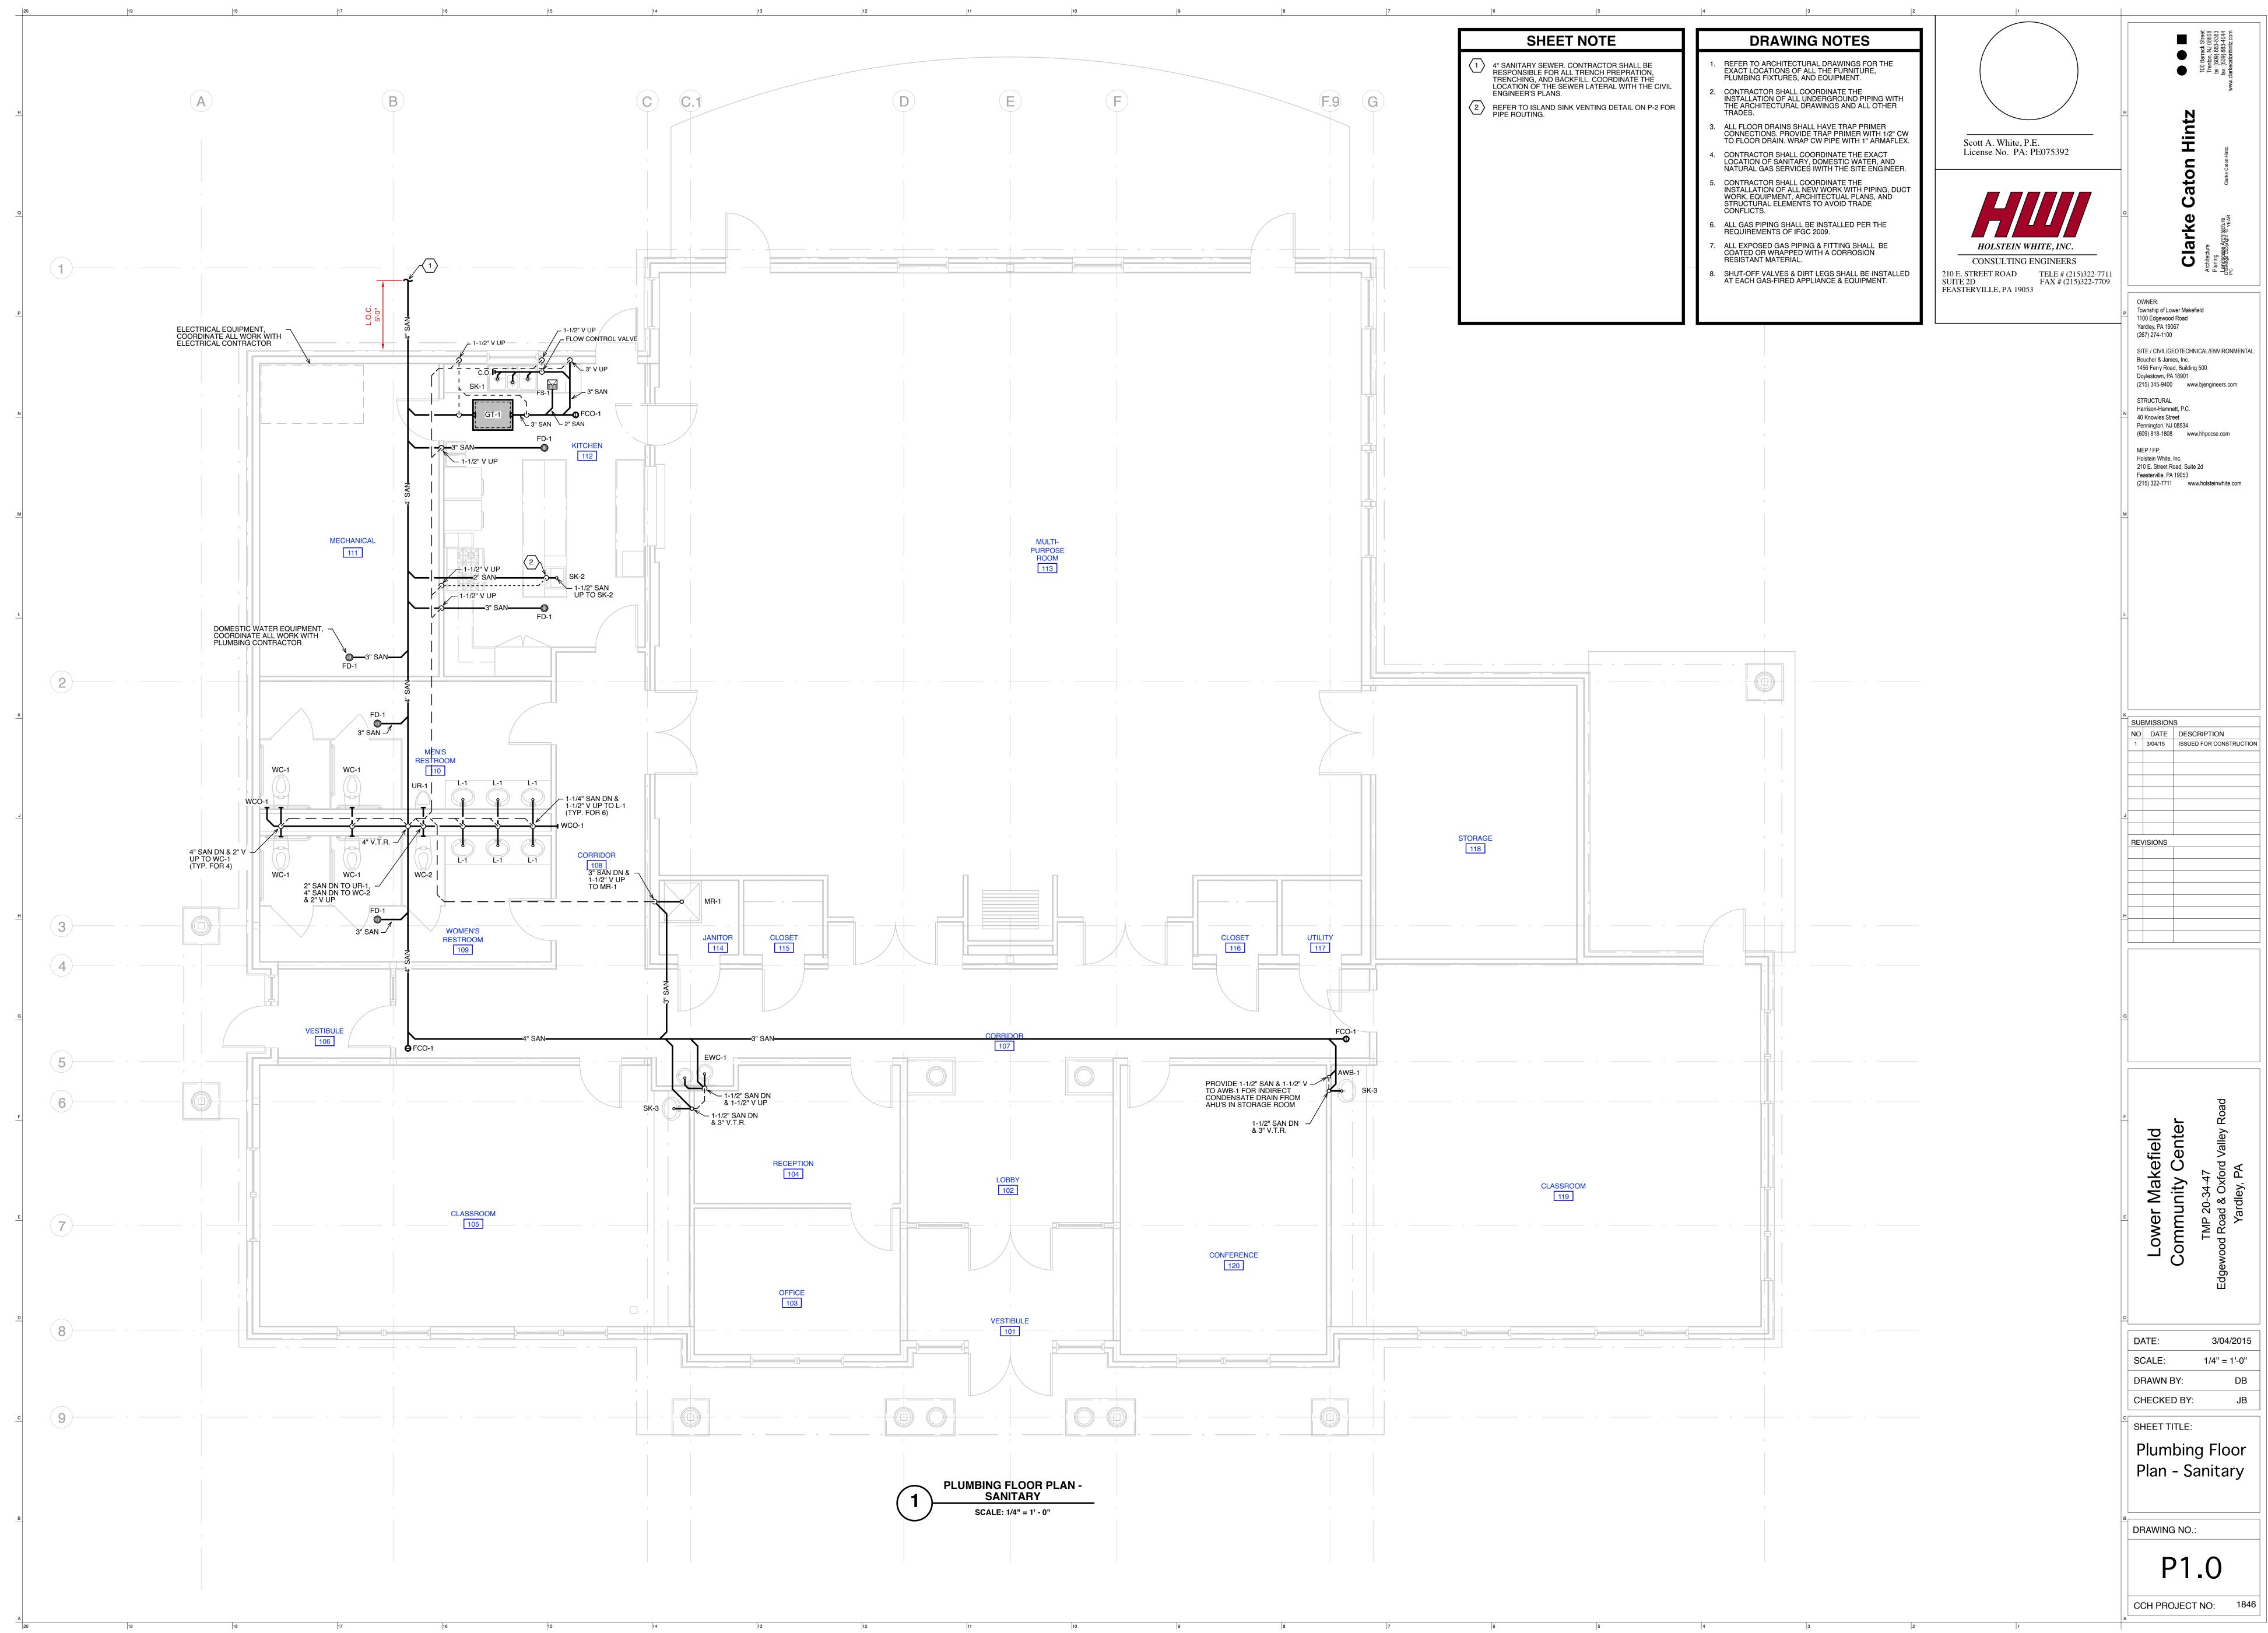

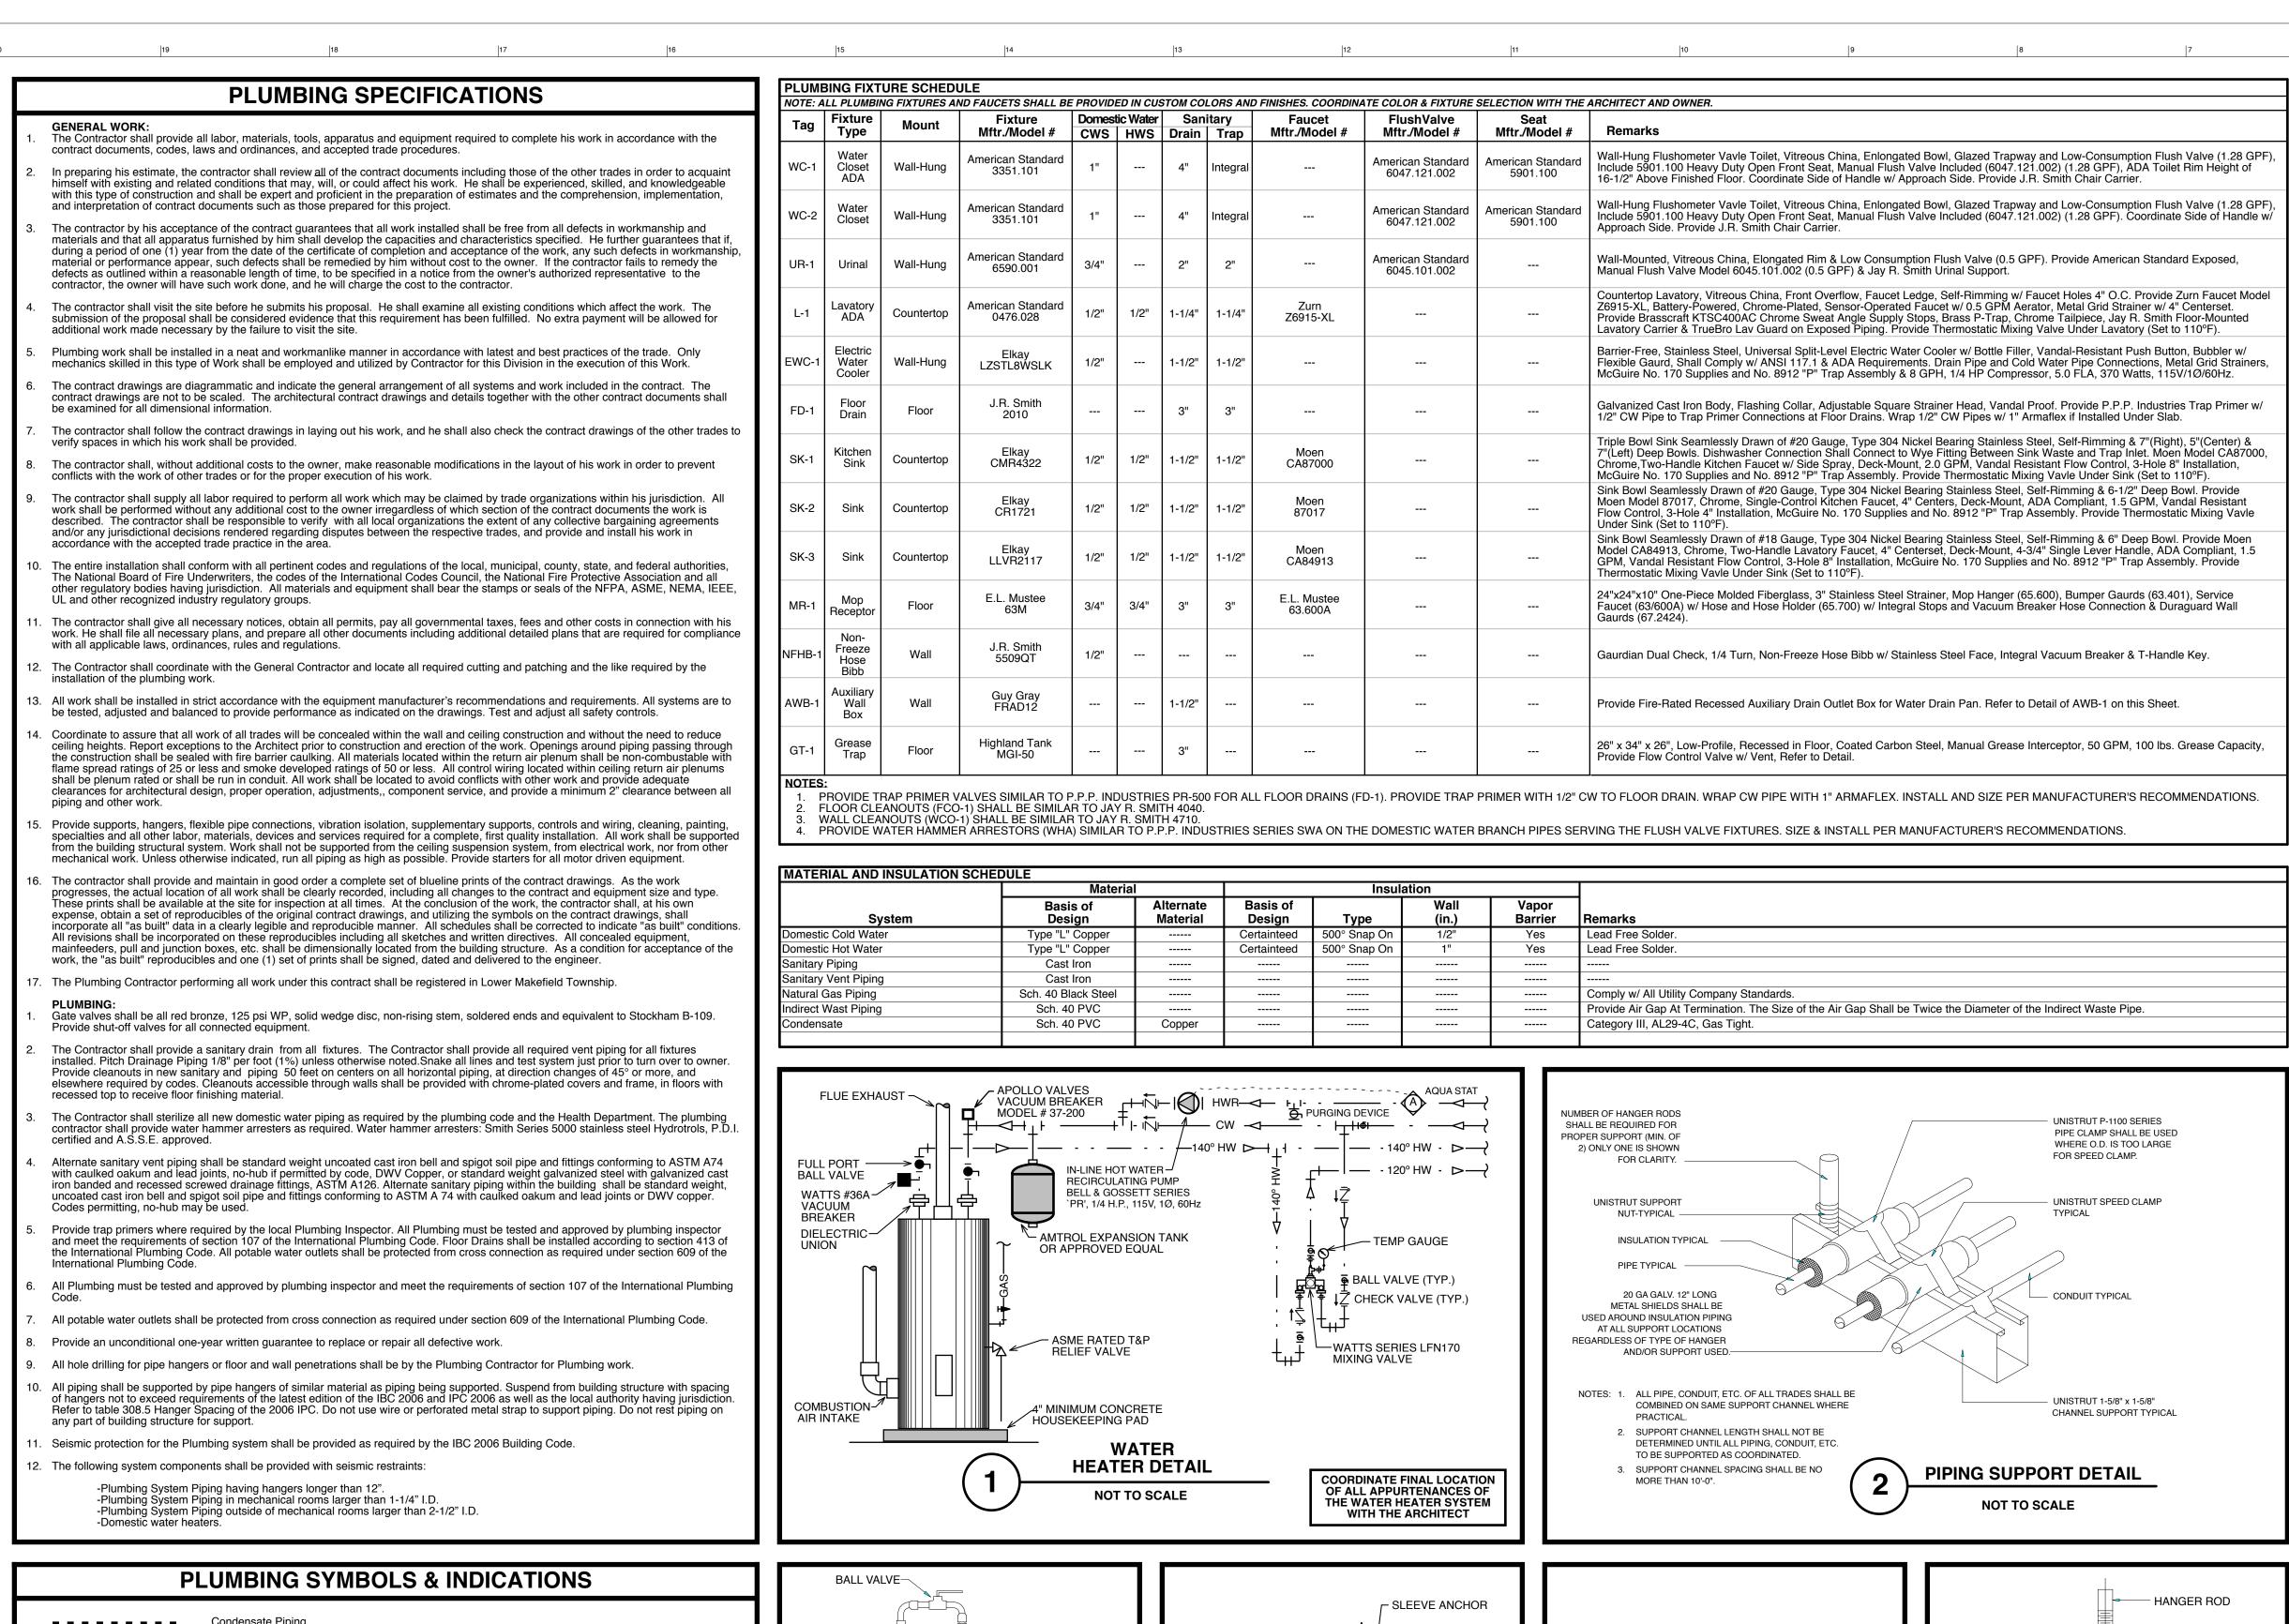TRAP PRIMER

TP-A PPP - #

PR-500 INSTAL

ABOVE CEILIN

BREAKER PORT

FLOOF

 \longrightarrow TO WASTE

TRAP PRIMER DETAIL

- VACUUM

-*DISTRIBUTION UNIT

SLEEVE THROUGH -

CONCRETE WALL

FLOOR (2" LARGEE

SEALING BUSHING

FILL AREA AROUND

INTERIOR —


PIPE WALL / FLOOR

PENETRATION DETAIL

NOT TO SCALE

SLEEVE WITH NON-SHRINKING

GROUT

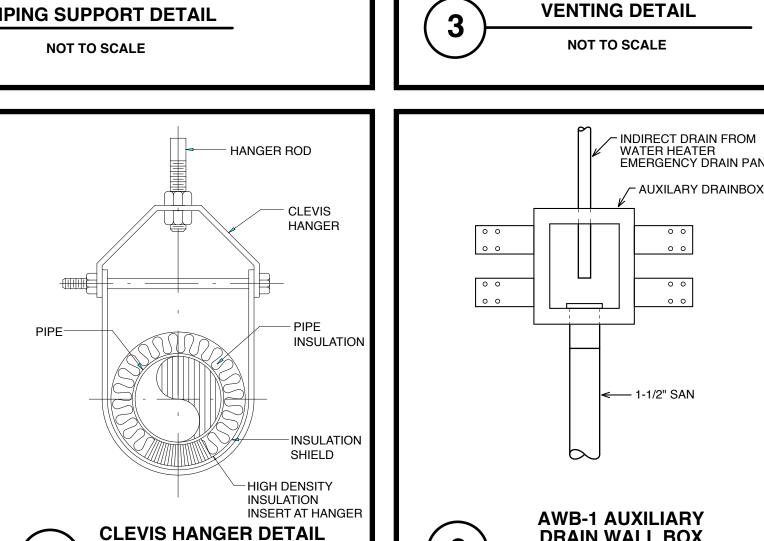


TRAP


2" DRAIN-


COUNTER TOP

TYPICAL ISLAND FIXTURE

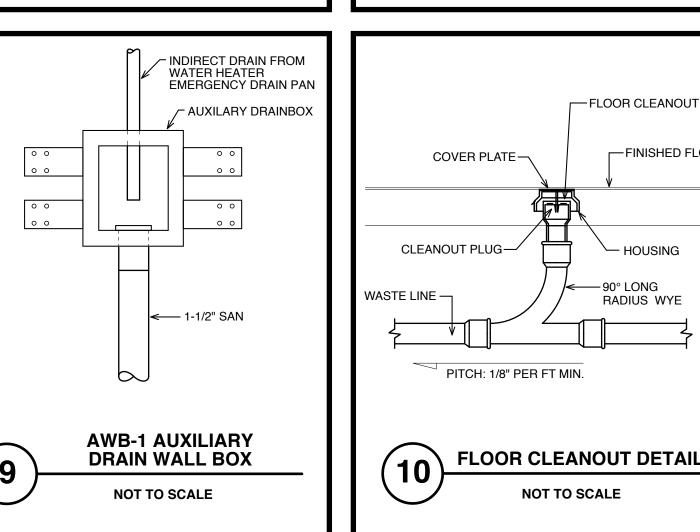

.└─ VFNT

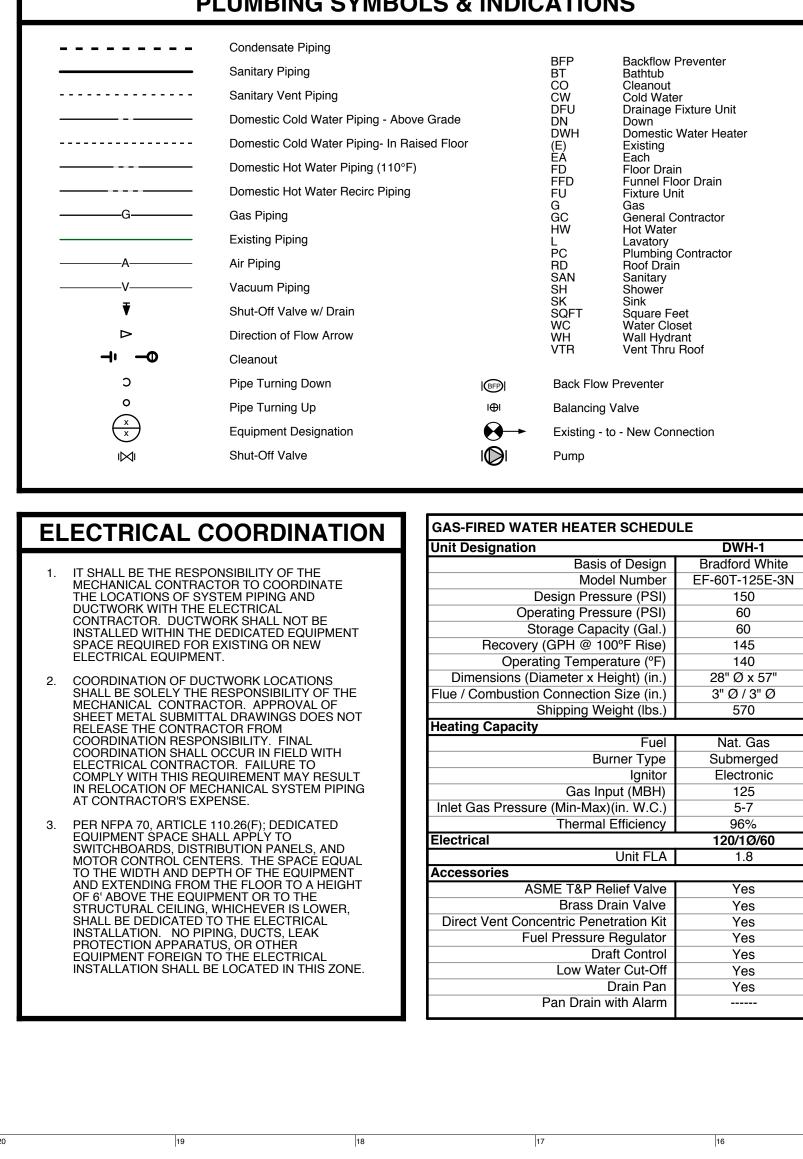

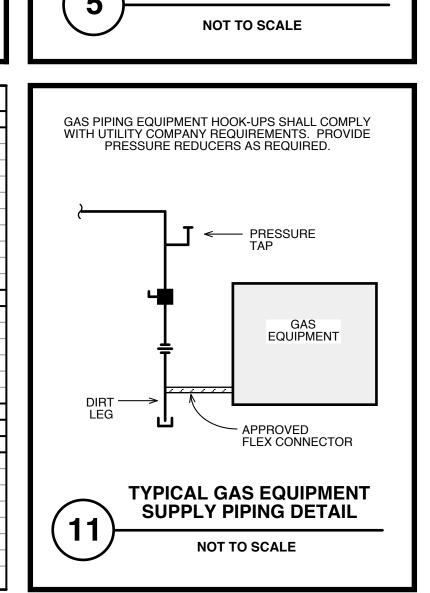


PROVIDE DISTRIBUTION

UNIT AS REQUIRED FOR

MULTIPLE OUTLETS AS

INDICATED ON PLANS

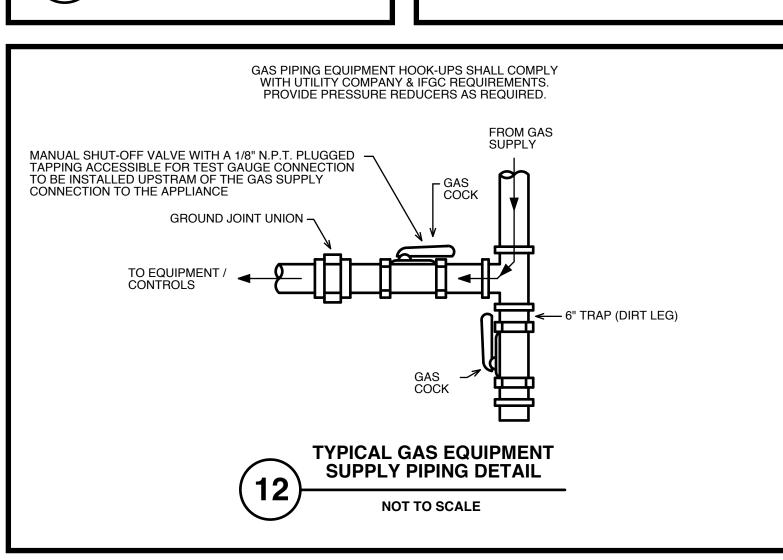

√|<---- WALL / FLOOR

- SFALANT AND

- PIPE THROUGH

BACKER

SLEEVE

NON-FI AMMARI

FILL AROUND


- WALL / FLOOR

- FLOOR DRAIN


TYPICAL FLOOR

DRAIN DETAIL

NOT TO SCALE

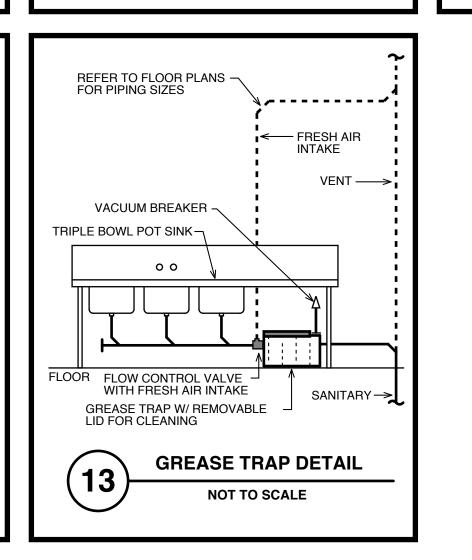

NOT TO SCALE

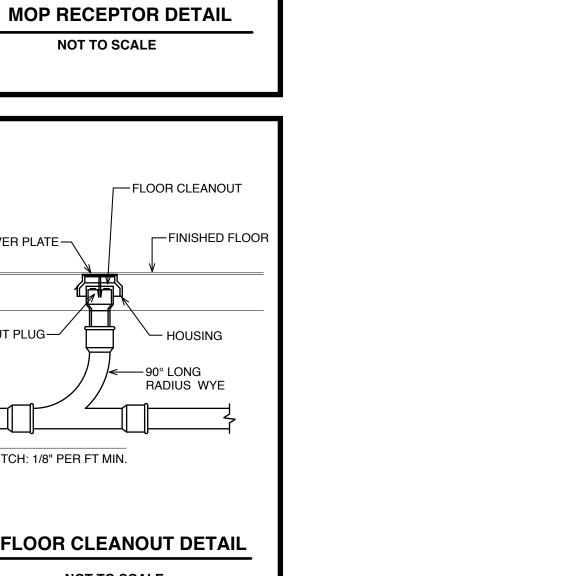

SERVICE FAUCET WITH VACUUM BREAK

<── MOP

─ MOP HANGER

_ _ _ .

- HOSE HOLDER

Scott A. White, P.E.

210 E. STREET ROAD

FEASTERVILLE, PA 19053

SUITE 2D

License No. PA: PE075392

HOLSTEIN WHITE, INC.

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Pennington, NJ 08534

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Holstein White, Inc.

SUBMISSIONS

REVISIONS

NO. DATE DESCRIPTION

1 3/04/15 ISSUED FOR CONSTRUCTION

210 E. Street Road, Suite 2d

Feasterville, PA 19053

STRUCTURAL

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1456 Ferry Road, Building 500

Yardley PA 19067

(267) 274-1100

DATE: 3/04/2015

SCALE: 1/4" = 1'-0"


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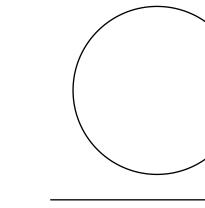
CHECKED BY: JB

Plumbing Schedules and Details

DRAWING NO.:

P2.0



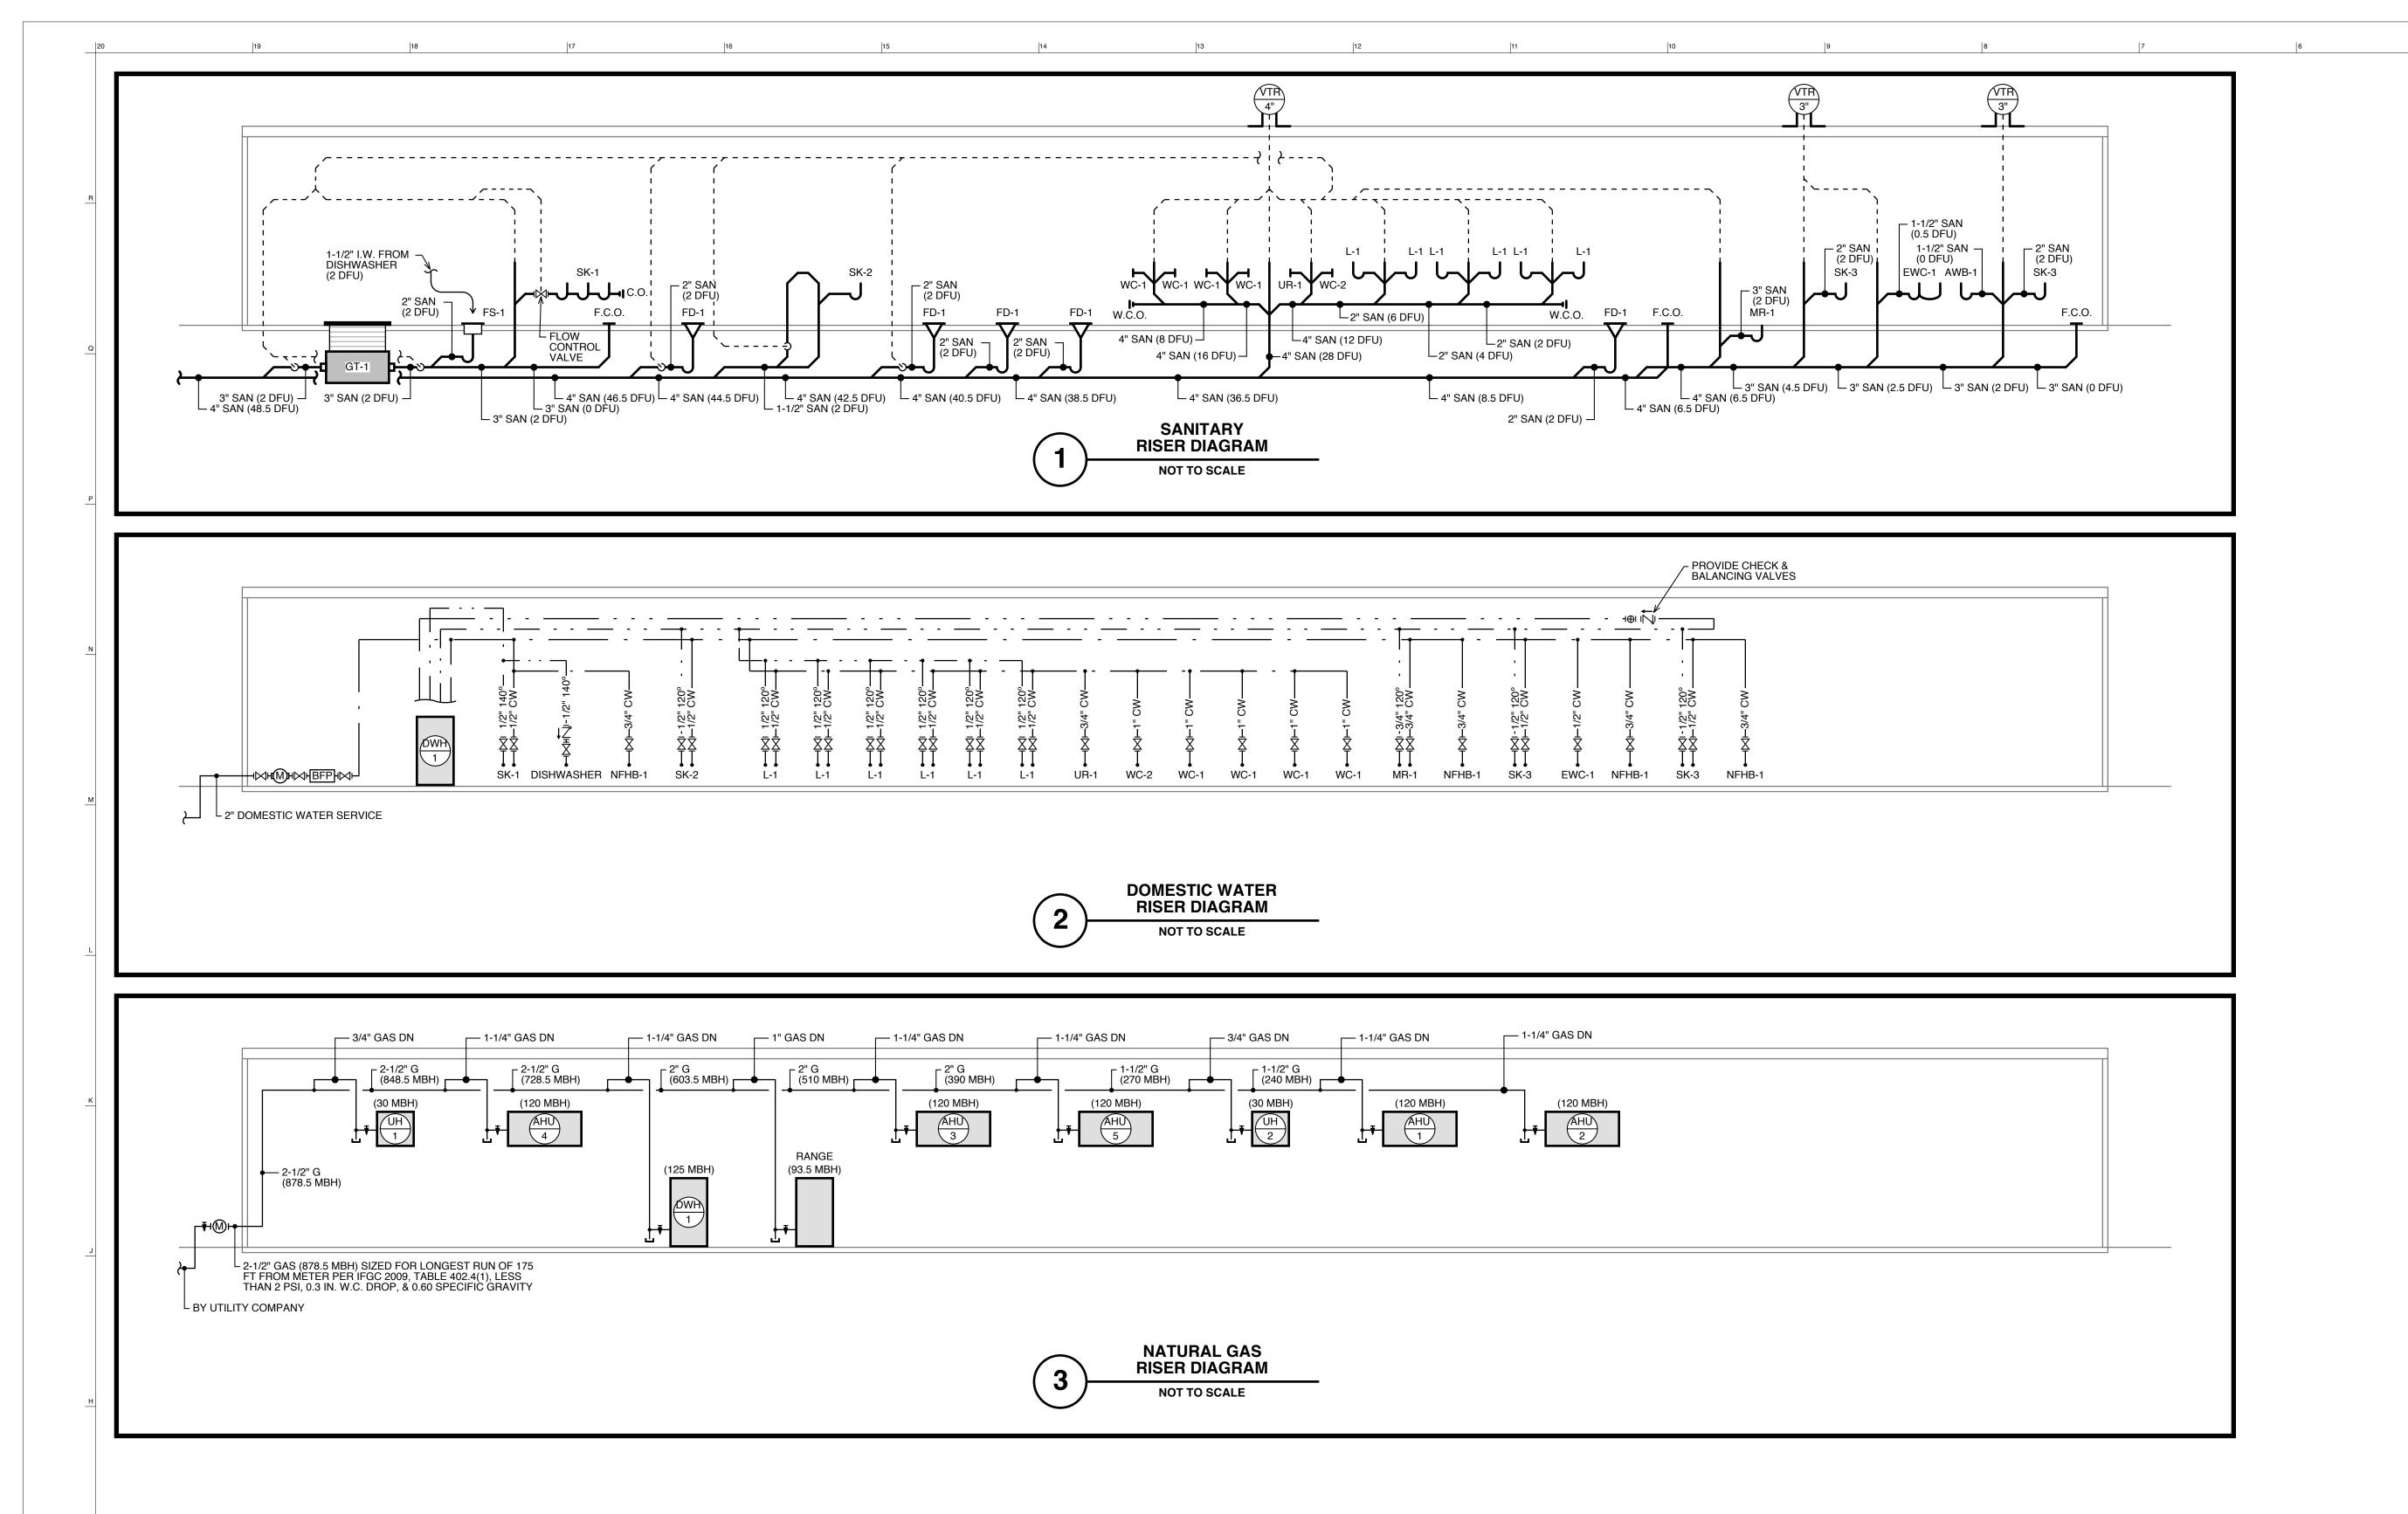

Scott A. White, P.E. License No. PA: PE075392



Clarke Caton Hil

OWNER:
Township of Lower Makefield
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NO. DATE DESCRIPTION

1 3/04/15 ISSUED FOR CONSTRUCTION

REVISIONS

Community Center

TMP 20-34-47

Edgewood Road & Oxford Valley Road
Yardley, PA

DATE: 3/04/2015

SCALE: 1/4" = 1'-0"

DRAWN BY: DB


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SHEET TITLE:

Plumbing Riser Diagrams


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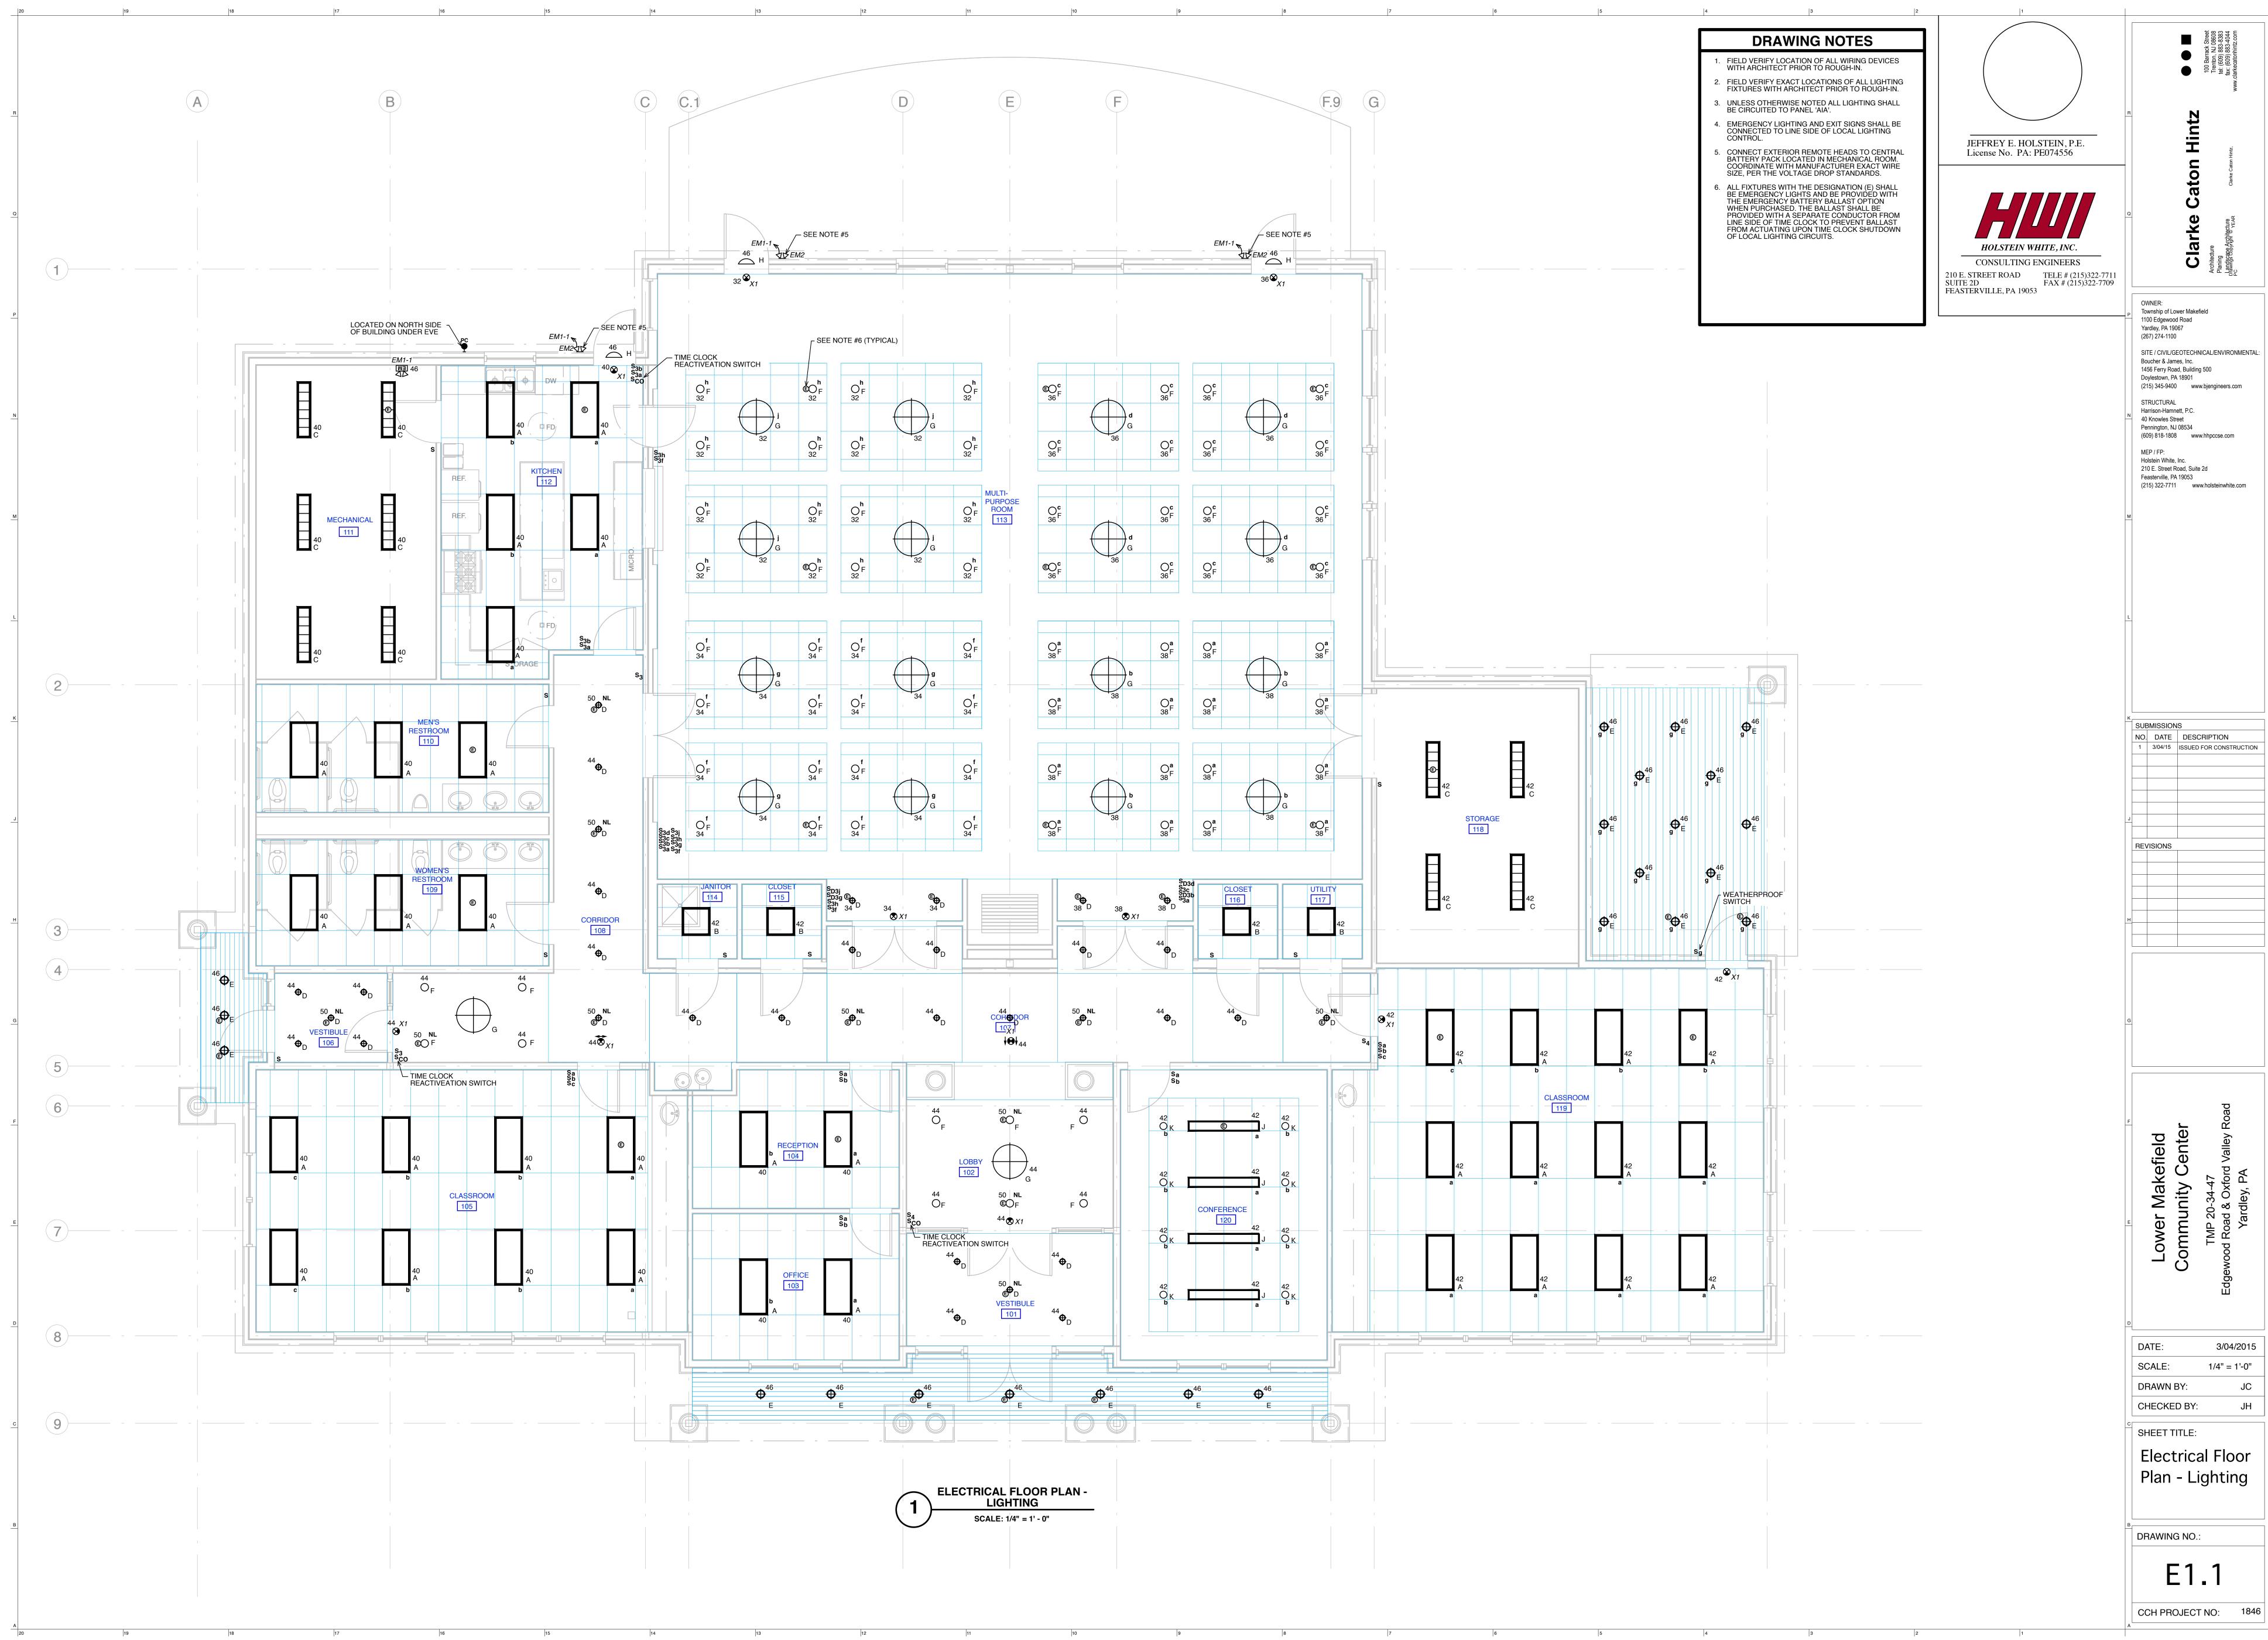
P2.1





3/04/15 ISSUED FOR CONSTRUCTION

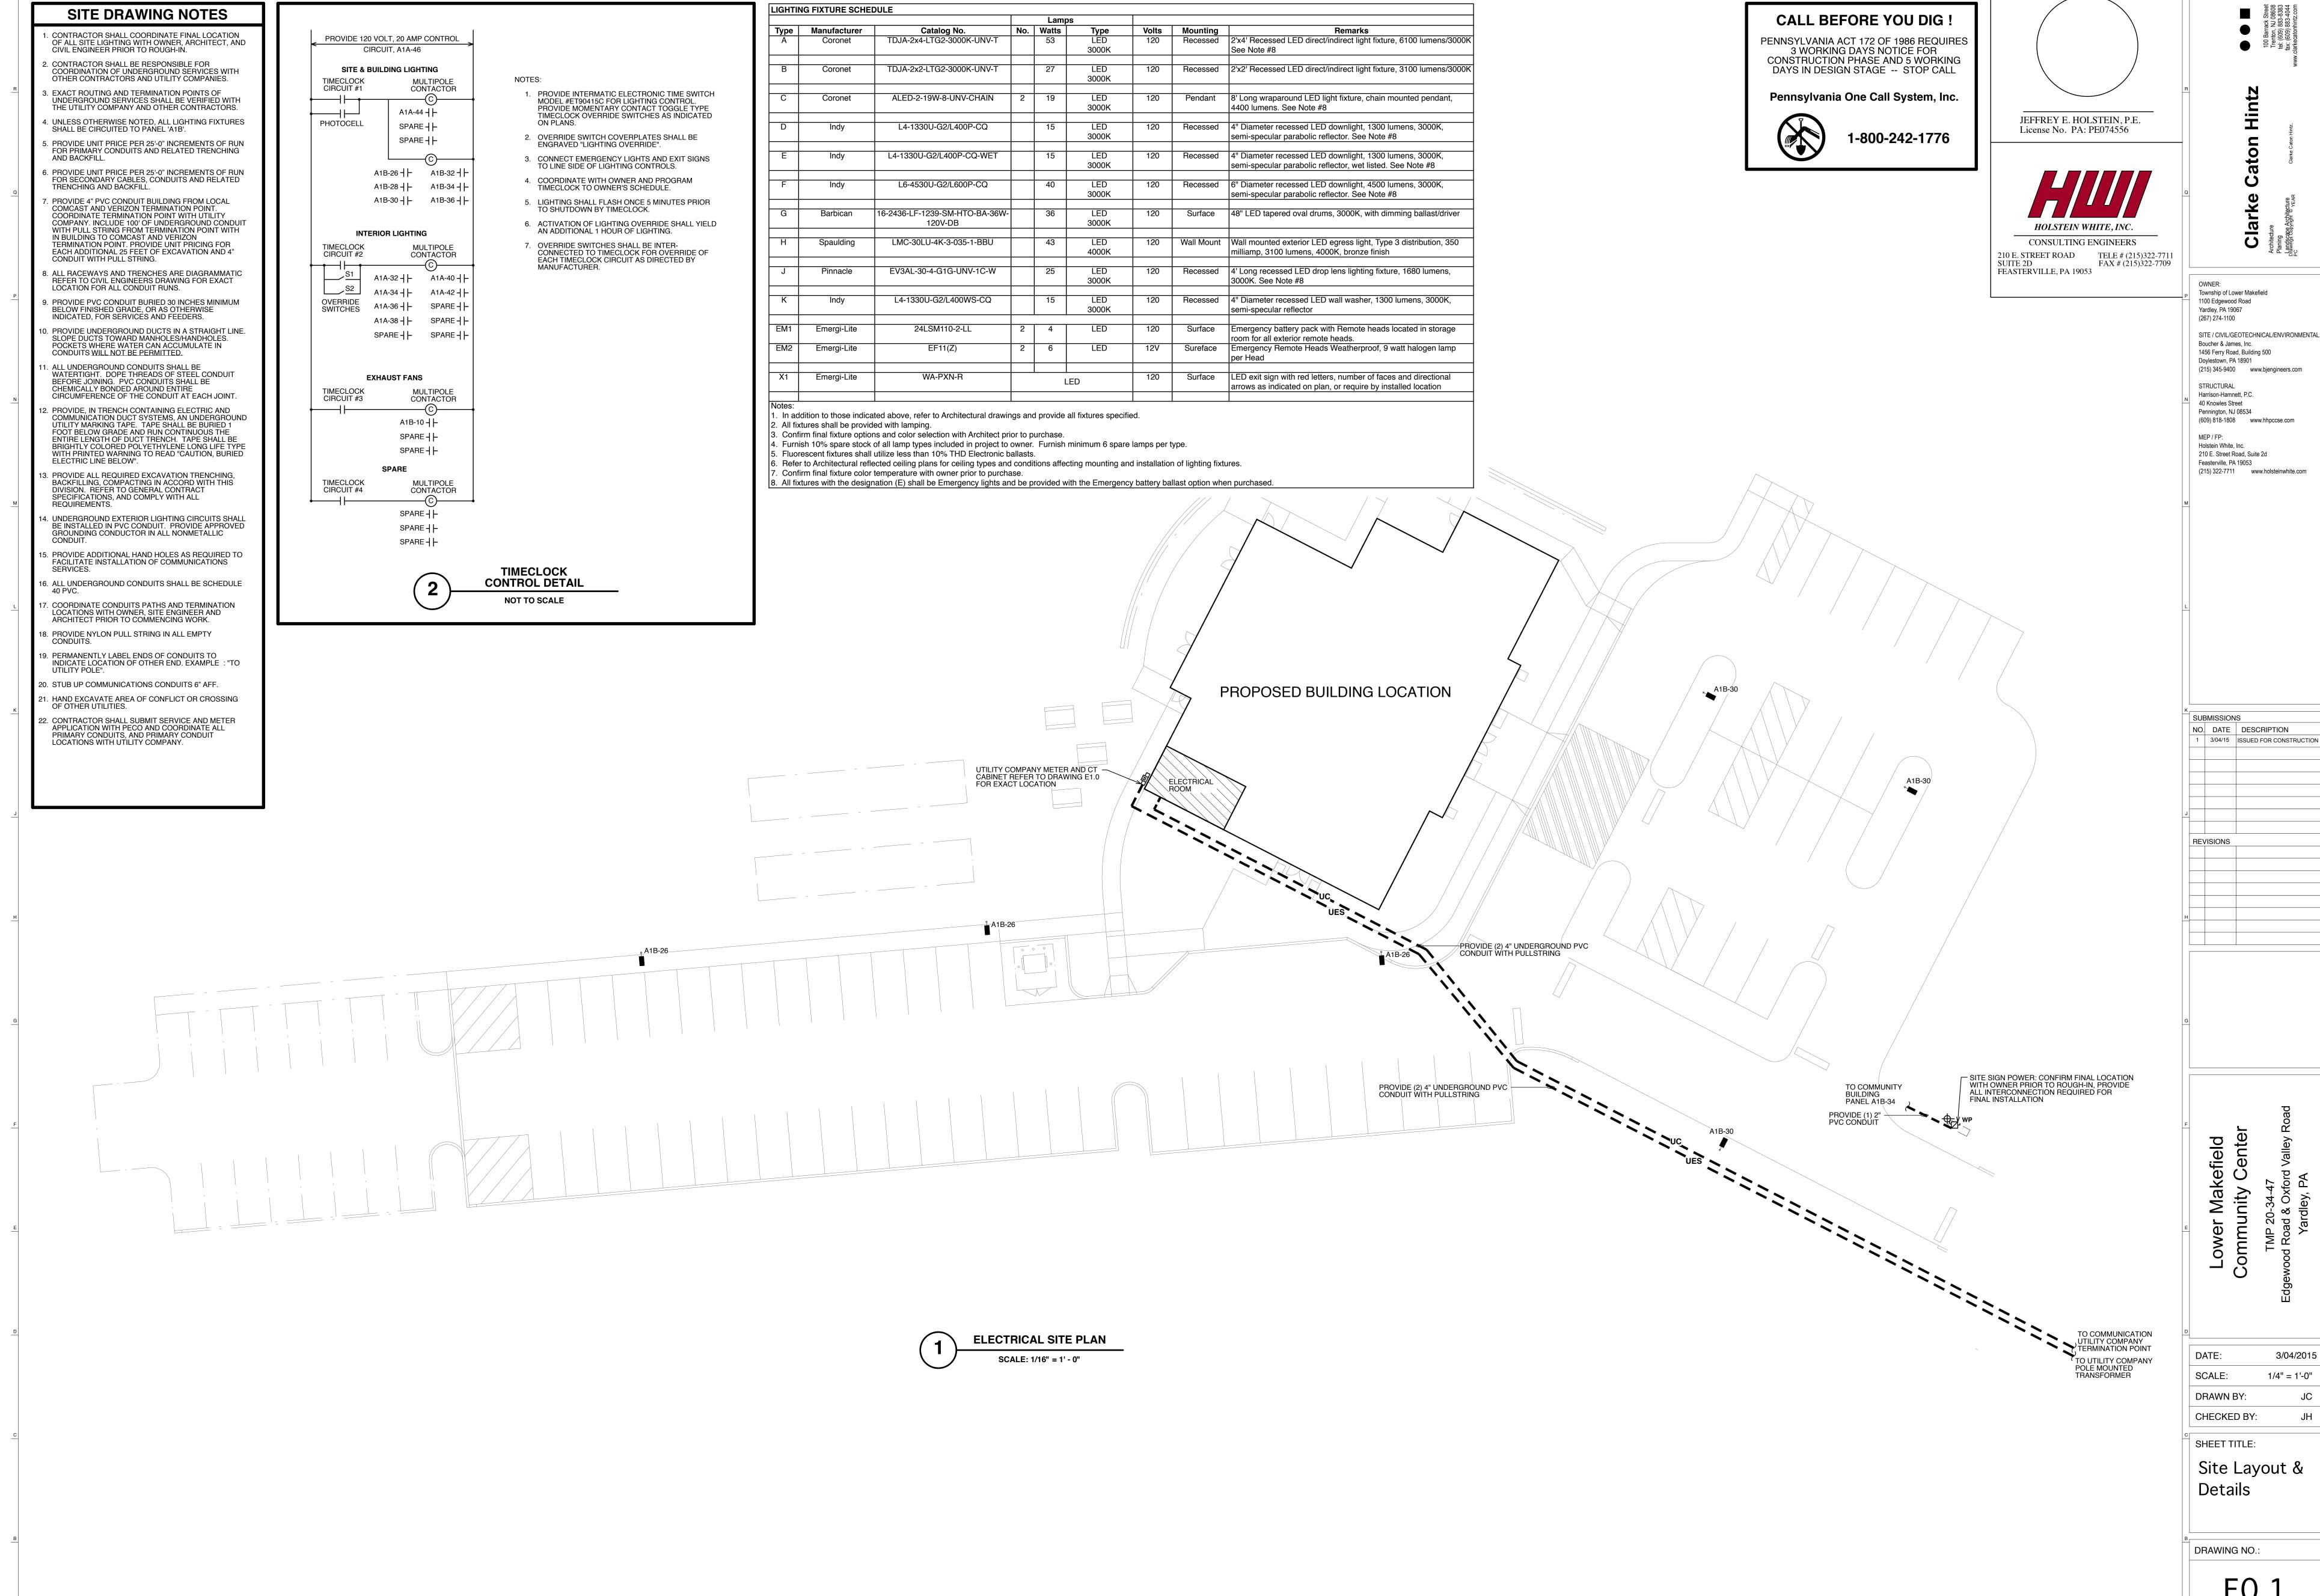
EO.1



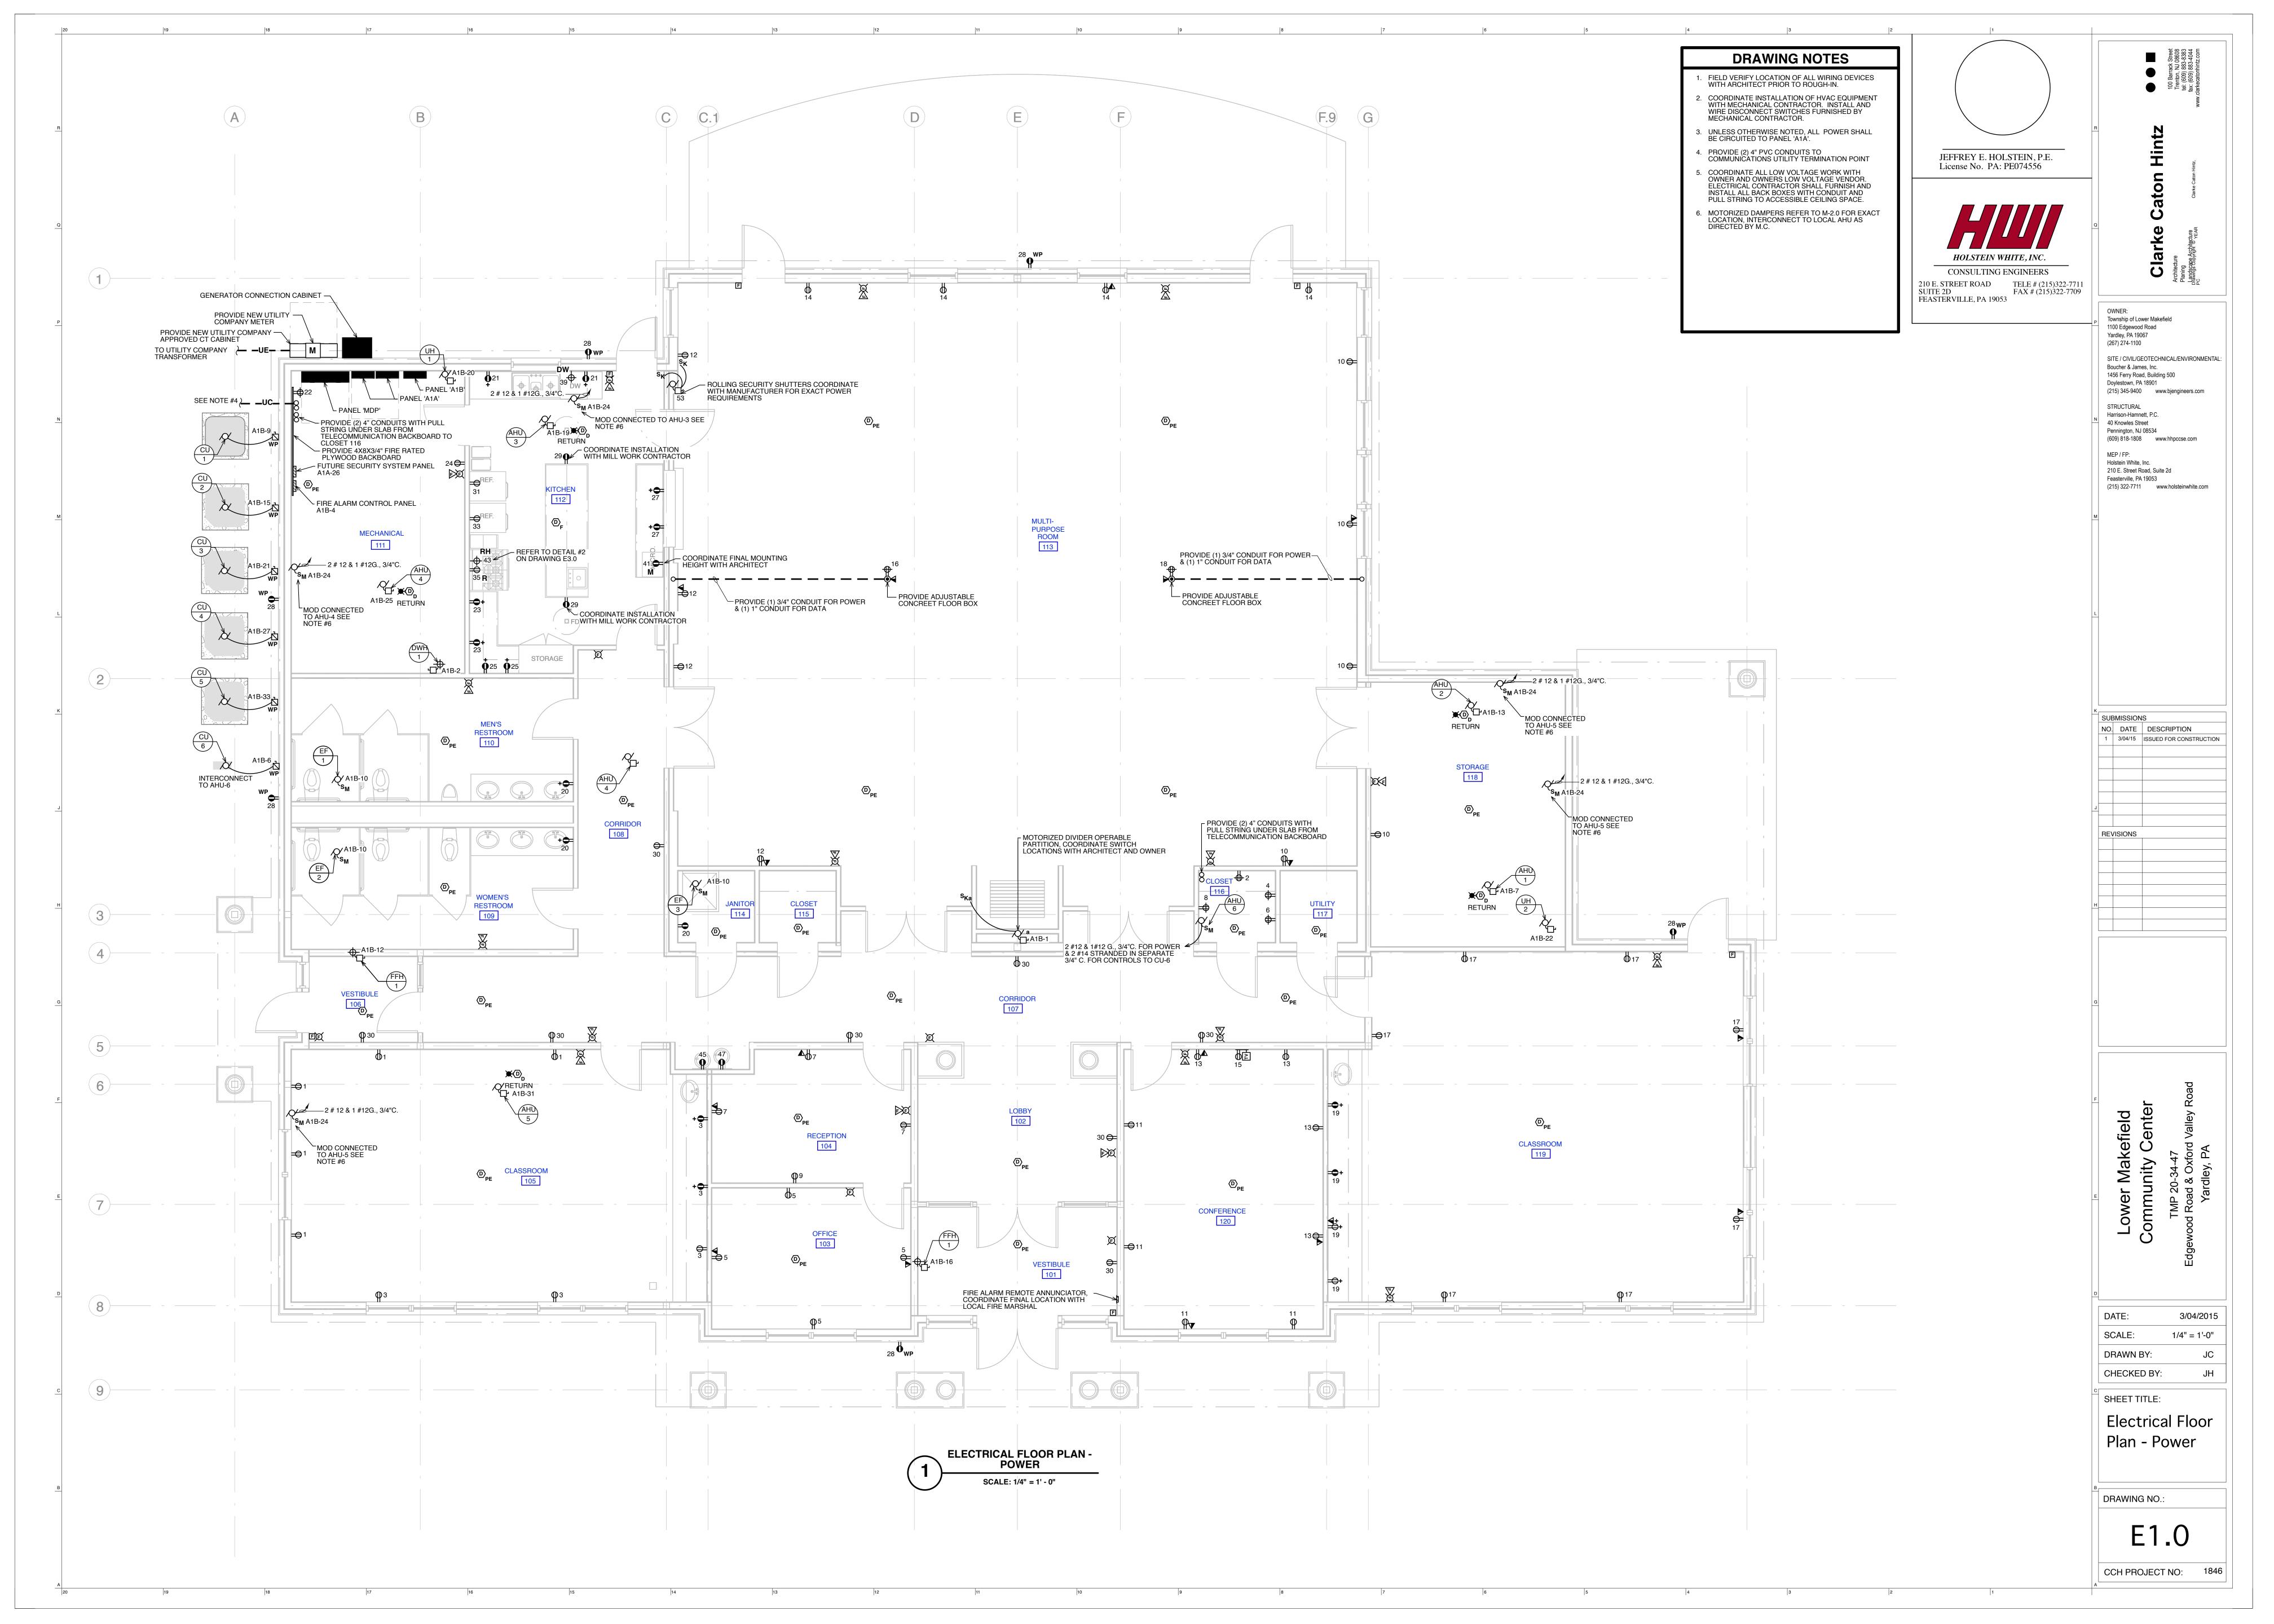

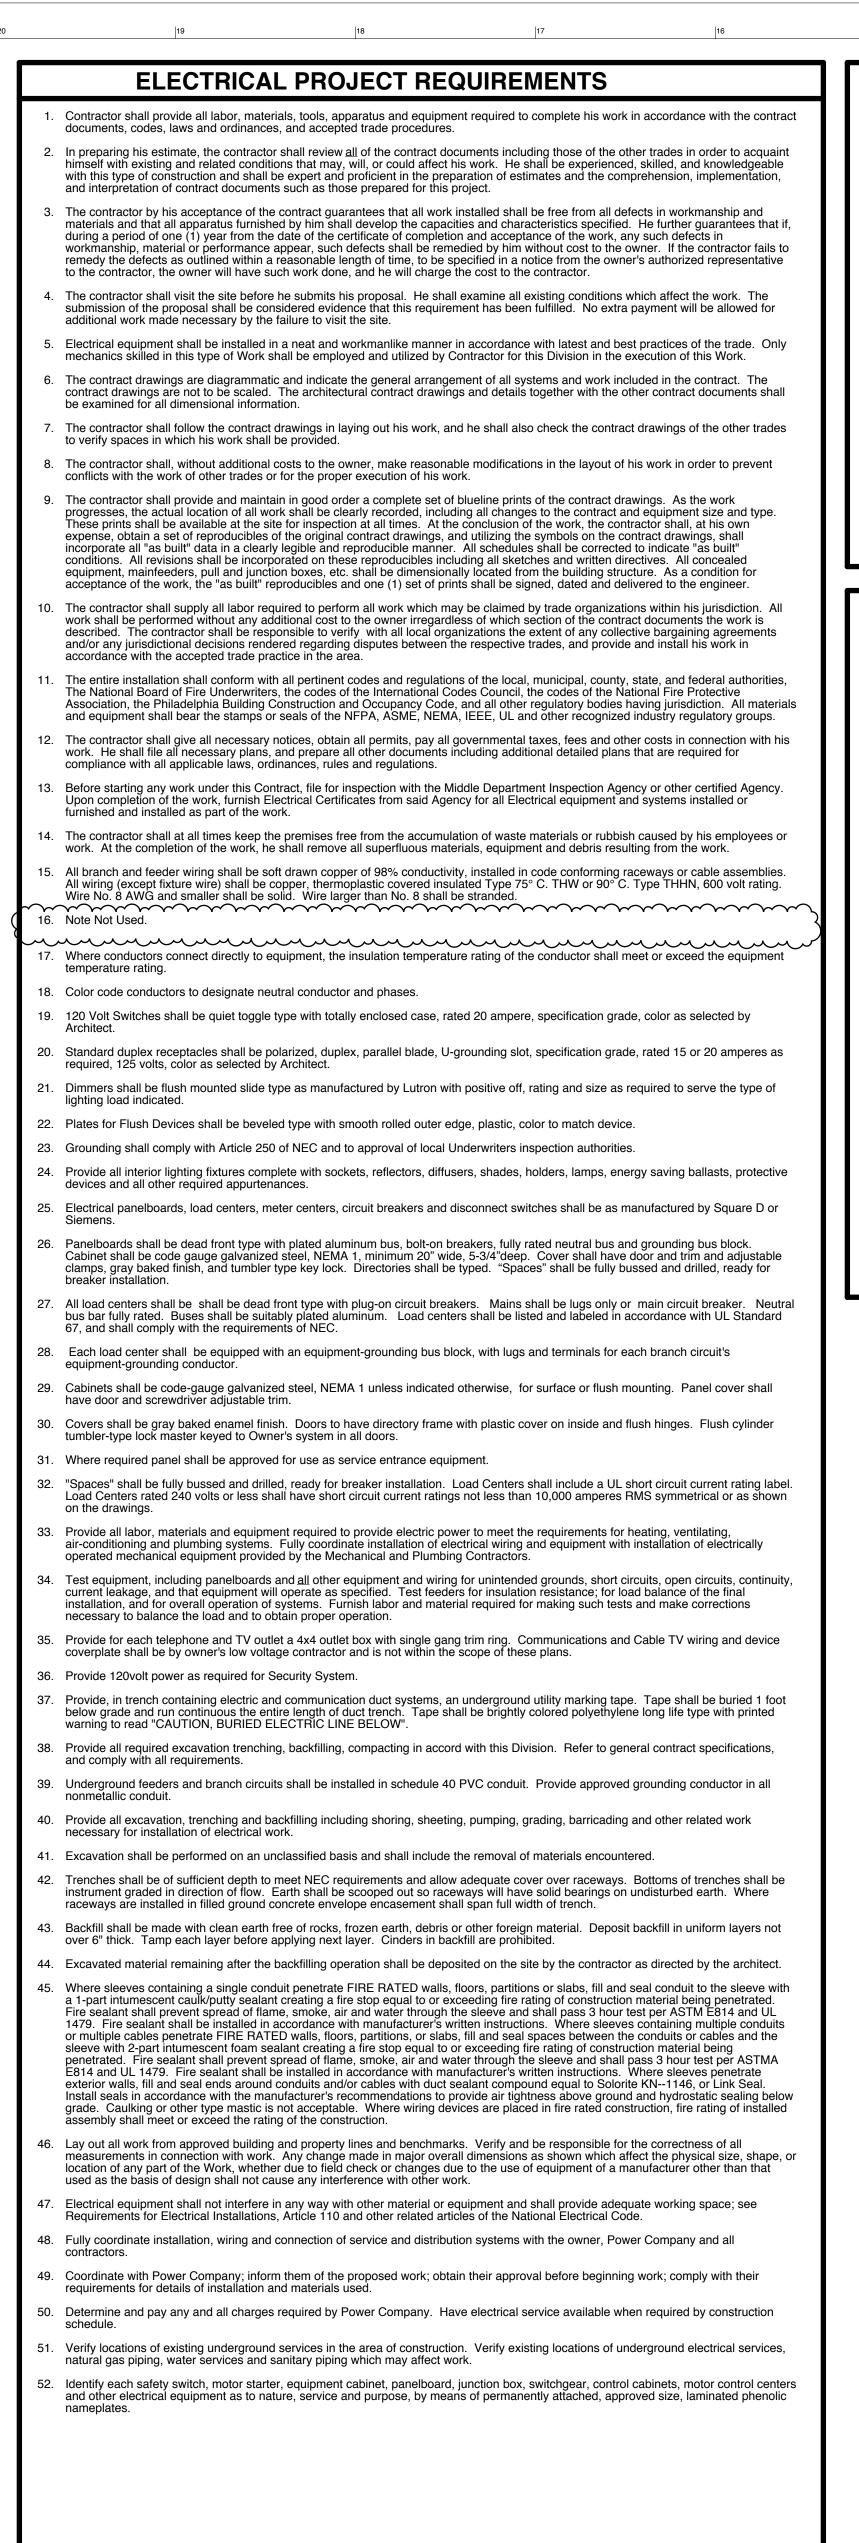

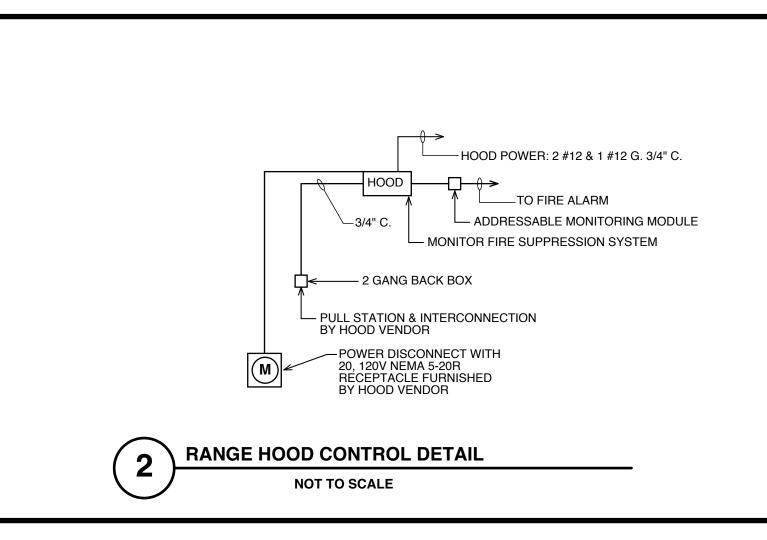

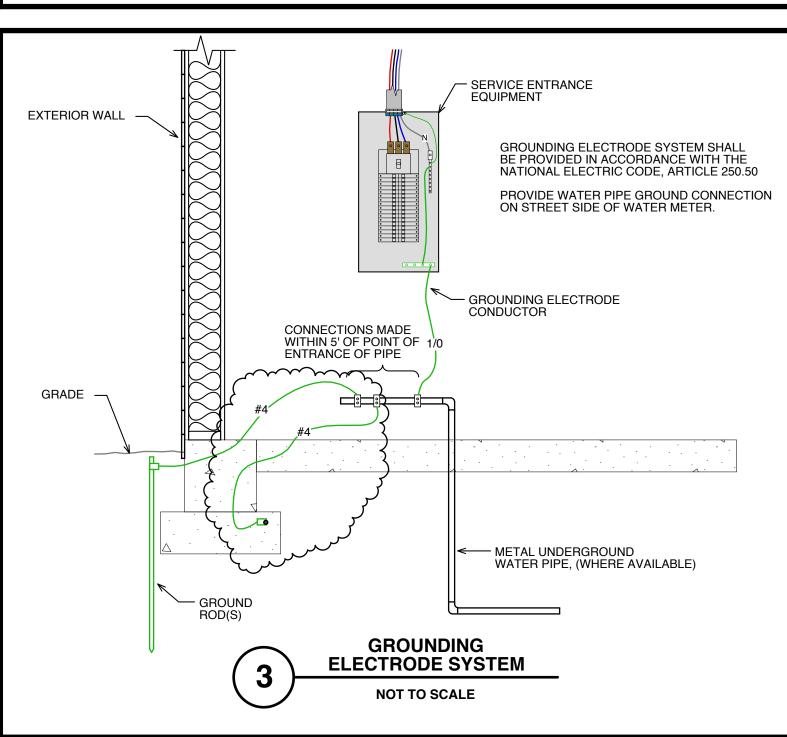

ELECTRICAL STANDARD MOUNTING HEIGHTS Wall-Mounted Clocks, Program Bells, Fire Alarm Gongs and Horns Finished Ceiling 10'-0" Battery Lighting Units and Remote Wall Mounted Lighting Heads (Or 1'-0" Below Finised Ceiling) 8'-6" Pendant Hung Industrial and Strip Lighting Fixtures Door or Window —— Warning and Signaling Fixtures/Signs Fire Alarm Illuminated Flashing Lights (Lowest of the two Heights) Finished Ceiling Top of Flush and Surface Mounted Electrical Panelboards and Communication System Cabinets Top of Back-Mounted Wall Exit Signs (Not Mounted Above Doors) — Top of Highest Electrical Safety Disconnect Switches, Magnetic Motor Starters and Contactors Wall Mounted Telephones and Pay Stations (3'-6" at Handicap Locations) Fire Alarm Pull Stations 3'-4" Wall Mounted Electrical Device Lighting Switches Electrical Receptacles in Mechanical Spaces, Electrical and Elevator Rooms Electrical Receptacles, Television Outlets, Telephone Outlets, and Computer Outlets Finished Floor Mounting Heights to center of outlets unless otherwise noted. In masonry construction the mounting heights shall be used for reference to the nearest block or brick coursing The above mounting heights shall be adhered to unless specifically noted or detailed on the Architectural drawings or **ELECTRICAL SYMBOLS** SINGLE LINE DIAGRAM NOTES

UNLESS OTHERWISE NOTED, ALL DEVICES AND

UNLESS OTHERWISE NOTED, ALL CONDUCTORS SHALL BE COPPER, TYPE THW, RATED 75°C.

UNLESS OTHERWISE NOTED, ALL CONDUIT SHALL

PANEL BOARDS AND SWITCHBOARD SHALL BE AS

BRANCH CIRCUIT PANEL SHALL BE AS MANUFACTURED BY SQUARE D, TYPE NQ MAIN

CIRCUIT BREAKER SERIES RATED PANELBOARD.

PANEL 'MDP' SHALL BE AS MANUFACTURED BY

SQUARE D, TYPE L-LINE, OR APPROVED EQUAL.

COORDINATE WITH PECO AND ROUTE SERVICE CONDUCTORS TO SECONDARY OF TRANSFORMER

KEY INTERLOCK SHALL PREVENT SIMULTANEOUS


CLOSING OF INDICATED BREAKERS.

ALL EQUIPMENT SHALL BE SERIES RATED TO


WITHSTAND THE AVAILABLE SHORT CIRCUIT


MANUFACTURED BY SQUARE D.


SPACES ARE 3 POLE.

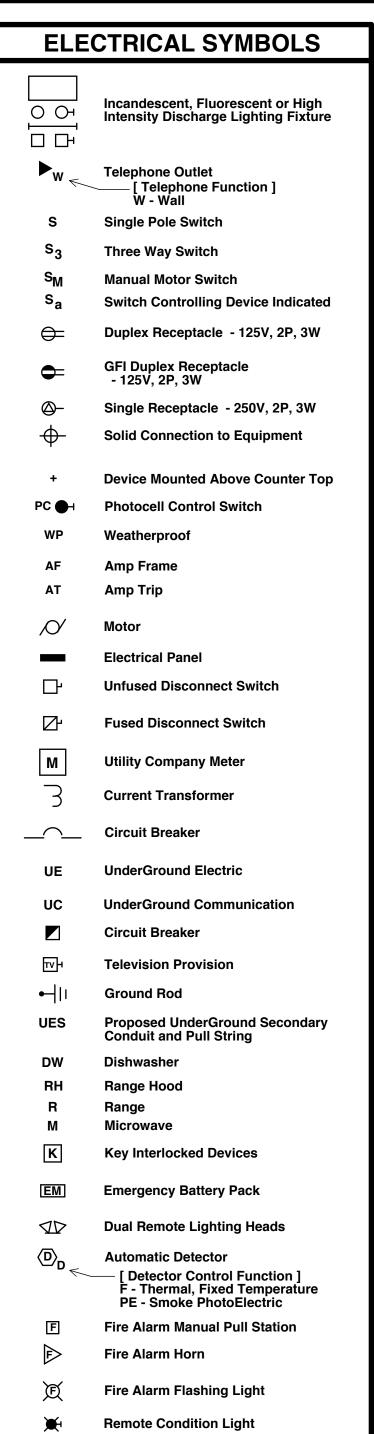


Concrete Floor Box

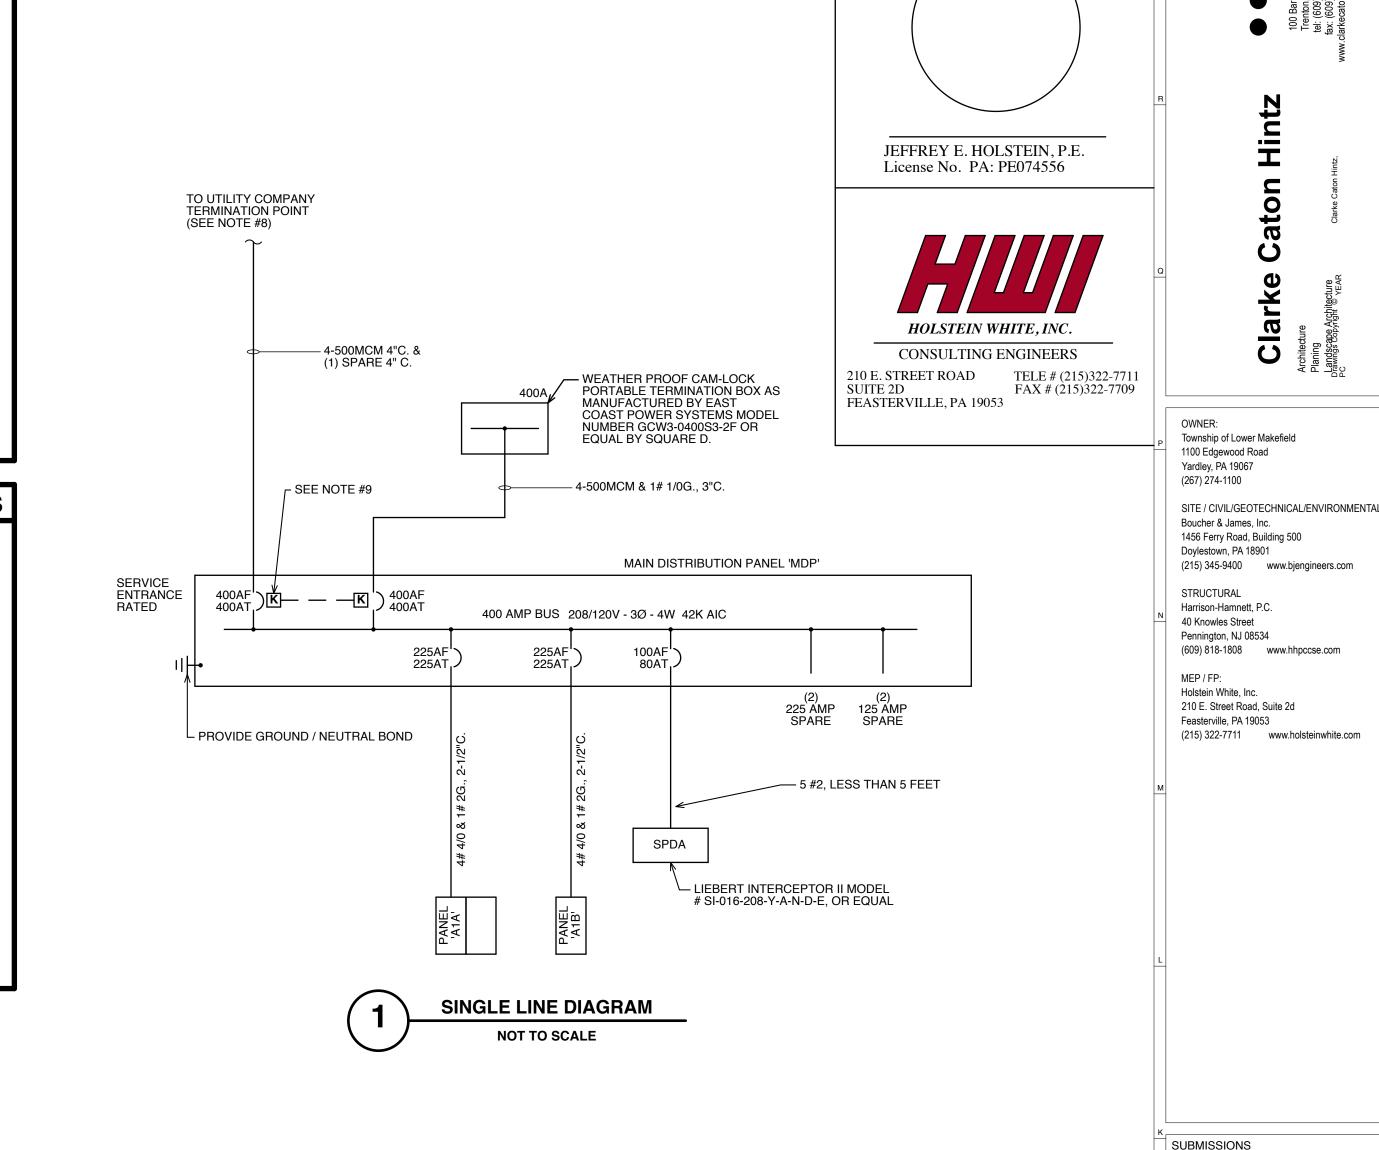

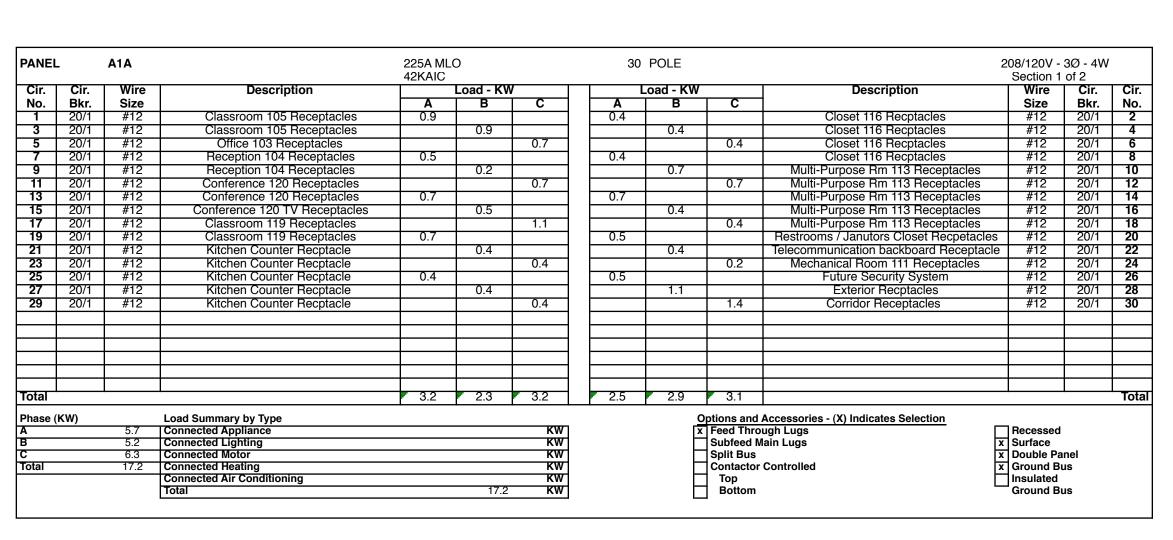

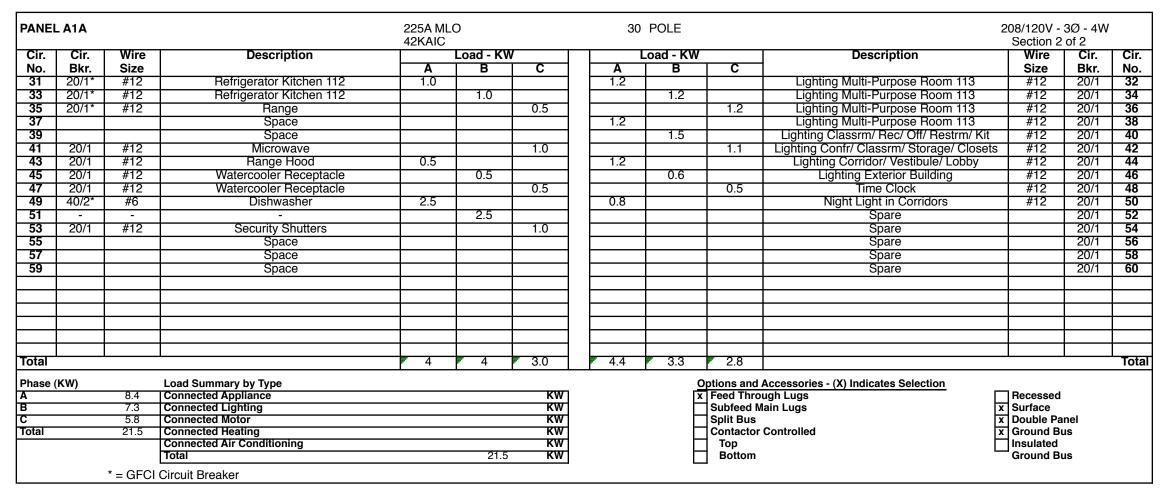

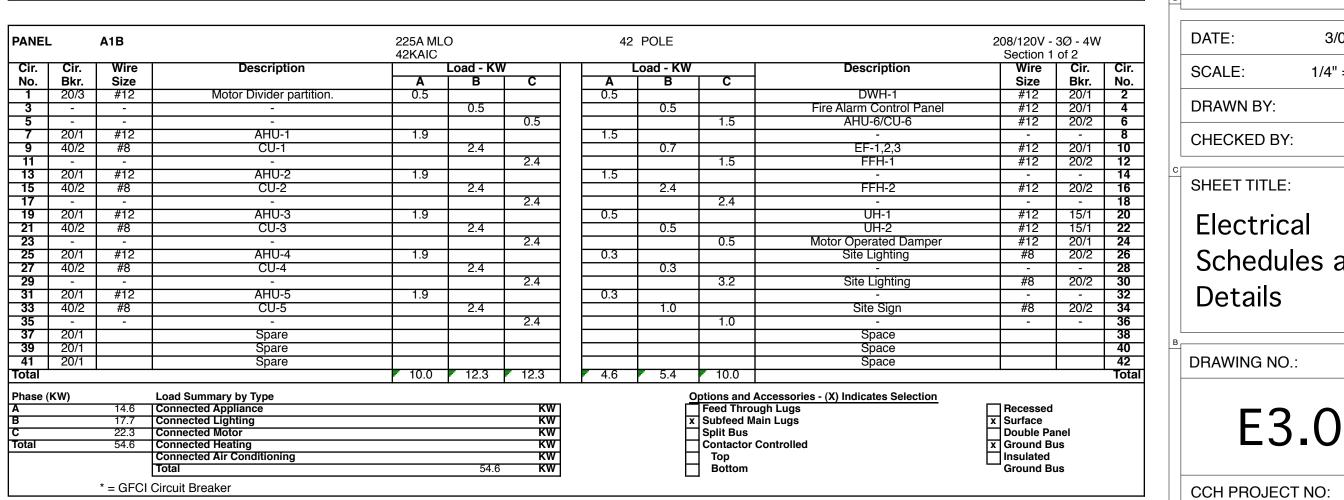

TOWER Makefield

Community Center

Table 20-34-47

DATE: 3/04/2015

Community Center

Table 20-34-47

Landley, PA

Yardley, PA

Sheet title:

Electrical

Schedules and

Details